



SYRACUSE DIVISION
PLANS FOR
REHABILITATION
OF THE
I-90 EB and I-90 WB BRIDGES OVER STERLING CREEK
AT
MILEPOST 227.40 & 227.41
IN
HERKIMER COUNTY

TAS 24-5B D214950

87 SHEETS BIN'S 5516092 & 5516091

TYPE OF CONSTRUCTION:
BRIDGE REHABILITATION AT MP 227.40 AND MP 227.41

STANDARD SHEETS:
THE LATEST REVISIONS OF THE STANDARD SHEETS MAINTAINED BY NYS DOT, WHICH ARE CURRENT AS OF THE STANDARD SPECIFICATIONS ADOPTION DATE SHOWN ON THE PROPOSAL COVER SHALL BE CONSIDERED TO BE IN EFFECT. ALL PAY ITEMS AND WORK CONTAINED IN THE CONTRACT AND ANY ADDITIONAL PAY ITEMS AND WORK ENCOUNTERED DURING THE COURSE OF THE CONTRACT SHALL BE SUBJECT TO THE APPLICABLE STANDARD SHEET(S) UNLESS OTHERWISE SPECIFIED IN THE CONTRACT DOCUMENTS.

THE LATEST REVISIONS OF THE NYSTA STANDARD SHEETS MAINTAINED BY THE AUTHORITY, WHICH ARE CURRENT ON THE DATE OF ADVERTISEMENT FOR BIDS, SHALL BE CONSIDERED TO BE IN EFFECT. ALL PAY ITEMS AND WORK CONTAINED IN THE CONTRACT AND ANY ADDITIONAL PAY ITEMS AND WORK ENCOUNTERED DURING THE COURSE OF THE CONTRACT SHALL BE SUBJECT TO THE APPLICABLE STANDARD SHEET(S) LISTED ON DWG, SS-1 UNLESS OTHERWISE SPECIFIED IN THE CONTRACT DOCUMENTS

BRIDGE MAINTENANCE GUIDELINES

UPON COMPLETION OF THIS PROJECT, THE BRIDGE STRUCTURES REPAIRED, REHABILITATED OR RECONSTRUCTED HEREUNDER SHALL BE MAINTAINED IN ACCORDANCE WITH THE CURRENT AASHTO MANUAL FOR BRIDGE MAINTENANCE, AND THE NEW YORK STATE THRUWAY AUTHORITY MAINTENANCE DIRECTIVES:
BRIDGE MANAGEMENT PROGRAM MD 05-16, BRIDGE MANAGEMENT ACTIVITIES MD 05-3, AND BRIDGE INSPECTION PROGRAM MD 95-5.
SPECIAL MAINTENANCE REQUIREMENTS: NONE

NOTES:

ALL WORK CONTEMPLATED UNDER THIS CONTRACT IS TO BE COVERED BY AND IN CONFORMITY WITH THE STANDARD SPECIFICATIONS (US CUSTOMARY) REFERENCED IN THE CONTRACT "PROPOSAL" EXCEPT AS MODIFIED BY THESE PLANS OR CHANGES SET FORTH IN THE CONTRACT "PROPOSAL".

MAINTENANCE JURISDICTION

100% MUNICIPALITY
N/A

100% AUTHORITY
ALL OTHER BRIDGE ELEMENTS NOT LISTED ABOVE.

LOAD RATING TABLE

CONTROLLING MEMBER	INVENTORY LOAD RATING	OPERATING LOAD RATING
EXTERIOR STRINGER	HS 25 (44 TONS US)	HS 41 (74 TONS US)
EXTERIOR STRINGER (LRFR)	1.12	1.45


HL-93 LIVE LOADING, LRFR AND HS 20 LIVE LOADING, LFD.
INCLUDES FUTURE WEARING COURSE OF 0.020 ksf.

	PROJECT LIMITS		CONTRACT LIMITS	
	FROM STA.	TO STA.	FROM MP	TO MP
MAINLINE I-90	WB 7+50 EB 7+30	WB 13+65 EB 13+30	227.39 227.40	227.41 227.42

UDIG NEW YORK
UNDERGROUND FACILITIES PROTECTION ORGANIZATION
CALL 811

PREPARED AND RECOMMENDED BY:

Christopher Sichak
ERDMAN ANTHONY ASSOCIATES
CHRISTOPHER SICHAK, P.E.
NYS LICENSE NUMBER - 084524
DATE 11/08/2023
ERDMAN ANTHONY

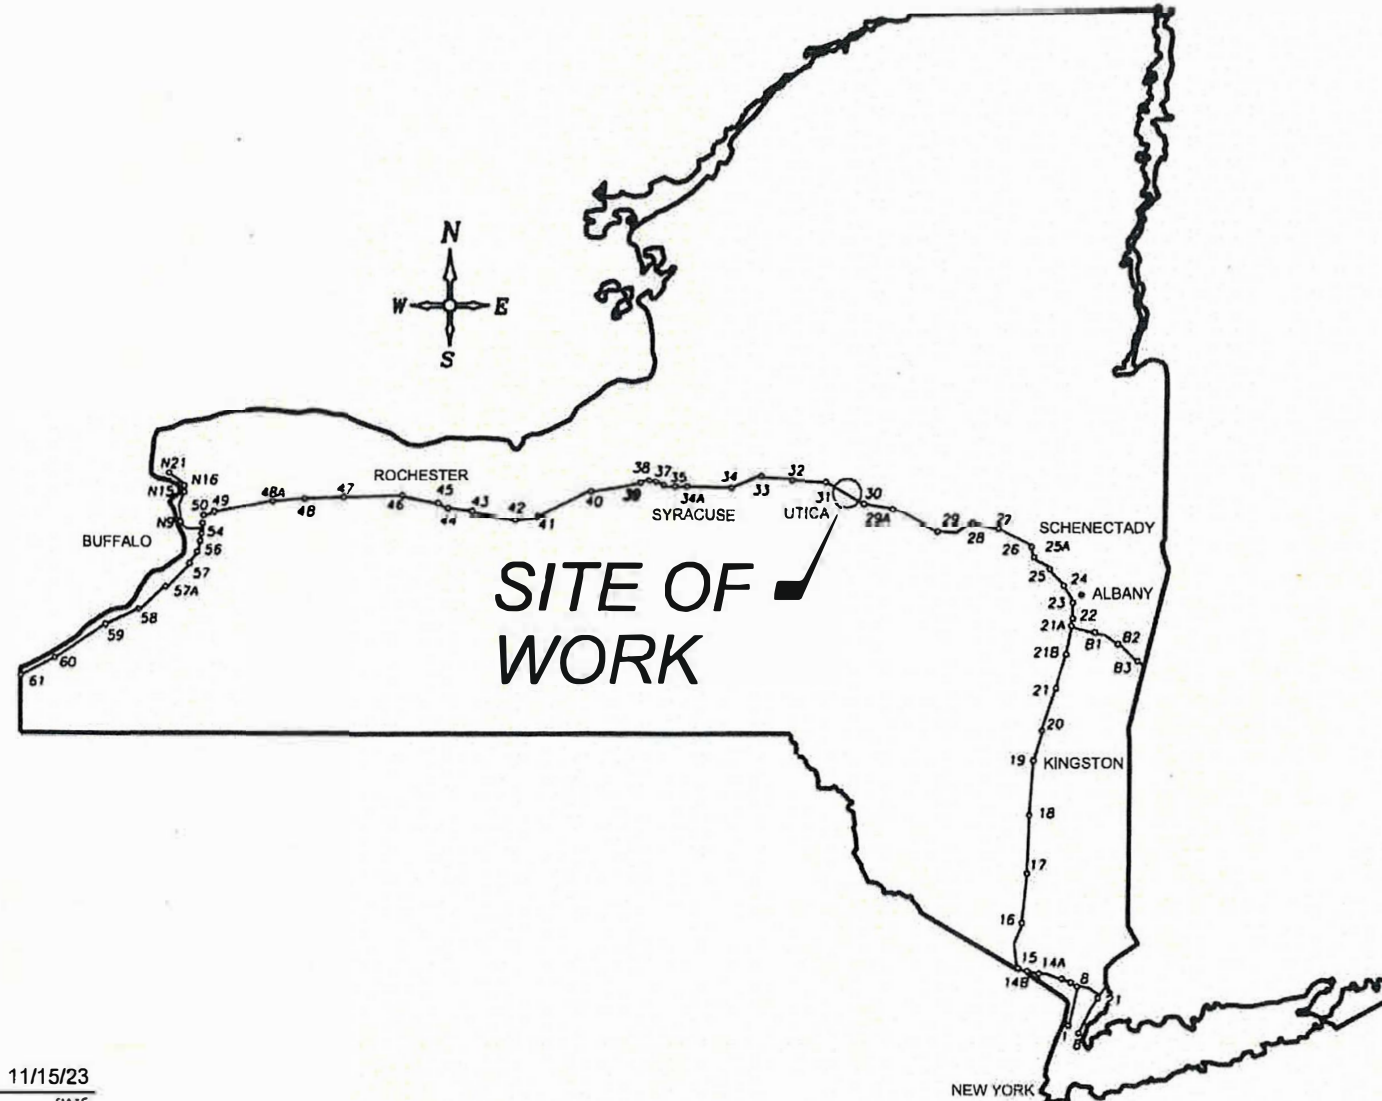

CONTRACTOR'S NAME: _____
 AWARD DATE: _____
 COMPLETION DATE: _____
 FINAL ACCEPTANCE DATE: _____
 INSPECTION FIRM'S NAME: _____
 RESIDENT ENG./EIC: _____
 FINAL COST TOTAL: _____

FISCAL SHARE	COST(S)

INSPECTION FIRM CONSULTANT STAMP: _____

RECOMMENDED BY: *Chris Witt*
DIRECTOR, OFFICE OF DESIGN
DATE: 11/15/23

RECOMMENDED BY: *Michelle Kosley*
DIVISION DIRECTOR
DATE: 11/17/23

RECOMMENDED BY: *San J. Salvo*
DIRECTOR, OFFICE OF CONSTRUCTION MANAGEMENT
DATE: 11/20/2023

RECOMMENDED BY: *Andrew M. Gagny*
DIRECTOR OF MAINTENANCE AND OPERATIONS
DATE: 12/7/23

APPROVED BY: *John A. White*
CHIEF ENGINEER
DATE: 12/7/23

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REVIEWED BY: *David T. Volney*
PROJECT MANAGER: *Michael Jurch*
BUREAU DIRECTOR: *David T. Volney*

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

DESIGN SUPERVISOR: P. PRESUTTI
 DESIGNED BY: B. HYDE
 DRAFTED BY: S. BEAMAN
 CHECKED BY: T. LINDO

ALIGNMENT		TOPOGRAPHY (MISCELLANEOUS)		UTILITIES	
ABBR.	DESCRIPTION	ABBR.	DESCRIPTION	ABBR.	DESCRIPTION
AH	AHEAD	ABUT	ABUTMENT	E	ELECTRIC
AZ	AZIMUTH	AOBE	AS ORDERED BY ENGINEER	EMH	ELECTRIC MANHOLE
BK	BACK	ASPH	ASPHALT	G	GAS
B	BASELINE	BDY	BOUNDARY	GP	GUY POLE
BRC	BEARING	BLDG	BUILDING	GSB	GAS SERVICE BOX (HOUSE LINE)
C	CENTERLINE	BM	BENCH MARK	GV	GAS VALVE (MAIN LINE)
CS	CURVE TO SPIRAL	CC	CENTER TO CENTER	HYD	HYDRANT
e	SUPERELEVATION RATE (CROSS SLOPE)	CONC	CONCRETE	LP	LIGHT POLE
EQ	EQUALITY	CONST	CONSTRUCTION	LPG	LOW PRESSURE GAS
EXT	EXTERNAL	CR	COUNTY ROAD	PP	POWER POLE
HCL	HORIZONTAL CONTROL LINE	D	DEED DISTANCE	SA	SANITARY SEWER
HSD	HEADLIGHT SIGHT DISTANCE	DM	DIRECT MEASUREMENT	SMH	SANITARY MANHOLE
L	LENGTH OF CIRCULAR CURVE	DWY	DRIVEWAY	ST	STORM SEWER
LS	LENGTH OF SPIRAL	EP	EDGE OF PAVEMENT	T	TELEPHONE
LVC	LENGTH OF VERTICAL CURVE	ES	EDGE OF SHOULDER	TCB	TRAFFIC CONTROL BOX
E	CENTER CORRECTION OF VERTICAL CURVE	FEE	FEE ACQUISITION	TELBOX	TELEPHONE BOX
M	MAIN LINE	FEE WO/A	FEE ACQUISITION WITHOUT ACCESS	TEL P	TELEPHONE POLE
PC	POINT OF CURVATURE	FP	FENCE POST	TMH	TELEPHONE MANHOLE
PI	POINT OF INTERSECTION	FD	FOUNDATION	CTV	CABLE TELEVISION
POL	POINT ON LINE	FL	FENCE LINE	W	WATER
PSD	PASSING SIGHT DISTANCE	GAR	GARAGE	WSB	WATER SERVICE BOX (HOUSE LINE)
PT	POINT OF TANGENT	GR	GRAVEL	WV	WATER VALVE (MAIN LINE)
PVC	POINT OF VERTICAL CURVE	HO	HOUSE	SUBSURFACE EXPLORATION	
PVI	POINT OF VERTICAL INTERSECTION	HWY	HIGHWAY		
PVT	POINT OF VERTICAL TANGENT	IP	IRON PIN OR IRON PIPE	ABBR.	DESCRIPTION
R	RADIUS	MB	MAILBOX	REPLACE ABBREVIATION "AB" WITH:	
SC	SPIRAL TO CURVE	MON	MONUMENT	AH	HAND AUGER
SSD	STOPPING SIGHT DISTANCE	N&W	NAIL AND WASHER	CP	CONE PENETROMETER
ST	SPIRAL TO TANGENT	OG	ORIGINAL GROUND	DA	2 1/4 INCHES CASED DRILL HOLE
STA	STATION	O/H	OVERHEAD	DM	DRILLING MUD
T	TANGENT LENGTH	P	PARCEL	DN	4 INCHES CASED DRILL HOLE
TGL	THEORETICAL GRADE LINE	PAV'T	PAVEMENT	FH	HOLLOW FLIGHT AUGER
TS	TANGENT TO SPIRAL	PE	PERMANENT EASEMENT	PA	POWER AUGER
VC	VERTICAL CURVE	PED POLE	PEDESTRIAN POLE	PH	PROBE
TOPOGRAPHY (DRAINAGE)		R	PROPERTY LINE	PT	PERCOLATION TEST HOLE
		POR	PORCH	RP	1 INCH SAMPLER (RETRACTABLE PLUG)
BB	BOTTOM OF BANK (STREAM)	RR	RAILROAD	TO BE DEFINED AT THE TIME OF EXPLORATION	
BC	BOTTOM OF CURB	RTE	ROUTE	SP	SEISMIC POINT
BO	BOTTOM OF OPENING	ROW	RIGHT OF WAY	TP	TEST PIT
CAP	CORRUGATED ALUMINUM PIPE	RW	RETAINING WALL	ABBREVIATION "C" IN CATEGORIES: DA, DM, DN, AND FH WITH:	
CAP	CORRUGATED ALUMINUM PIPE	SH	STATE HIGHWAY	B	BRIDGE
CB	CATCH BASIN	SHLDR	SHOULDER	C	CUT
CIP	CAST IRON PIPE	SPK	SPIKE	D	DAM
C STRM	CENTERLINE OF STREAM	ST	STREET	F	FILL
CMP	CORRUGATED METAL PIPE	STK	STAKE	K	CULVERT
CP	CONCRETE PIPE	STY	STORY	W	WALL
CSP	CORRUGATED STEEL PIPE	SW	SIDEWALK	X	TO BE USED IF ONE OF THE ABOVE CANNOT BE DEFINED AT THE TIME THE EXPLORATION IS MADE
CULV	CULVERT	TE	TEMPORARY EASEMENT		
DIA	DIAMETER	TO	TEMPORARY OCCUPANCY		
DMH	DRAINAGE MANHOLE	U/G	UNDERGROUND		
DS	DRAINAGE STRUCTURE PIPE	WW	WING WALL		
D'XING	DITCH CROSSING				
EHW	EXTREME HIGH WATER				
EL	ELEVATION				
ELEV	ELEVATION				
ELW	EXTREME LOW WATER				
ES	END SECTION				
HW	HEADWALL				
INV	INVERT				
MH	MANHOLE				
MHW	MEAN HIGH WATER				
OHW	ORDINARY HIGH WATER				
OLW	ORDINARY LOW WATER				
RCP	REINFORCED CONCRETE PIPE				
SICPP	SMOOTH INTERIOR CORRUGATED POLYETHYLENE PIPE				
TB	TOP OF BANK (STREAM)				
TC	TOP OF CURB				
TG	TOP OF GRATE				
VCP	VITRIFIED CLAY PIPE				

STANDARD SYMBOL (PLANS)	ITEM PAYMENT UNIT: ESTIMATE OF QUANTITIES SHEET	EQUIVALENT NOMENCLATURE: (SPECS/PROPOSAL)
"	-	INCHES
'	LF	LINEAR FEET
mi	MI	MILES
f+2	SF	SQUARE FEET
YD ²	SY	SQUARE YARD
AC	AC	ACRES
YD ³	CY	CUBIC YARD
GAL	GAL	GALLON
lb	LB	POUND
TON	TON	TON

INDEX		TOTAL NO. SHEETS: 84
SHEET NUMBER	DESCRIPTION	DRAWING NUMBER
1	COVER SHEET	COVER
2	INDEX & ABBREVIATIONS	INDEX
3	LEGEND - LINE SYMBOLOLOGY	LEG-1
4	LEGEND - POINT SYMBOLOLOGY	LEG-2
5	TABLE OF STANDARD SHEETS	SS-1
6-7	WORK ZONE TRAFFIC CONTROL NOTES	TCN-1 TO TCN-2
8	WORK ZONE TRAFFIC CONTROL SIGN TEXT DATA	TCT-1
9-15	WORK ZONE TRAFFIC CONTROL PLAN MAINLINE PHASE 1	WZTC1-1 TO WZTC1-7
16-21	WORK ZONE TRAFFIC CONTROL PLAN MAINLINE PHASE 2	WZTC2-1 TO WZTC2-6
22-26	WORK ZONE TRAFFIC CONTROL PLAN MAINLINE PHASE 3 WINTER	WZTC3-1 TO WZTC3-5
27-32	WORK ZONE TRAFFIC CONTROL PLAN MAINLINE PHASE 4	WZTC4-1 TO WZTC4-6
33	EROSION AND SEDIMENT CONTROL DETAILS	ECD-1
34-36	EROSION AND SEDIMENT CONTROL PLANS	ECP-1 TO ECP-3
37-38	TYPICAL SECTIONS	TYP-1 TO TYP-2
39	MISCELLANEOUS TABLES	MT-1
40	HORIZONTAL AND VERTICAL CONTROL	HVC-1
41-43	GENERAL PLANS	GP-1 TO GP-3
44-45	PROFILES	PR-1 TO PR-2
46-87	BRIDGE PLANS	ST-1 TO ST-42

REVISIONS			
DATE	DESCRIPTION	BY	SYM.

 Thruway Authority	TITLE OF PROJECT STERLING CREEK BRIDGE REHABILITATION	CONTRACT NUMBER: TAS 24-5B
	LOCATION OF PROJECT SYRACUSE DIVISION BIN 5516091 & 5516092 MP 227.40 & MP 227.41	DATE: NOV. 2023
	TITLE OF DRAWING INDEX AND ABBREVIATIONS	DRAWING NUMBER: INDEX

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DESIGNED BY: B. HYDE
 CHECKED BY: P. PRESUTTI
 DRAFTED BY: T. LINDO
 CHECKED BY: S. BEAMAN

ALIGNMENT			LANDSCAPE			ROADWAY			TRAFFIC WORK ZONE		
STYLE	NAME	DESCRIPTION	STYLE	NAME	DESCRIPTION	STYLE	NAME	DESCRIPTION	STYLE	NAME	DESCRIPTION
	AC	CONTROL (CENTERLINE)		LABL	AREA, BRUSH LINE		RCZ_P	CLEAR ZONE		TWZBT.P	BARRIER, TEMPORARY
	AD_P	DETOUR		LAHR	AREA, HEDGE ROW		RG	GUIDE RAIL, MISCELLANEOUS		TWZBTWL.P	BARRIER, TEMPORARY, W/ WARNING LIGHTS
	AT_P	TRANSITION CONTROL		LAPB	AREA, PLANTING BED		RGB	GUIDE RAIL, BOX BEAM		TWZCD.P	CHANNELIZING DEVICE
BRIDGE				LAWA	AREA, WOODED AREA OUTLINE		RGBM	GUIDE RAIL, BOX BEAM, MEDIAN		TWZPMRC.P	PAVEMENT MARKING REMOVAL OR COVERING
	BR	RAIL		LAWE	AREA, WATERS EDGE		RGC	GUIDE RAIL, CABLE	UTILITIES		
	BSHT	SHEET PILING		LCUT_P	CUT LIMIT		RGCB	GUIDE RAIL, CONCRETE BARRIER	STYLE	NAME	DESCRIPTION
CONTROL				LFILL_P	FILL LIMIT		RGP_P	GUIDE POST		UC	CONDUIT, UNDERGROUND
	CB	BASELINE		LFNC	FENCE		RGW	GUIDE RAIL, W BEAM		UCH	CONDUIT, HANGING
	CBPR	BASELINE, PROJECTION		LTRC	TREE ROW, CONIFEROUS		RGWM	GUIDE RAIL, W BEAM, MEDIAN		UCO	CONDUIT, OVERHEAD
DRAINAGE				LTRD	TREE ROW, DECIDUOUS		RPB	PARKING BUMPER		UE	ELECTRIC LINE, UNDERGROUND
	DCP	CULVERT PIPE		LWH	WALL, H PILE		RRC	RAIL ROAD, CATENARY		UEH	ELECTRIC LINE, HANGING
	DCP_P	CULVERT PIPE (DIR)		LWR	WALL, RETAINING		RRER	RAIL ROAD, 3RD RAIL		UEO	ELECTRIC LINE, OVERHEAD
	DDG_P	DITCH, GRASS LINED		LWS	WALL, STONE		RRPLS_P	RAIL, PHOTO, LARGE SCALE		UETO	ELECTRIC TRANSMISSION, OVERHEAD
	DDP_P	DITCH, PAVED INVERT	ROW MAPPING				RRPSS	RAIL, PHOTO, SMALL SCALE		UESS	ELECTRIC, SUBSTATIONS
	DDS_P	DITCH, STONE LINED		MDL	DEED LINE		RRS	RUMBLE STRIP		UF0	FIBER OPTIC, UNDERGROUND
	DFL_P	FLOW LINE		PE	EASEMENT, EXISTING		RRSLS_P	RAIL, SURVEY, LARGE SCALE		UFOH	FIBER OPTIC, HANGING
	DSSD	SLOTTED DRAIN		PE	EASEMENT, PERMANENT		RRSSS	RAIL, SURVEY, SMALL SCALE		UFOO	FIBER OPTIC, OVERHEAD
	DUD_P	UNDERDRAIN		APE	EASEMENT, PERMANENT, APPROX.	SIGNS				UG	GAS, UNDERGROUND
ENVIRONMENTAL				TE	EASEMENT, TEMPORARY		SBLB	BILLBOARDS		UGH	GAS, HANGING
	EBLHS	BALE, STRAW		ATE	EASEMENT, TEMPORARY, APPROX.		SM	MULTIPLE POST		UGO	GAS, OVERHEAD
	ECT	CURTAIN, TURBIDITY		FEE	FEE ACQUISITION, W/ ACCESS		SSO	STRUCTURE, OVERHEAD		UIC	INFORM CABLE, UNDERGROUND
	EDMC	DAM, COFFER		AFEE	FEE ACQUISITION, APPROXIMATE		SSOC	STRUCTURE, OVHD. CANTILEVER		UICH	INFORM CABLE, HANGING
	EDMEC_P	DAM, EARTHEN CHECK		AFEE	FEE ACQUISITION, SHAPE	STRIPING				UO	OIL LINE, UNDERGROUND
	EDMGSC_P	DAM, GRAVEL BAG/SAND BAG CHECK		AFEE	FEE ACQUISITION, W/O ACCESS		STB*	BROKEN LINE		UOH	OIL LINE, HANGING
	EDMPC_P	DAM, PREFABRICATED CHECK		MHA	HISTORICAL, ACQUISITION		STDB*	DOUBLE BROKEN LINE		UPBP	POLE, BRACE, PUSH BRACE
	EDMSC_P	DAM, STONE CHECK		HB	HIGHWAY BOUNDARY		STDL*	DOTTED LINE LONG		UPGW	POLE, GUY WIRE
	EFNS	FENCE, SILT		AHB	HIGHWAY BOUNDARY, APPROX.		STDS*	DOTTED LINE SHORT		USA	SANITARY SEWER, UNDERGROUND
	EFNSV	FENCE, SILT & VEGETATION		MHBW	Hwy BOUNDARY, FACE OF WALL		STFB*	FULL BARRIER LINE		USAH	SANITARY SEWER, HANGING
	EFNV	FENCE, VEGETATION		MHBWOA	HIGHWAY BOUNDARY, W/O ACCESS		STHB*	HATCH LINE		USAF	SANITARY SEWER, FORCE MAIN, UGND
	EWAA_P	WETLAND, ADJACENT AREA		MJC	JURISDICTION, CITY		STPB*	PARTIAL BARRIER LINE		USAFH	SANITARY SEWER, FORCE MAIN, HANG
	EFW	WETLAND, FEDERAL		MJCY	JURISDICTION, COUNTY		STRCT	ROUNDABOUT, CAT TRACKS		UT	TELEPHONE, UNDERGROUND
	EFWS	WETLAND, FEDERAL AND STATE		MJHD	JURISDICTION, HISTORIC DISTRICT		STRYL	ROUNDABOUT, YIELD LINE		UTH	TELEPHONE, HANGING
	EWM	WETLAND, MITIGATION AREA		MJLL	JURIS., (GREAT, MILITARY) LOT LINE		STSB	STOP BAR		UTO	TELEPHONE, OVERHEAD
	EWS	WETLAND, STATE		MJN	JURISDICTION, NATION		STSE*	SOLID, EDGE		UTV	CABLE TV, UNDERGROUND
				MJPB	JURISDICTION, PUBLIC LANDS		STXL	X WALK, LADDER LINE		UTVH	CABLE TV, HANGING
				MJS	JURISDICTION, STATE		STXLB	X WALK, LADDER BAR LINE		UTVO	CABLE TV, OVERHEAD
				MJT	JURISDICTION, TOWN	TRAFFIC CONTROL				UUU	UNKNOWN, UNDERGROUND
				MJV	JURISDICTION, VILLAGE		TCSW	SIGNAL, SPAN WIRE		UUH	UNKNOWN, HANGING
				MPL	PROPERTY LOT LINE					UO	UNKNOWN, OVERHEAD
				MPLA	PROPERTY LOT LINE, APPROXIMATE					UW	WATER LINE, UNDERGROUND
				MSL	SUB LOT LINE					UWH	WATER LINE, HANGING
										UWO	WATER LINE, OVERHEAD

1. THE LEGEND ILLUSTRATES MAPPING FEATURES (EXISTING AND PROPOSED).
2. FEATURES ARE SHOWN AS EITHER LINEAR (ROADWAY GUIDERAIL, ROADWAY SIDEWALK, UTILITY LINES, ETC.) OR POINT (SIGN, UTILITY POLE, ETC.).
3. FEATURES SHOWN ON THE LEGEND AS EXISTING FEATURES ALSO HAVE CORRESPONDING PROPOSED FEATURES.
4. PROPOSED FEATURE SYMBOLOGY IS IDENTICAL TO EXISTING FEATURE SYMBOLOGY EXCLUDING LINE WEIGHT. LINE WEIGHT FOR PROPOSED FEATURES IS THICKER (0.015 in ON B SIZE DRAWINGS).
5. MAPPING FEATURES NOT INCLUDED ON THE LEGEND SHEET DO NOT HAVE A UNIQUE SYMBOLOGY (SUCH AS THE PAVEMENT EDGE, PAVEMENT EDGE OF TRAVEL WAY) AND SHOULD BE LABELED ON THE PLANS.
6. FEATURES SHOWN AT THE HEAVIER WEIGHT ARE PROPOSED ONLY AND DO NOT HAVE CORRESPONDING EXISTING FEATURES.

REVISIONS			
DATE	DESCRIPTION	BY	SYM.



TITLE OF PROJECT STERLING CREEK BRIDGE REHABILITATION	CONTRACT NUMBER: TAS 24-5B
LOCATION OF PROJECT SYRACUSE DIVISION BIN 5516091 & 5516092, MP 227.40 & MP 227.41	DATE: NOV. 2023
TITLE OF DRAWING LEGEND - LINE SYMBOLOGY	DRAWING NUMBER: LEG-1

New York State Thruway Authority Standard Sheets

The following NYS Thruway Authority standard sheets, marked with an "X" in first column, apply to this project.

X	SHEET NO.	SUBJECT
X	TA 201-01	Clearing and Grubbing (Dwg. CG)
X	TA 203-01	Shoulder Backup 1R Projects (Dwg. SB)
	TA 203-02	Slope Flattening Details
	TA 402-01	Highway Pavement Repair Details (Dwg. PRD)
	TA 402-02	Bridge Deck Wearing Course Resurfacing (Dwg. BDR)
	TA 402-03	Overhead Bridge Underclearance Improvement (Dwg. BU)
	TA 603-01	Culvert Extension Details
	TA 605-01	Underdrain Details
	TA 606-01	Modified Thrie Beam (Mod.) Guiderail (Dwg. GR-1)
	TA 606-02	Vacant
	TA 606-03	Corrugated Median Barrier to Corrugated Beam Guide Railing Transition Detail D (Dwg. GR-4)
	TA 606-04	Box Beam to 42" Single Slope Half Section Concrete Barrier Pier Protection (Dwg. GR-5)
	TA 606-05	HPBO (Mod.) Corrugated Beam to 42" Single Slope Half Section Concrete Barrier Pier Protection (Dwg. GR-6)
	TA 606-06	Typical U-Turn Median Rail Layout and Roadway Transverse Section
	TA 606-07	Modified Thrie Beam Guiderail with Rock Rail
	TA 611-01	Living Snow Fences
X	TA 614-01	Tree Removal
X	TA 619-01	Work Zone Traffic Control Tables & Legend
X	TA 619-02	General Work Zone Traffic Control Notes & Channelizing Devices
X	TA 619-03	Shoulder Closure Short-Term or Intermediate-Term Stationary
X	TA 619-04	Shoulder Closure Short-Duration Stationary and Mobile
X	TA 619-05	Signing & Delineation for Shoulder Work Spaces with Temporary Concrete Barrier
X	TA 619-06	Work Beyond Shoulder
X	TA 619-07	Be Prepared to Stop and Uneven Lanes Signing
X	TA 619-08	Single Lane Closure Short- or Intermediate-Term Stationary: 65 MPH Zone
	TA 619-09	Double Lane Closure Short- or Intermediate-Term Stationary: 65 MPH Zone
	TA 619-10	Center Lane Closure Short- or Intermediate-Term Stationary: 65 MPH Zone
X	TA 619-11	Lane Shift: 65 MPH Zone
	TA 619-12	Single Lane Closure Short- or Intermediate-Term Stationary: 55 MPH Zone
	TA 619-13	Double Lane Closure Short- or Intermediate-Term Stationary: 55 MPH Zone
	TA 619-14	Center Lane Closure Short- or Intermediate-Term Stationary: 55 MPH Zone
	TA 619-15	Lane Shift: 55 MPH Zone
	TA 619-16	Work Zone Traffic Control at Interchanges, Service Areas and Parking Areas
X	TA 619-17	Work Zone Traffic Control for Miscellaneous Operations
X	TA 619-18	Mobile Lane Closure
	TA 619-19	Mobile Lane Closure: Narrow Shoulder Area
X	TA 619-20	Short-Duration Lane Closure
	TA 619-21	Short-Duration Double Lane Closure
X	TA 619-22	Work Zone Traffic Control Guide for Pavement Striping Operations
X	TA 619-23	Mobile Lane Closure for Pavement Striping Operations
	TA 619-24	Mobile Lane Closure for Pavement Striping Operations: Narrow Shoulder Area
	TA 619-25	Work Zone Traffic Control for Pavement Striping Operations at Interchanges, Service Areas and Parking Areas
	TA 619-26	Temporary Rock Catchment Barrier (Sheets 1-3)
	TA 619-27	Workzone Overhead Gantry Signing
	TA 619-30	New York Division Traffic Management Tables (Sheets 1-27)
	TA 619-31	Albany Division 1,150 Veh/Hr/Lane Traffic Management Tables (Sheets 1-18)
X	TA 619-32	Syracuse Division 1,150 Veh/Hr/Lane Traffic Management Tables (Sheets 1-18)
	TA 619-33	Buffalo Division 1,150 Veh/Hr/Lane Traffic Management Tables (Sheets 1-37)
	TA 619-34	Vacant
	TA 619-35	Albany Division 1,300 Veh/Hr/Lane Traffic Management Tables (Sheets 1-18)
X	TA 619-36	Syracuse Division 1,300 Veh/Hr/Lane Traffic Management Tables (Sheets 1-18)
	TA 619-37	Buffalo Division 1,300 Veh/Hr/Lane Traffic Management Tables (Sheets 1-37)
	TA 625-01	ROW and Survey Markers
	TA 645-01	Wrong Way Deterrence Sign
X	TA 646-01	Reference Marker Details (Sheets 1-2)
	TA 670-01	Fiber Optic & Backbone Handhole Relocation Details
	TA 680-01	Inductance Loop Installation
	TA 680-02	Highway Advisory Radio (Sheets 1-9)
X	TA 685-01	Pavement Marking Details: Asphalt and Concrete Pavement (Sheets 1-2)
	TA 685-02	Pavement Marking Details: Tapered Acceleration and Deceleration Lanes
	TA 685-03	Vacant
X	TA 685-04	Temporary Pavement Marking Details
	TA 690-01	Loop and Treadle Plan (Sheets 1-2)
	TA 690-02	Toll Lane Slab Reinforcement Plan
	TA 690-03	10 ft Treadle Frame (Sheets 1-4)

The officially adopted New York State Thruway Authority Standard Sheets book is available on the Thruway Authority's website at: <http://www.thruway.ny.gov/business/contractors/standard-sheets/index.shtml>

REV. 8/22

Highway Work Type

The marked types & treatments apply to the indicated milepost range(s) below.

MILEPOST FROM:	227.39	227.40					
TO:	227.41	227.42					
PROJECT TYPE	X	X	X	X	X	X	X
1R Resurfacing							
2R Resurfacing							
3R Rehabilitation							
Reconstruction	X	X					
Safety Improvements	X	X					
Drainage							
Rock Slope Remediation							
Pavement Striping	X	X					
Other:							
PAVEMENT TREATMENT	X	X	X	X	X	X	X
Isolated Pavement Repairs Only							
Thin Overlay without Milling							
Thin Overlay with Milling							
1" Mill & Inlay without Shoulders							
1" Mill & Inlay with Shoulders							
2" Mill & Inlay without Shoulders							
2" Mill & Inlay with Shoulders							
Mill to Concrete with 4" Overlay							
Mill to Concrete with 4.5" Overlay							
Mill to Concrete with 5" Overlay							
Crack and Seat with Overlay							
Rubblize with Overlay							
Full Depth Shoulder Recon							

Structure Work Type

The marked types apply to the indicated milepost(s) below.

MILEPOST:	227.40	227.41					
PROJECT TYPE	X	X	X	X	X	X	X
Bridge Washing							
Scour Protection							
Channel Cleaning							
Railing System	X	X					
Protective Screening							
Painting							
Steel Repair							
Wearing Surface Treatment							
Deck Repairs							
Joint Rehabilitation							
Joint Replacement	X	X					
Bearing Rehabilitation							
Bearing Replacement	X	X					
Hanger Pin Replacement							
Security							
Seismic Retrofit							
Substructure Rehabilitation	X	X					
Electrical							
Cathodic Protection System							
Fender or Pier Protection System							
Deck Replacement	X	X					
Superstructure Replacement							
Bridge Replacement							
Added Bridge (New Location)							
Abandoned Bridge							
Other:							

New York State Department of Transportation Standard Sheets

The latest revisions of the New York State Department of Transportation Standard Sheets maintained by NYSDOT, which are current as of the Standard Specifications adoption date shown on the Proposal cover, shall be considered to be in effect. All pay items and work contained in the Contract and any additional pay items and work encountered during the course of the Contract shall be subject to the applicable standard sheet(s) unless otherwise specified in the Contract documents.

The officially adopted New York State Department of Transportation Standard Sheets book is available on the NYSDOT website at: <https://www.dot.ny.gov/main/business-center/engineering/specifications/busi-e-standards-usc>

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 DESIGNED BY: TA
 CHECKED BY: TA
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REVISIONS					TITLE OF PROJECT STERLING CREEK BRIDGE REHABILITATION	CONTRACT NUMBER: TAS 24-5B
DATE	DESCRIPTION	BY	SYM.			
					LOCATION OF PROJECT SYRACUSE DIVISION BIN 5516091 & 5516092 MP 227.40 & MP 227.41	DATE: NOV. 2023
					TITLE OF DRAWING NYSTA STANDARD SHEETS LISTING AND WORK TYPE TABLES	DRAWING NUMBER: SS-1

GENERAL WORK ZONE TRAFFIC CONTROL NOTES:

1. THE CONTRACTOR SHALL MAINTAIN TRAFFIC THROUGHOUT THE LENGTH AND DURATION OF THE CONTRACT IN ACCORDANCE WITH THE APPROVED/ACTIVE NYS DOT STANDARD SPECIFICATIONS AT THE TIME OF LETTING - SECTION 619 WORK ZONE TRAFFIC CONTROL, THE 2009 MANUAL ON UNIFORM TRAFFIC CONTROL DEVICES (MUTCD), THE NYS SUPPLEMENT TO THE MUTCD, THE WORK ZONE TRAFFIC CONTROL DETAILS IN THE PLANS AND PROPOSAL, OR A.O.B.E.
2. SEE NYSTA STANDARD SHEET TA 619-01 FOR WORK DURATION DEFINITIONS AND TABLES.
3. EXISTING PAVEMENT MARKINGS IN CONFLICT WITH INTERIM PAVEMENT MARKINGS SHALL BE REMOVED UTILIZING ITEM 619.08010225 - REMOVE PAVEMENT MARKING STRIPES, 6" EPOXY PAINT. THE COST FOR INTERIM PAVEMENT MARKINGS ON NEW, FINAL PAVEMENT SHALL BE INCLUDED IN THE PRICE BID FOR ITEM 619.100104 - INTERIM PAVEMENT MARKINGS, STRIPES (REMOVABLE WET REFLECTIVE TAPE). ITEM 619.1001025 - INTERIM PAVEMENT MARKINGS, STRIPES (6 INCHES) TRAFFIC PAINT SHALL BE USED FOR INTERIM PAVEMENT MARKINGS THAT ARE TO BE LOCATED ON EXISTING PAVEMENT SURFACES AND NEW SURFACES THAT ARE TO BE RECONSTRUCTED. UPON COMPLETION OF CONSTRUCTION ACTIVITIES, THE EXISTING PAVEMENT MARKINGS SHALL BE RESTORED WITH HIGHLY REFLECTORIZED RECESS TRIPLE DROP EPOXY PAVEMENT STRIPES, WHITE OR YELLOW IN COLOR AS REQUIRED.
4. MOBILE LANE CLOSURES MAY BE UTILIZED TO INSTALL TRAFFIC CONTROL DEVICES.
5. THE CONTRACTOR SHALL MAINTAIN ACCESS FOR EMERGENCY VEHICLES THROUGHOUT THE PROJECT AREA AT ALL TIMES. ALL EXITING HIGHWAY MEDIAN TURNAROUND AREAS SHALL REMAIN OPEN FOR EMERGENCY VEHICLE USE.
6. THE CONTRACTOR SHALL PLAN AND INCORPORATE ACCESS POINTS INTO THE WORK ZONE SUCH THAT, TO THE EXTENT PRACTICAL, THE CONTRACTOR'S VEHICLES ENTERING AND LEAVING THE WORK ZONE SHALL NOT IMPEDE THE MOVEMENT OF THROUGH TRAFFIC IN THE ADJACENT OPEN LANE(S).

CHANGES TO WORK ZONE TRAFFIC CONTROL (WZTC) PLANS:

1. LANE AND RAMP CLOSURES, AND WORK HOUR RESTRICTIONS SHALL BE IN ACCORDANCE WITH THE CONTRACT DOCUMENTS.
2. THE CONTRACTOR MAY SUBMIT TO THE ENGINEER FOR REVIEW AND APPROVAL CHANGES TO THE WORK ZONE TRAFFIC CONTROL SCHEMES AND CONSTRUCTION SEQUENCE PRESENTED IN THESE PLANS.
3. THE WORK ZONE TRAFFIC CONTROL SCHEMES INCLUDED IN THESE PLANS DESCRIBE RECOMMENDED METHODS AND NECESSARY CONTROL DEVICES. THE ENGINEER MAY ORDER ADDITIONAL METHODS, ADDITIONAL DEVICES, OR ANY COMBINATION THEREOF, TO BETTER MEET FIELD CONDITIONS.

WZTC RESTRICTIONS:

1. ALL TRAFFIC ON INTERSTATE 90 SHALL BE MAINTAINED ON A PAVED SURFACE AS SHOWN IN THE TYPICAL SECTIONS. THE MINIMUM MAINLINE LANE WIDTH SHALL BE 11 FT FOR INTERSTATE 90.
2. THERE SHALL BE NO WORK OPERATIONS ALLOWED BEFORE SUNRISE OR AFTER SUNSET UNLESS PREVIOUSLY APPROVED BY THE NYS THRUWAY / ENGINEER AND AN APPROVED LIGHTING PLAN IS PROVIDED. THE LIGHTING PLAN SHOULD BE APPROVED PRIOR TO THE START OF WORK BY THE ENGINEER.
3. LANE CLOSURE SHALL NOT BE ALLOWED WHEN EITHER VISIBILITY OR PAVEMENT CONDITION ARE JUDGED TO BE INADEQUATE BY THE ENGINEER.
4. THE CONTRACTOR SHALL SCHEDULE AND PROGRESS THE CONTRACT WORK IN A MANNER THAT MINIMIZES THE DURATION OF LANE CLOSURES. LANE CLOSURES SHALL BE USED ONLY WHEN WORK IS ACTUALLY IN PROGRESS.
5. LANE CLOSURES ON INTERSTATE 90 SHALL BE IN ACCORDANCE WITH THE NEW YORK STATE THRUWAY AUTHORITY TA 619-32 STANDARD SHEET, SYRACUSE DIVISION 1.150 VEH/HR/LANE TRAFFIC MANAGEMENT TABLES.
6. ALL REDUCED SPEED LIMITS WITHIN THE PROJECT LIMITS SHALL BE IN ACCORDANCE WITH THE CONTRACT DOCUMENTS. COST OF SIGNS SHALL BE INCLUDED IN THE BID PRICE FOR ITEM 619.01.

WZTC COORDINATION:

1. THE CONTRACTOR SHALL BE AWARE THAT THERE MAY BE OTHER CONTRACTS, MAINTENANCE OPERATIONS, OR BRIDGE INSPECTIONS IN PROGRESS IN THE WORK AREA. THE ENGINEER AND THE CONTRACTOR SHALL COMMUNICATE WITH, AND COORDINATE OPERATIONS WITH, THE OTHER OPERATIONS SO THAT NO CONFLICT IN WORK SCHEDULING OR LOCATION OCCURS. LANE CLOSURE SHALL BE REPORTED TO NYSTA, ONE WEEK IN ADVANCE OF THE CLOSURE.
2. BEFORE ANY ROADWAY WIDTH RESTRICTIONS CAN BE MADE, THE CONTRACTOR SHALL PROVIDE THE ENGINEER WITH TWENTY (21) CALENDAR DAYS NOTICE SO HE/SHE MAY APPRISE THE NYSTA IN WRITING OF THE LANE WIDTH RESTRICTIONS. THE CONTRACTOR SHALL NOTIFY THE ENGINEER IN WRITING IMMEDIATELY UPON THE REMOVAL OF THE LANE WIDTH RESTRICTION SO THE ENGINEER CAN NOTIFY THE NYSTA. FAILURE OF THE CONTRACTOR TO PROVIDE THE NECESSARY NOTICE MAY RESULT IN DELAYS TO THE CONTRACTOR'S OPERATIONS.
3. LOCAL FIRE, POLICE, AMBULANCE, REGIONAL TRANSIT SERVICE AND MUNICIPAL AUTHORITIES SHALL BE NOTIFIED BY THE CONTRACTOR TWO WEEKS IN ADVANCE OF THE BEGINNING OF WORK ON ANY HIGHWAY SEGMENT IN ORDER TO COORDINATE AND MAINTAIN ESSENTIAL SERVICES.

WZTC SIGNING AND DEVICES:

1. THE CONSTRUCTION AND REGULATORY SIGNS FOR A PARTICULAR WORK ZONE TRAFFIC CONTROL PHASE SHALL BE IN PLACE PRIOR TO THE START OF THAT PHASE. ALL CONSTRUCTION SIGNS SHALL EITHER BE REMOVED OR COVERED COMPLETELY WITH OPAQUE MATERIAL WHEN NOT REQUIRED.
2. THE BOTTOM OF TEMPORARY CONSTRUCTION SIGNS SHALL BE A MINIMUM OF 5 FT ABOVE THE EDGE OF THE ROADWAY GRADE. SEE SECTION 619-3.02 FOR INFORMATION ON MOUNTING HEIGHTS FOR SIGNS WITH AUXILIARY PANELS. SIGNS SHALL BE LOCATED OFF THE EDGE OF SHOULDER.
3. CONSTRUCTION FLAGS SHALL BE INSTALLED ON SIGNS AT LOCATIONS IDENTIFIED ON PLANS. THE COST SHALL BE INCLUDED IN THE PRICE BID FOR ITEM 619.01 WORK ZONE TRAFFIC CONTROL.
4. AT NIGHT, FLASHING ARROW BOARDS SHALL NOT BE OPERATED AT SUCH BRIGHTNESS THAT SIGNS, DRUMS, IMPACT ATTENUATION DEVICES CANNOT EASILY BE SEEN BY APPROACHING MOTORISTS. TO ENSURE THAT FLASHING ARROW BOARDS ARE NOT TOO BRIGHT FOR THE NIGHT OPERATION, THE CONTRACTOR SHALL MAKE AN ON SITE INSPECTION OF EACH ARROW BOARD AT THE BEGINNING OF ITS FIRST NIGHT OF OPERATION. IF THE INSPECTION FINDS THAT AN ARROW BOARD IS TOO BRIGHT, THE CONTRACTOR SHALL PROMPTLY REDUCE THE LAMP INTENSITY. IN THIS CONTEXT, "PROMPTLY", SHALL MEAN NO LATER THAN THE BEGINNING OF THE NEXT NIGHT OF THE ARROW BOARDS OPERATIONS. THE COST OF THIS WORK SHALL BE INCLUDED IN THE PRICE BID FOR ITEM 619.01, WORK ZONE TRAFFIC CONTROL. FAILURE TO COMPLY WITH THIS NOTE SHALL BE CONSIDERED UNSATISFACTORY WORK ZONE TRAFFIC CONTROL. PAYMENT DEDUCTIONS SHALL BE MADE IN CONFORMANCE WITH SECTIONS 619, WORK ZONE TRAFFIC CONTROL.
5. IN ACCORDANCE WITH THE REQUIREMENTS OF SECTION 619 OF THE NYS DOT STANDARD SPECIFICATIONS, THE CONTRACTOR SHALL BE RESPONSIBLE FOR MAINTENANCE OF ALL TEMPORARY TRAFFIC CONTROL DEVICES. THAT IS, THE CONTRACTOR SHALL ENSURE THAT ALL SUCH ITEMS AS SIGNALS & SIGNS, CONES, FLASHERS, DRUMS, ETC. ARE IN PLACE AND IN GOOD CONDITION. THE ENGINEER SHALL BE THE SOLE JUDGE OF THE EFFECTIVENESS OF THE CONTRACTOR'S EFFORTS TOWARD THE MAINTENANCE AND PROTECTION OF TRAFFIC.
6. WZTC SIGNS AND APPURTENANCES SHALL BE PLACED/STORED OFF THE EDGE OF THE SHOULDER. THE CONTRACTOR IS ENCOURAGED TO LEAVE SIGNS AND APPURTENANCES IN THE AREA THAT THEY ARE NEEDED TO REDUCE CLOSURE SETUP TIME AND MAXIMIZE THE AMOUNT OF "WORK TIME" DURING EACH WORK DAY. WZTC AND SIGNS APPURTENANCES SHALL NOT BE STORED OFF THE EDGE OF THE SHOULDER FROM NOVEMBER 15 TO APRIL 1, THEY SHALL BE PICKED UP AT THE END OF EACH WORK DAY.

RESPONSIBILITY FOR EMERGENCY REPAIRS:

1. THE ENGINEER SHALL SUBMIT, IN WRITING, TO THE NEW YORK STATE POLICE, AND LOCAL POLICE, THE NAMES, ADDRESSES, AND TELEPHONE NUMBERS OF HIS/HER AND THE CONTRACTOR'S STAFF WHO ARE AUTHORIZED TO SECURE LABOR, MATERIALS, AND EQUIPMENT FOR EMERGENCY REPAIRS OUTSIDE OF NORMAL WORKING HOURS.

ROADSIDE HAZARDS:

1. IF THE SHOULDER TO BE USED FOR WORK ZONE TRAFFIC CONTROL SHOWS SIGNS OF DISTRESS, IT SHALL BE REPLACED PRIOR TO TRAFFIC BEING PLACED ON IT. THE SHOULDER SHALL BE CLOSED USING THE TYPICAL WORK ZONE TRAFFIC CONTROL SCHEMES FOR SHOULDER CLOSURE SHOWN IN THE PLANS.
2. EXCAVATIONS THAT PRODUCE A DROP-OFF ON BOTH SIDES OF THE TRAVEL LANES SHALL NOT BE PERMITTED, UNLESS PROTECTED WITH CONCRETE BARRIER. SEE TABLE 619-3 IN SECTION 619-3.02 FOR DROP-OFF DELINEATION REQUIREMENTS.
3. WHEN NOT IN USE, THE CONTRACTOR SHALL NOT STORE ANY CONSTRUCTION EQUIPMENT, SIGNS, TRAFFIC CONTROL DEVICES, MATERIAL OR ANY OTHER APPURTENANCES ALONG THE ROADWAY WITHIN THE CLEAR ZONE UNLESS PROTECTED BY AN APPROVED PHYSICAL BARRIER.
4. EXISTING GUIDE RAIL SHALL REMAIN IN PLACE UNTIL CONSTRUCTION ACTIVITIES NECESSITATE REMOVAL. NEW GUIDE RAIL SHALL BE INSTALLED WITHIN 14 DAYS IN ACCORDANCE WITH SECTION 619-3.02E. DELINEATION AND DROP-OFF PROTECTION SHALL BE SPECIFIED IN SECTION 619 WORK ZONE TRAFFIC CONTROL.

CHANGING WZTC SCHEMES:


1. WHEN IT IS NECESSARY TO CHANGE THE LANES THAT ARE CLOSED TO TRAFFIC, THE CONTRACTOR SHALL BE REQUIRED TO FIRST REMOVE ALL DRUMS, CONES, SIGNS, ARROWS, AND THE LIKE SO THAT ALL LANES ARE OPEN BEFORE THE NEW SCHEME IS SET IN PLACE. THIS METHOD MAY BE MODIFIED BY THE ENGINEER, AS NECESSARY.
2. WHEN REOPENING TRAVEL LANES TO TRAFFIC, THE CONTRACTOR SHALL START BY REMOVING THE CONES AT THE FAR END OF THE LANE CLOSURE AND WORK TOWARDS THE SIGNS AT THE BEGINNING OF THE LANE CLOSURE. THE SIGNS ARE NOT TO BE TAKEN DOWN UNTIL ALL TRAFFIC CONTROL DEVICES HAVE BEEN REMOVED.

BARRIER VEHICLE WITH MOUNTED ATTENUATORS:

1. BARRIER VEHICLE (BV) WITH MOUNTED ATTENUATORS ARE REQUIRED ONLY WHEN WORKERS ARE PRESENT IN A CLOSED TRAVEL LANE OR CLOSED SHOULDER ON THE INTERSTATE. A BV SHALL BE USED AT EACH WORK LOCATION WITHIN THE CLOSURE. THE COST SHALL BE INCLUDED IN THE COST BID FOR ITEM 619.01.
2. BARRIER VEHICLE WITH MOUNTED ATTENUATORS SHALL BE PLACED TO ACCOMMODATE ANTICIPATED ROLL -AHEAD DISTANCE (DISTANCE BETWEEN THE FRONT OF THE BV TRUCK AND THE FIRST WORKER OR VEHICLE TO BE PROTECTED). FOLLOW TRUCK MANUFACTURER'S INSTRUCTIONS.

FLASHING ARROW PANEL:

1. FLASHING ARROW PANELS SHALL COMPLY WITH SECTION 729-15 OF THE STANDARD SPECIFICATIONS.
2. THE COST OF FLASHING ARROW PANEL SHALL BE INCLUDED IN THE PRICE BID FOR ITEM 619.01.

ALTERED ON:	AFFIXED ON: 11/08/2023
SIGNATURE: STAMP:	SIGNATURE: STAMP: 

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REVISIONS			
DATE	DESCRIPTION	BY	SYM.



Thruway Authority



RAVI ENGINEERING & LAND SURVEYING, P.C.

TITLE OF PROJECT STERLING CREEK BRIDGE REHABILITATION	CONTRACT NUMBER: TAS 24-5B
LOCATION OF PROJECT SYRACUSE DIVISION BIN 5516091 & 5516092 MP 227.40 & MP 227.41	DATE: Nov. 2023
TITLE OF DRAWING WORK ZONE TRAFFIC CONTROL NOTES	DRAWING NUMBER: TCN-1

CONSTRUCTION SEQUENCE:

PRE-PHASE 1:

1. REMOVE MILLED-IN AUDIBLE ROADWAY DELINEATORS WITHIN THE RIGHT AND LEFT SHOULDERS OF I-90 EASTBOUND AND I-90 WESTBOUND UTILIZING DAILY SHORT-TERM TRAFFIC CONTROLS PER NYSTA STANDARD SHEETS.

PHASE 1:

1. USING DAILY SHORT-TERM TRAFFIC CONTROLS PER NYSTA STANDARD SHEETS INSTALL TEMPORARY POSITIVE BARRIER AND WORK ZONE TRAFFIC CONTROL PATTERN AS SHOWN ON DWG. WZTC 1-1 THROUGH WZTC 1-7.
2. REMOVE EXISTING GUIDE RAIL AND SIGNING IN MEDIAN.
3. CONSTRUCT TEMPORARY FULL DEPTH PAVED MEDIAN AND INTERCEPTOR DRAIN AS SHOWN ON DWG. WZTC 1-1 THROUGH WZTC 1-7.
4. INSTALL TEMPORARY POSITIVE BARRIER IN MEDIAN AREA IN PREPARATION OF PHASE 2 CROSSOVER AS SHOWN ON DWG. WZTC 2-1 THROUGH WZTC 2-6.

PHASE 2:

1. PHASE 2 REQUIRES A CROSSOVER THAT WILL ALLOW EB TRAVEL LANES TO TRAVEL ON THE WESTBOUND SIDE OF I-90, THUS ALLOWING REHABILITATION AND RECONSTRUCTION OF THE EASTBOUND STRUCTURE, DECK, AND APPROACH PAVEMENT.
2. USING DAILY SHORT-TERM TRAFFIC CONTROLS PER NYSTA STANDARD SHEETS REMOVE PHASE 1 WORK ZONE TRAFFIC CONTROL PATTERN.
3. ESTABLISH REMAINDER OF I-90 EASTBOUND CROSSOVER TRAFFIC PATTERN AS SHOWN ON DWG. WZTC 2-1 THROUGH WZTC 2-6 UTILIZING DAILY SHORT-TERM TRAFFIC CONTROL PER NYSTA STANDARD SHEETS.

PHASE 3 (WINTER SHUTDOWN):

1. RE-ESTABLISH PRE-CONSTRUCTION TRAFFIC PATTERNS OVER WINTER MONTHS.
2. USING DAILY SHORT-TERM TRAFFIC CONTROLS PER NYSTA STANDARD SHEETS REMOVE PHASE 2 WORK ZONE TRAFFIC CONTROL PATTERN.
3. USING DAILY SHORT-TERM TRAFFIC CONTROL PER NYSTA STANDARD SHEETS INSTALL TEMPORARY CONCRETE BARRIER AS SHOWN ON DWG. WZTC 3-1 THROUGH WZTC 3-5.

PHASE 4:

1. PHASE 4 REQUIRES A CROSSOVER THAT WILL ALLOW WB TRAVEL LANES TO TRAVEL ON THE EASTBOUND SIDE OF I-90, THUS ALLOWING REHABILITATION AND RECONSTRUCTION OF THE WESTBOUND STRUCTURE, DECK, AND APPROACH PAVEMENT.
2. USING DAILY SHORT-TERM TRAFFIC CONTROLS PER NYSTA STANDARD SHEETS REMOVE MAINLINE PHASE 3 WORK ZONE TRAFFIC CONTROL PATTERN.
3. ESTABLISH REMAINDER OF I-90 WESTBOUND CROSSOVER TRAFFIC PATTERN AS SHOWN ON DWG. WZTC 4-1 THROUGH WZTC 4-6 UTILIZING DAILY SHORT-TERM TRAFFIC CONTROL PER NYSTA STANDARD SHEETS.

PHASE 5:

1. USING DAILY SHORT-TERM TRAFFIC CONTROLS PER NYSTA STANDARD SHEETS REMOVE MAINLINE PHASE 4 WORK ZONE TRAFFIC CONTROL PATTERN.
2. USING DAILY SHORT-TERM TRAFFIC CONTROLS PER NYSTA STANDARD SHEETS INSTALL TEMPORARY POSITIVE BARRIER AND WORK ZONE TRAFFIC CONTROL PATTERN AS SHOWN ON DWG. WZTC 1-2 THROUGH WZTC 1-6.
3. REMOVE TEMPORARY PAVED MEDIAN AND TRENCH DRAIN.
4. FINAL GRADE MEDIAN OF I-90, ADJUST EXISTING DRAINAGE INLETS TO FINAL GRADE, RESET GUIDE RAIL IN MEDIAN AREA OF I-90 TO MATCH PRECONSTRUCTION CONDITIONS.
5. REMOVE PHASE 5 WORK ZONE TRAFFIC CONTROL PATTERN.
6. USING DAILY SHORT-TERM TRAFFIC CONTROLS PER NYSTA STANDARD SHEETS, INSTALL MILLED-IN AUDIBLE ROADWAY DELINEATORS, AND RESTORE MAINLINE WESTBOUND AND EASTBOUND TRAFFIC STRIPING TO PRECONSTRUCTION CONFIGURATION UTILIZING FINAL PAVEMENT MARKINGS.


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DRAFTED BY: T. SAMSON/W. DILONE

CHECKED BY: D. CLARK

DESIGNED BY: T. SAMSON

DESIGN SUPERVISOR: R. PAPA/J

ALTERED ON:	AFFIXED ON: 11/08/2023
SIGNATURE: STAMP:	SIGNATURE: STAMP: 

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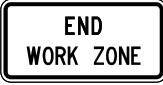







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DATE	DESCRIPTION	BY	SYM.













TITLE OF PROJECT STERLING CREEK BRIDGE REHABILITATION
LOCATION OF PROJECT SYRACUSE DIVISION BIN 5516091 & 5516092 MP 227.40 & MP 227.41
TITLE OF DRAWING WORK ZONE TRAFFIC CONTROL NOTES

CONTRACT NUMBER: TAS 24-5B
DATE: Nov. 2023
DRAWING NUMBER: TCN-2

TEXT NUMBER	TEXT	M.U.T.C.D. NUMBER	SIZE (INCHES)	COLOR		REMARKS
				BACKGROUND	LEGEND	
1		G20-2	48"x24"	ORANGE	BLACK	
2		OM3-L	12"x36"	YELLOW	BLACK	
3		R2-11	36"x48"	WHITE	BLACK	
4		R2-12	36"x54"	WHITE	BLACK	
5		G20-5aP	36"x24"	ORANGE	BLACK	
6		R2-1	36"x48"	WHITE	BLACK	
7		W1-4bR	48"x48"	ORANGE	BLACK	
8		W1-4bL	48"x48"	ORANGE	BLACK	

TEXT NUMBER	TEXT	M.U.T.C.D. NUMBER	SIZE (INCHES)	COLOR		REMARKS
				BACKGROUND	LEGEND	
9		OM3-R	12"x36"	YELLOW	BLACK	
10		NYR9-11	48"x84"	WHITE	BLACK	
11		W20-1	48"x48"	ORANGE	BLACK	
12		W3-5	48"x48"	ORANGE	BLACK	
13		W20-1	48"x48"	ORANGE	BLACK	
14		W1-8R	30"x36"	ORANGE	BLACK	
15		W1-8L	30"x36"	ORANGE	BLACK	

ALTERED ON:	AFFIXED ON: 11/08/2023
SIGNATURE: STAMP:	SIGNATURE: STAMP:



IT IS A VIOLATION OF LAW FOR ANY PERSON, UNLESS THEY ARE ACTING UNDER THE DIRECTION OF A LICENSED PROFESSIONAL ENGINEER, ARCHITECT, LANDSCAPE ARCHITECT, OR LAND SURVEYOR, TO ALTER AN ITEM IN ANY WAY. IF AN ITEM BEARING THE STAMP OF A LICENSED PROFESSIONAL IS ALTERED, THE ALTERING ENGINEER, ARCHITECT, LANDSCAPE ARCHITECT, OR LAND SURVEYOR SHALL STAMP THE DOCUMENT AND INCLUDE THE NOTATION "ALTERED BY" FOLLOWED BY THEIR SIGNATURE, THE DATE OF SUCH ALTERATION, AND A SPECIFIC DESCRIPTION OF THE ALTERATION.

REVISIONS			
DATE	DESCRIPTION	BY	SYM.



Thruway Authority



TITLE OF PROJECT
STERLING CREEK BRIDGE REHABILITATION

LOCATION OF PROJECT
SYRACUSE DIVISION
BIN 5516091 & 5516092 MP 227.40 & MP 227.41


TITLE OF DRAWING
WORK ZONE TRAFFIC CONTROL
SIGN TEXT DATA

CONTRACT NUMBER:
TAS 24-5B


DATE:
Nov. 2023

DRAWING NUMBER:
TCT-1

PW/ CHECKED BY: R. PAPA, J. CLARK
 DRAFTED BY: T. SAMSON, W. DILONE
 CHECKED BY: D. CLARK
 DESIGNED BY: T. SAMSON

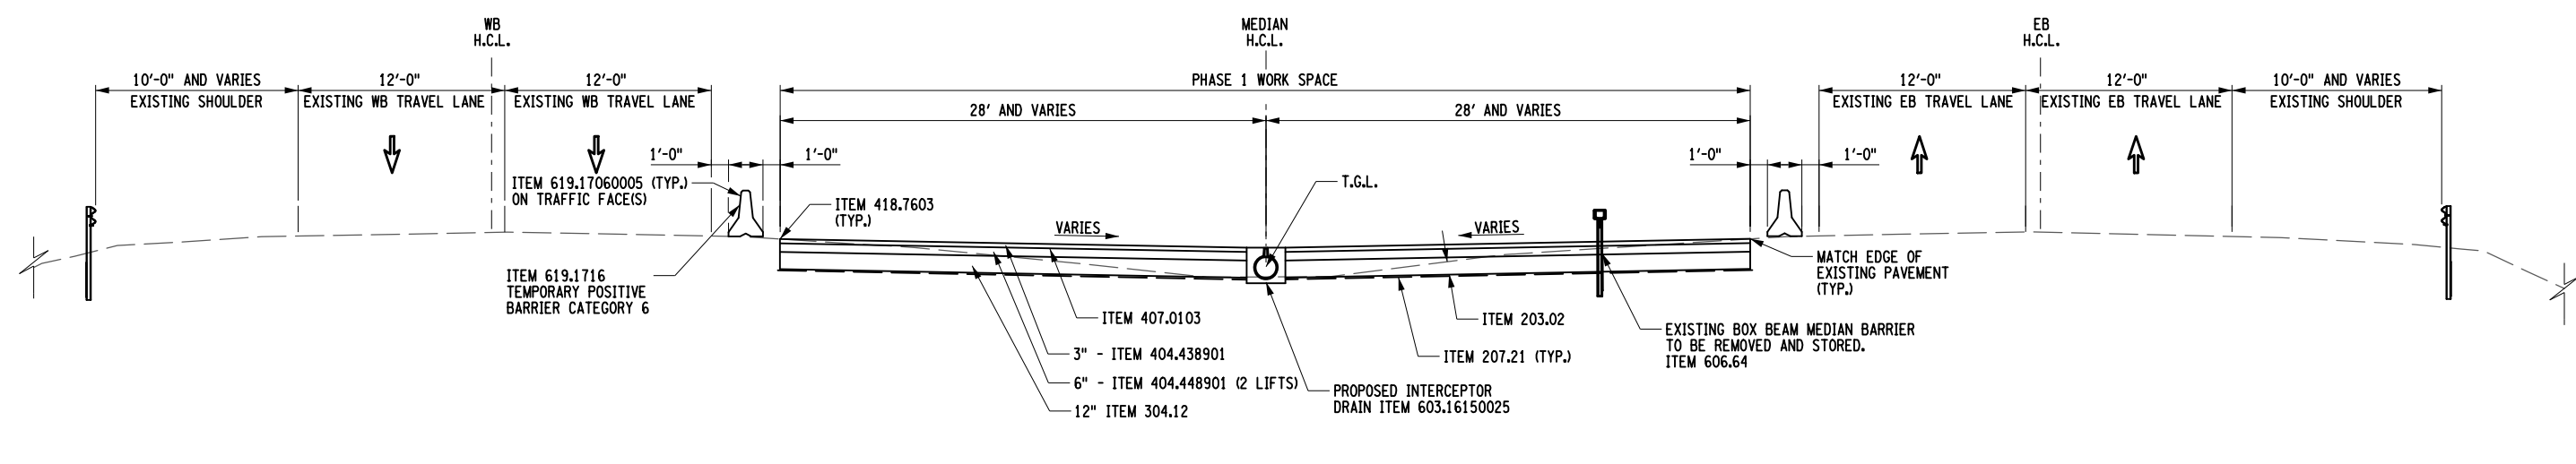

MAINLINE PHASE 1 - SECTION A-A
NOT TO SCALE

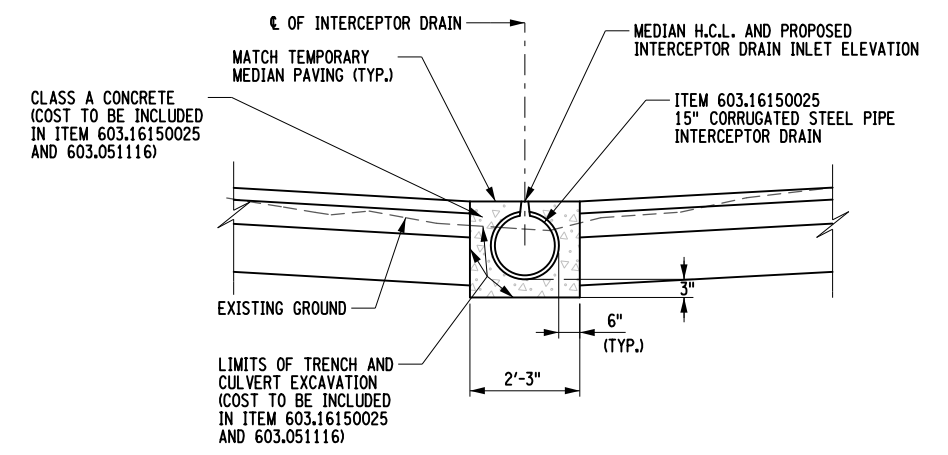

MEDIAN INTERCEPTOR DRAIN DETAIL

- NOTES:**
- INTERCEPTOR DRAIN SHALL BE RECESSED 1/2" BELOW ADJACENT CLASS A CONCRETE.
 - PIPE MAY BE BLOCKED UP WITH CONCRETE BLOCK OR BRICK TO ACHIEVE FINAL GRADE PRIOR TO CONCRETE PLACEMENT.
 - INTERCEPTOR DRAIN TO BE CONNECTED TO EXISTING CLOSED DRAINAGE SYSTEM. COST OF CONNECTION TO EXISTING DRAINAGE STRUCTURES TO BE INCLUDED IN ITEM 603.16150025. SEE DRAWING WZTC 1-2 THRU WZTC 1-6 FOR LOCATIONS.
 - CONTRACTOR TO INSTALL 5 LF SEGMENTS OF ITEM 603.051116, 15" CORRUGATED STEEL PIPE AT ENDS OF INTERCEPTOR DRAIN TO FACILITATE DRAINAGE STRUCTURE CONNECTION. CORRUGATED STEEL PIPE TO BE CONCRETE ENCASED SIMILAR TO INTERCEPTOR DRAIN. COST OF CLASS A CONCRETE TO BE INCLUDED IN UNIT PRICE BID FOR ITEM 603.051116.
 - SEE DRAINAGE TABLES ON DWG. WZTC 1-2.

ALTERED ON:	AFFIXED ON: 11/08/2023
SIGNATURE: STAMP:	SIGNATURE: STAMP:

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REVISIONS			
DATE	DESCRIPTION	BY	SYMBOL

 Thruway Authority	TITLE OF PROJECT STERLING CREEK BRIDGE REHABILITATION	CONTRACT NUMBER: TAS 24-5B
	LOCATION OF PROJECT SYRACUSE DIVISION BIN 5516091 & 5516092 MP 227.40 & MP 227.41	DATE: Nov. 2023
	TITLE OF DRAWING WORK ZONE TRAFFIC CONTROL PLAN-MAINLINE PHASE 1	DRAWING NUMBER: WZTC1-1

PROPOSED TEMPORARY DRAINAGE STRUCTURE TABLE

Table with columns: DR. NO., LOCATION (FROM, TO), STRUCTURE TYPE, WORK DESCRIPTION, and various pipe specifications (603.051116, 603.16150025, 603.171116, 604.070201, 621.03).

NOTE: ALTERING DRAINAGE STRUCTURES WILL OCCURE TWICE FOR EACH DRAINAGE STRUCTURE, ONCE TO ADJUST STRUCTURES TO PROPOSED PAVEMENT ELEVATIONS, AND THEN AGAIN TO RESTORE TO EXISTING CONDITIONS.

INTERCEPTOR DRAIN INLET ELEVATIONS

Table with columns: DR. NO., STATION, INVERT ELEVATION. Lists elevations for stations C 2+90.00 through C 16+80.71.

CMP PIPE INVERT ELEVATIONS

Table with columns: DR. NO., STATION, INVERT ELEVATION, NOTES. Includes notes like 'INSTALL END SECTION AND BEGIN 10 LF OF 15" CSP'.

NOTE: SEE DETAIL ON WZTC 1-1.

PAVED MEDIAN FLOW LINE ELEVATIONS

Table with columns: DR. NO., STATION, INVERT ELEVATION. Lists elevations for stations C 2+90.00 through C 16+80.71.

NOTE: SEE SECTION A-A ON WZTC 1-1 FOR T.G.L.

IT IS A VIOLATION OF LAW FOR ANY PERSON, UNLESS THEY ARE ACTING UNDER THE DIRECTION OF A LICENSED PROFESSIONAL ENGINEER, ARCHITECT, LANDSCAPE ARCHITECT, OR LAND SURVEYOR, TO ALTER AN ITEM IN ANY WAY...

TABLE OF HORIZONTAL ALIGNMENT

Table with columns: POINT, STATION, CURVE DATA, COORDINATE (NORTH, EAST). Includes data for EB CROSSOVER.

TABLE OF HORIZONTAL ALIGNMENT

Table with columns: POINT, STATION, CURVE DATA, COORDINATE (NORTH, EAST). Includes data for WB CROSSOVER.


Professional Engineer stamp for Daniel T. Clark, State of New York, License No. 095433. Includes fields for ALTERED ON, AFFIXED ON, SIGNATURE, and STAMP.

REVISIONS table with columns: DATE, DESCRIPTION, BY, SYM.

Logos for NEW YORK STATE OF OPPORTUNITY, Thruway Authority, and RAVI ENGINEERING & LAND SURVEYING, P.C.

Project information table including TITLE OF PROJECT (STERLING CREEK BRIDGE REHABILITATION), LOCATION OF PROJECT, CONTRACT NUMBER (TAS 24-5B), DATE (Nov. 2023), and DRAWING NUMBER (WZTC1-2).

PW/ CHECKED BY: R. PAPA/J.D. CLARK
 DRAFTED BY: T. SAMSON/W. DILONE
 CHECKED BY: D. CLARK
 DESIGNED BY: T. SAMSON
 DESIGN SUPERVISOR: R. PAPA/J

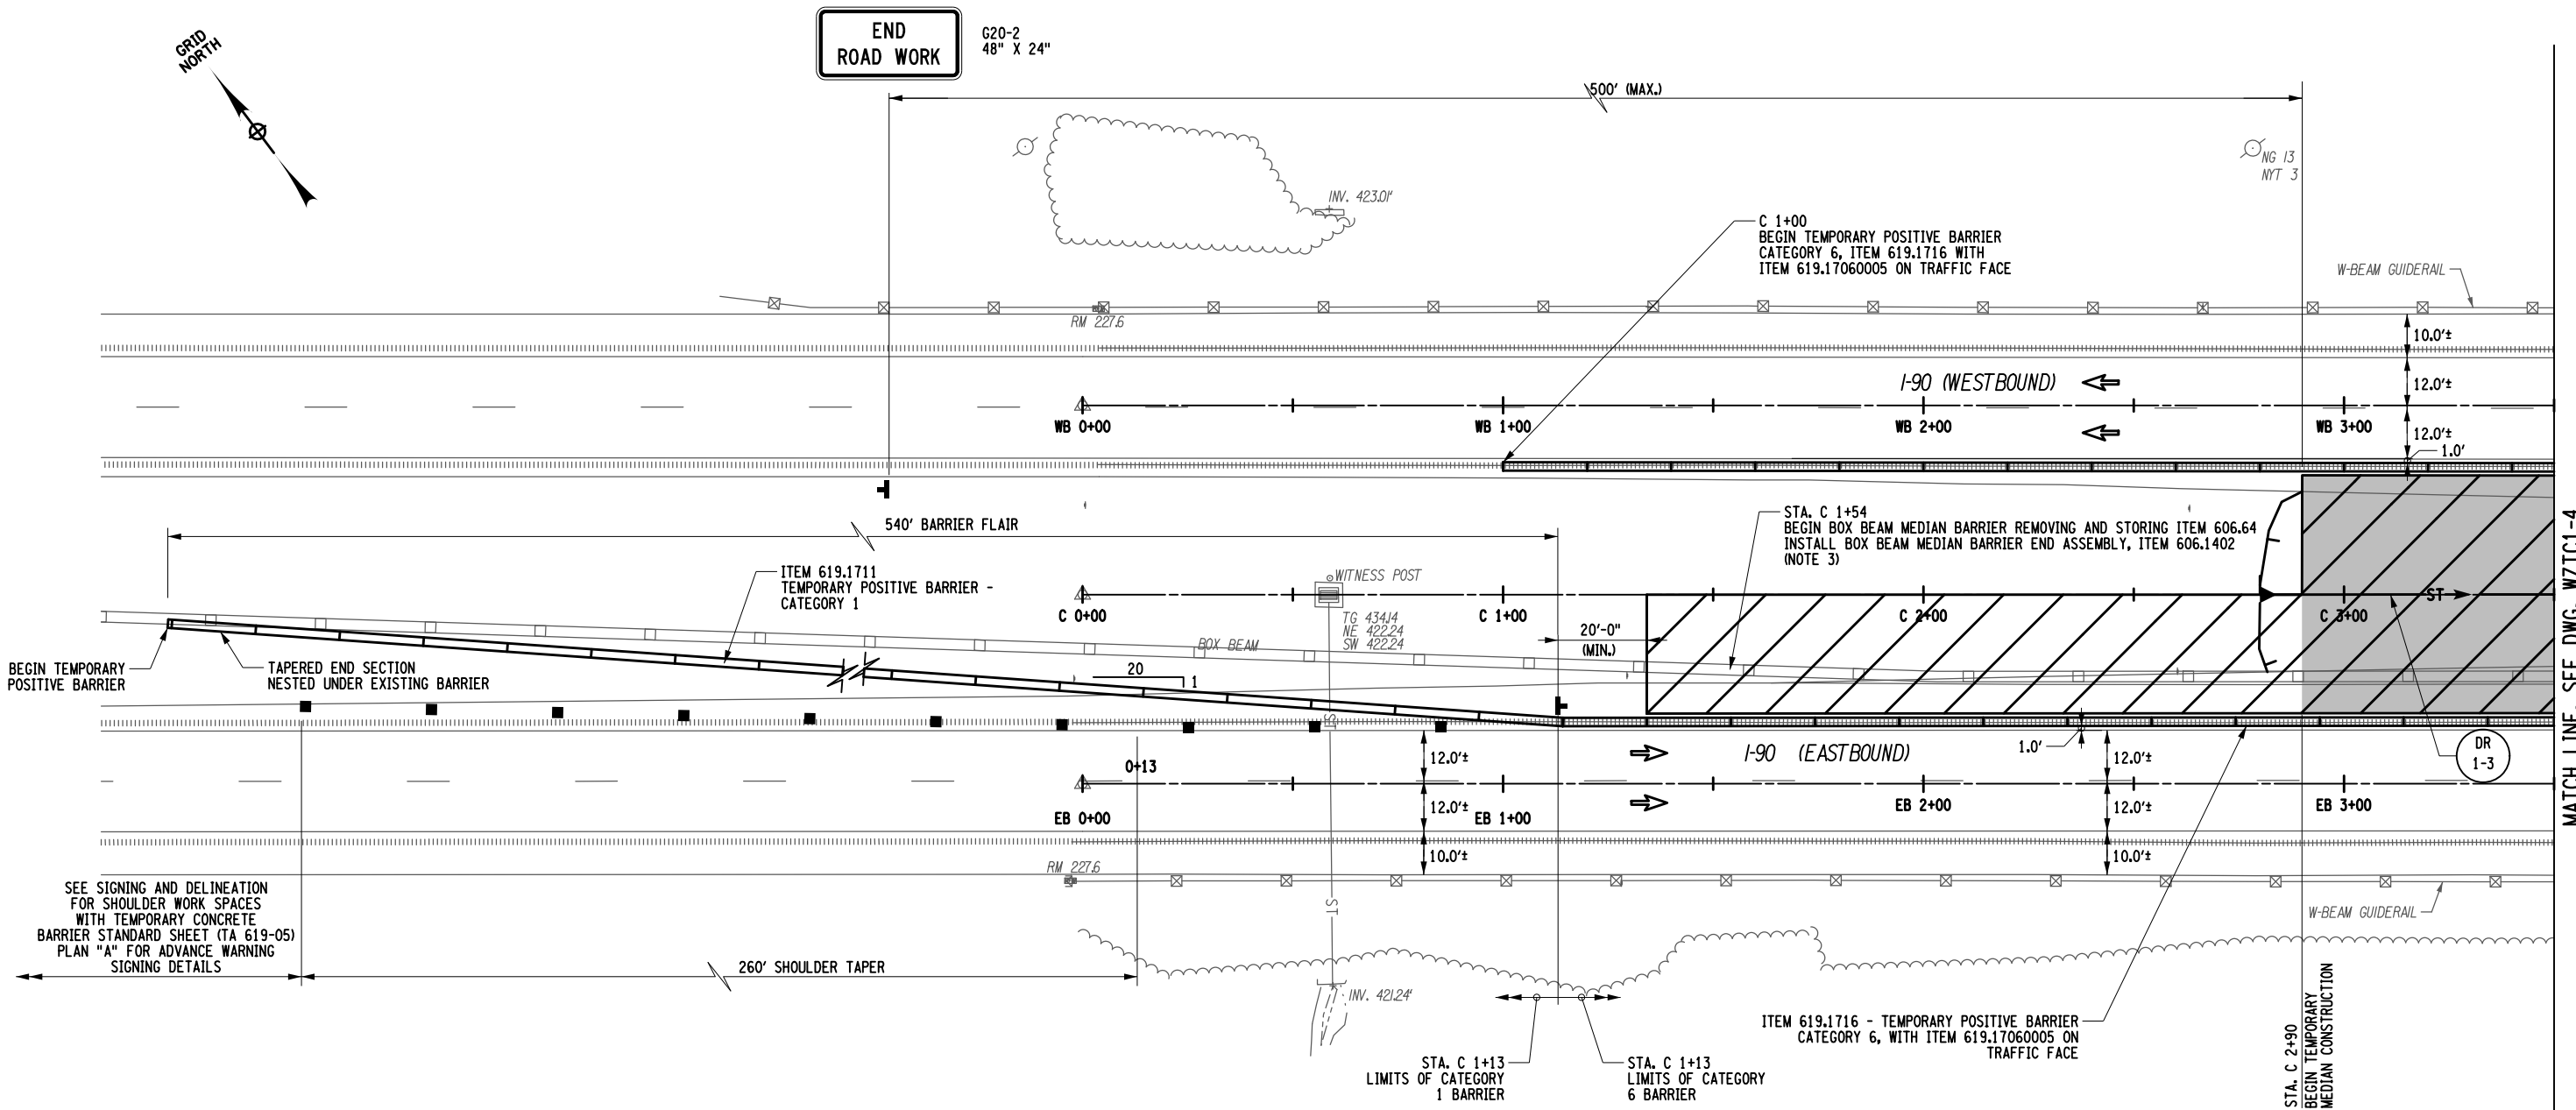

SEE SIGNING AND DELINEATION FOR SHOULDER WORK SPACES WITH TEMPORARY CONCRETE BARRIER STANDARD SHEET (TA 619-05) PLAN "A" FOR ADVANCE WARNING SIGNING DETAILS


MATCH LINE, SEE DWG. WZTC1-4

LEGEND

- CONSTRUCTION DRUM @ 40.0' O.C. (MAX.), ITEM 619.01
- ⊥ TEMPORARY SIGN, ITEM 619.01
- ➔ DIRECTION OF TRAFFIC
- ▨ PHASE 1 WORK SPACE
- PAVED MEDIAN CONSTRUCTION
- ▬ TEMPORARY POSITIVE BARRIER

NOTE:

- CONTRACTOR SHALL REMOVE EXISTING RUMBLE STRIPS, WHERE APPLICABLE - ITEM 649.2599--25.
- CONTRACTOR SHALL CLEAN DRAINAGE SYSTEM AND DRAINAGE STRUCTURES PRIOR TO TEMPORARY PAVING.
- CONTRACTOR SHALL INSTALL ANCHORAGE UNIT ON END OF EXISTING MEDIAN BARRIER WHEN PORTION OF MEDIAN BARRIER IS REMOVED. CONTRACTOR SHALL REMOVE ANCHORAGE UNIT WHEN THE PROPOSED MEDIAN BARRIER IS INSTALLED.

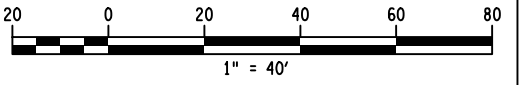

ALTERED ON: _____ AFFIXED ON: 11/30/2023

SIGNATURE: _____ SIGNATURE: _____

STAMP: _____ STAMP: _____

IT IS A VIOLATION OF LAW FOR ANY PERSON, UNLESS THEY ARE ACTING UNDER THE DIRECTION OF A LICENSED PROFESSIONAL ENGINEER, ARCHITECT, LANDSCAPE ARCHITECT, OR LAND SURVEYOR, TO ALTER AN ITEM IN ANY WAY. IF AN ITEM BEARING THE STAMP OF A LICENSED PROFESSIONAL IS ALTERED, THE ALTERING ENGINEER, ARCHITECT, LANDSCAPE ARCHITECT, OR LAND SURVEYOR SHALL STAMP THE DOCUMENT AND INCLUDE THE NOTATION "ALTERED BY" FOLLOWED BY THEIR SIGNATURE, THE DATE OF SUCH ALTERATION, AND A SPECIFIC DESCRIPTION OF THE ALTERATION.

REVISIONS			
DATE	DESCRIPTION	BY	SYM.

Thruway Authority

Ravi Engineering & Land Surveying, P.C.

TITLE OF PROJECT: STERLING CREEK BRIDGE REHABILITATION

LOCATION OF PROJECT: SYRACUSE DIVISION
BIN 5516091 & 5516092 MP 227.40 & MP 227.41



TITLE OF DRAWING: WORK ZONE TRAFFIC CONTROL PLAN-MAINLINE PHASE 1

CONTRACT NUMBER: TAS 24-5B

DATE: Nov. 2023

DRAWING NUMBER: WZTC1-3


PW/ R. PAPA, J.D. CLARK
 CHECKED BY: R. PAPA, J.D. CLARK
 DRAFTED BY: T. SAMSON, W. DILONE
 CHECKED BY: D. CLARK
 DESIGNED BY: T. SAMSON

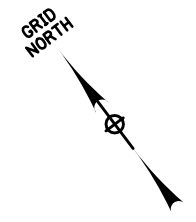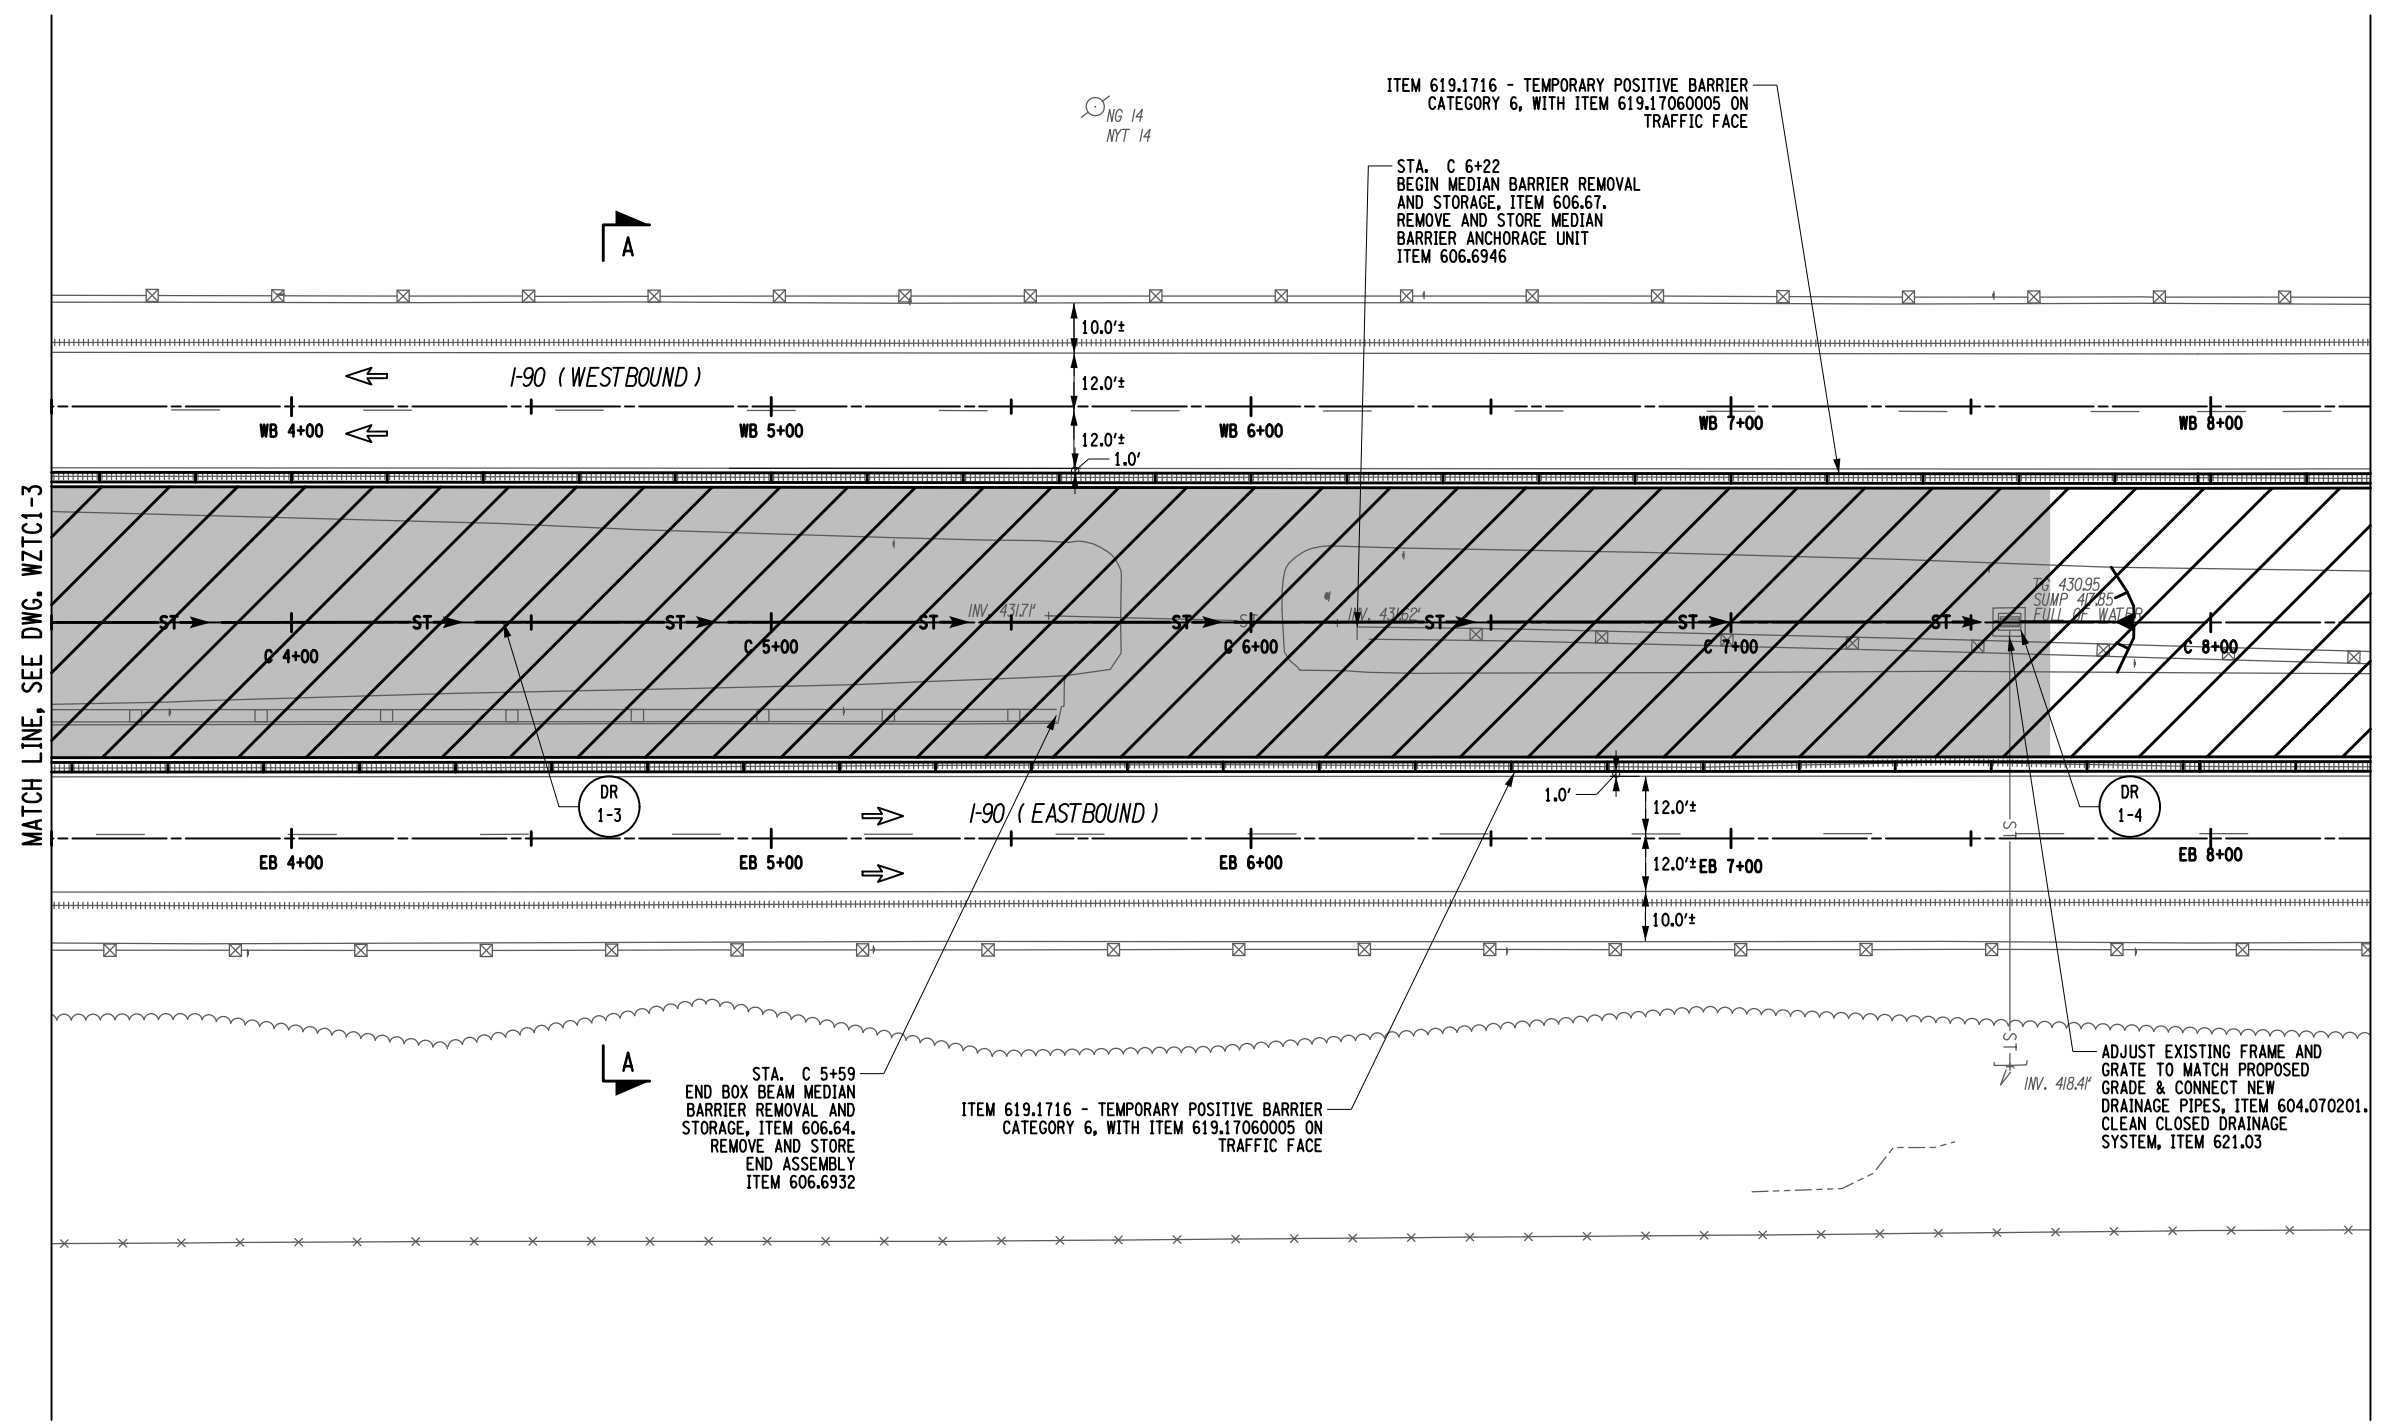

MATCH LINE, SEE DWG. WZTC1-3

MATCH LINE, SEE DWG. WZTC1-5

LEGEND	
	CONSTRUCTION DRUM Ø 40.0' O.C. (MAX.), ITEM 619.01
	TEMPORARY SIGN, ITEM 619.01
	DIRECTION OF TRAFFIC
	PHASE 1 WORK SPACE
	PAVED MEDIAN CONSTRUCTION
	TEMPORARY POSITIVE BARRIER

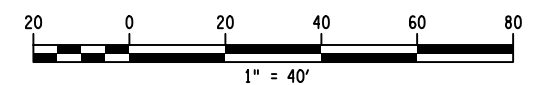

ALTERED ON:	AFFIXED ON: 11/08/2023
SIGNATURE: STAMP:	SIGNATURE: STAMP:

- NOTE:**
- CONTRACTOR SHALL REMOVE EXISTING RUMBLE STRIPS (ITEM 649.2599--25), WHERE APPLICABLE.
 - CONTRACTOR SHALL CLEAN DRAINAGE SYSTEM AND DRAINAGE STRUCTURES PRIOR TO TEMPORARY PAVING.

IT IS A VIOLATION OF LAW FOR ANY PERSON, UNLESS THEY ARE ACTING UNDER THE DIRECTION OF A LICENSED PROFESSIONAL ENGINEER, ARCHITECT, LANDSCAPE ARCHITECT, OR LAND SURVEYOR, TO ALTER AN ITEM IN ANY WAY. IF AN ITEM BEARING THE STAMP OF A LICENSED PROFESSIONAL IS ALTERED, THE ALTERING ENGINEER, ARCHITECT, LANDSCAPE ARCHITECT, OR LAND SURVEYOR SHALL STAMP THE DOCUMENT AND INCLUDE THE NOTATION "ALTERED BY" FOLLOWED BY THEIR SIGNATURE, THE DATE OF SUCH ALTERATION, AND A SPECIFIC DESCRIPTION OF THE ALTERATION.


REVISIONS			
DATE	DESCRIPTION	BY	SYM.

Thruway Authority


Ravi Engineering & Land Surveying, P.C.

TITLE OF PROJECT STERLING CREEK BRIDGE REHABILITATION	CONTRACT NUMBER: TAS 24-5B
LOCATION OF PROJECT SYRACUSE DIVISION BIN 5516091 & 5516092 MP 227.40 & MP 227.41	DATE: Nov. 2023
TITLE OF DRAWING WORK ZONE TRAFFIC CONTROL PLAN-MAINLINE PHASE 1	DRAWING NUMBER: WZTC1-4

PW/ R. PAPA, J.D. CLARK
 CHECKED BY: T. SAMSON, W. DILONE
 DRAFTED BY: D. CLARK
 CHECKED BY: T. SAMSON
 DESIGN SUPERVISOR: R. PAPA, J.D. CLARK

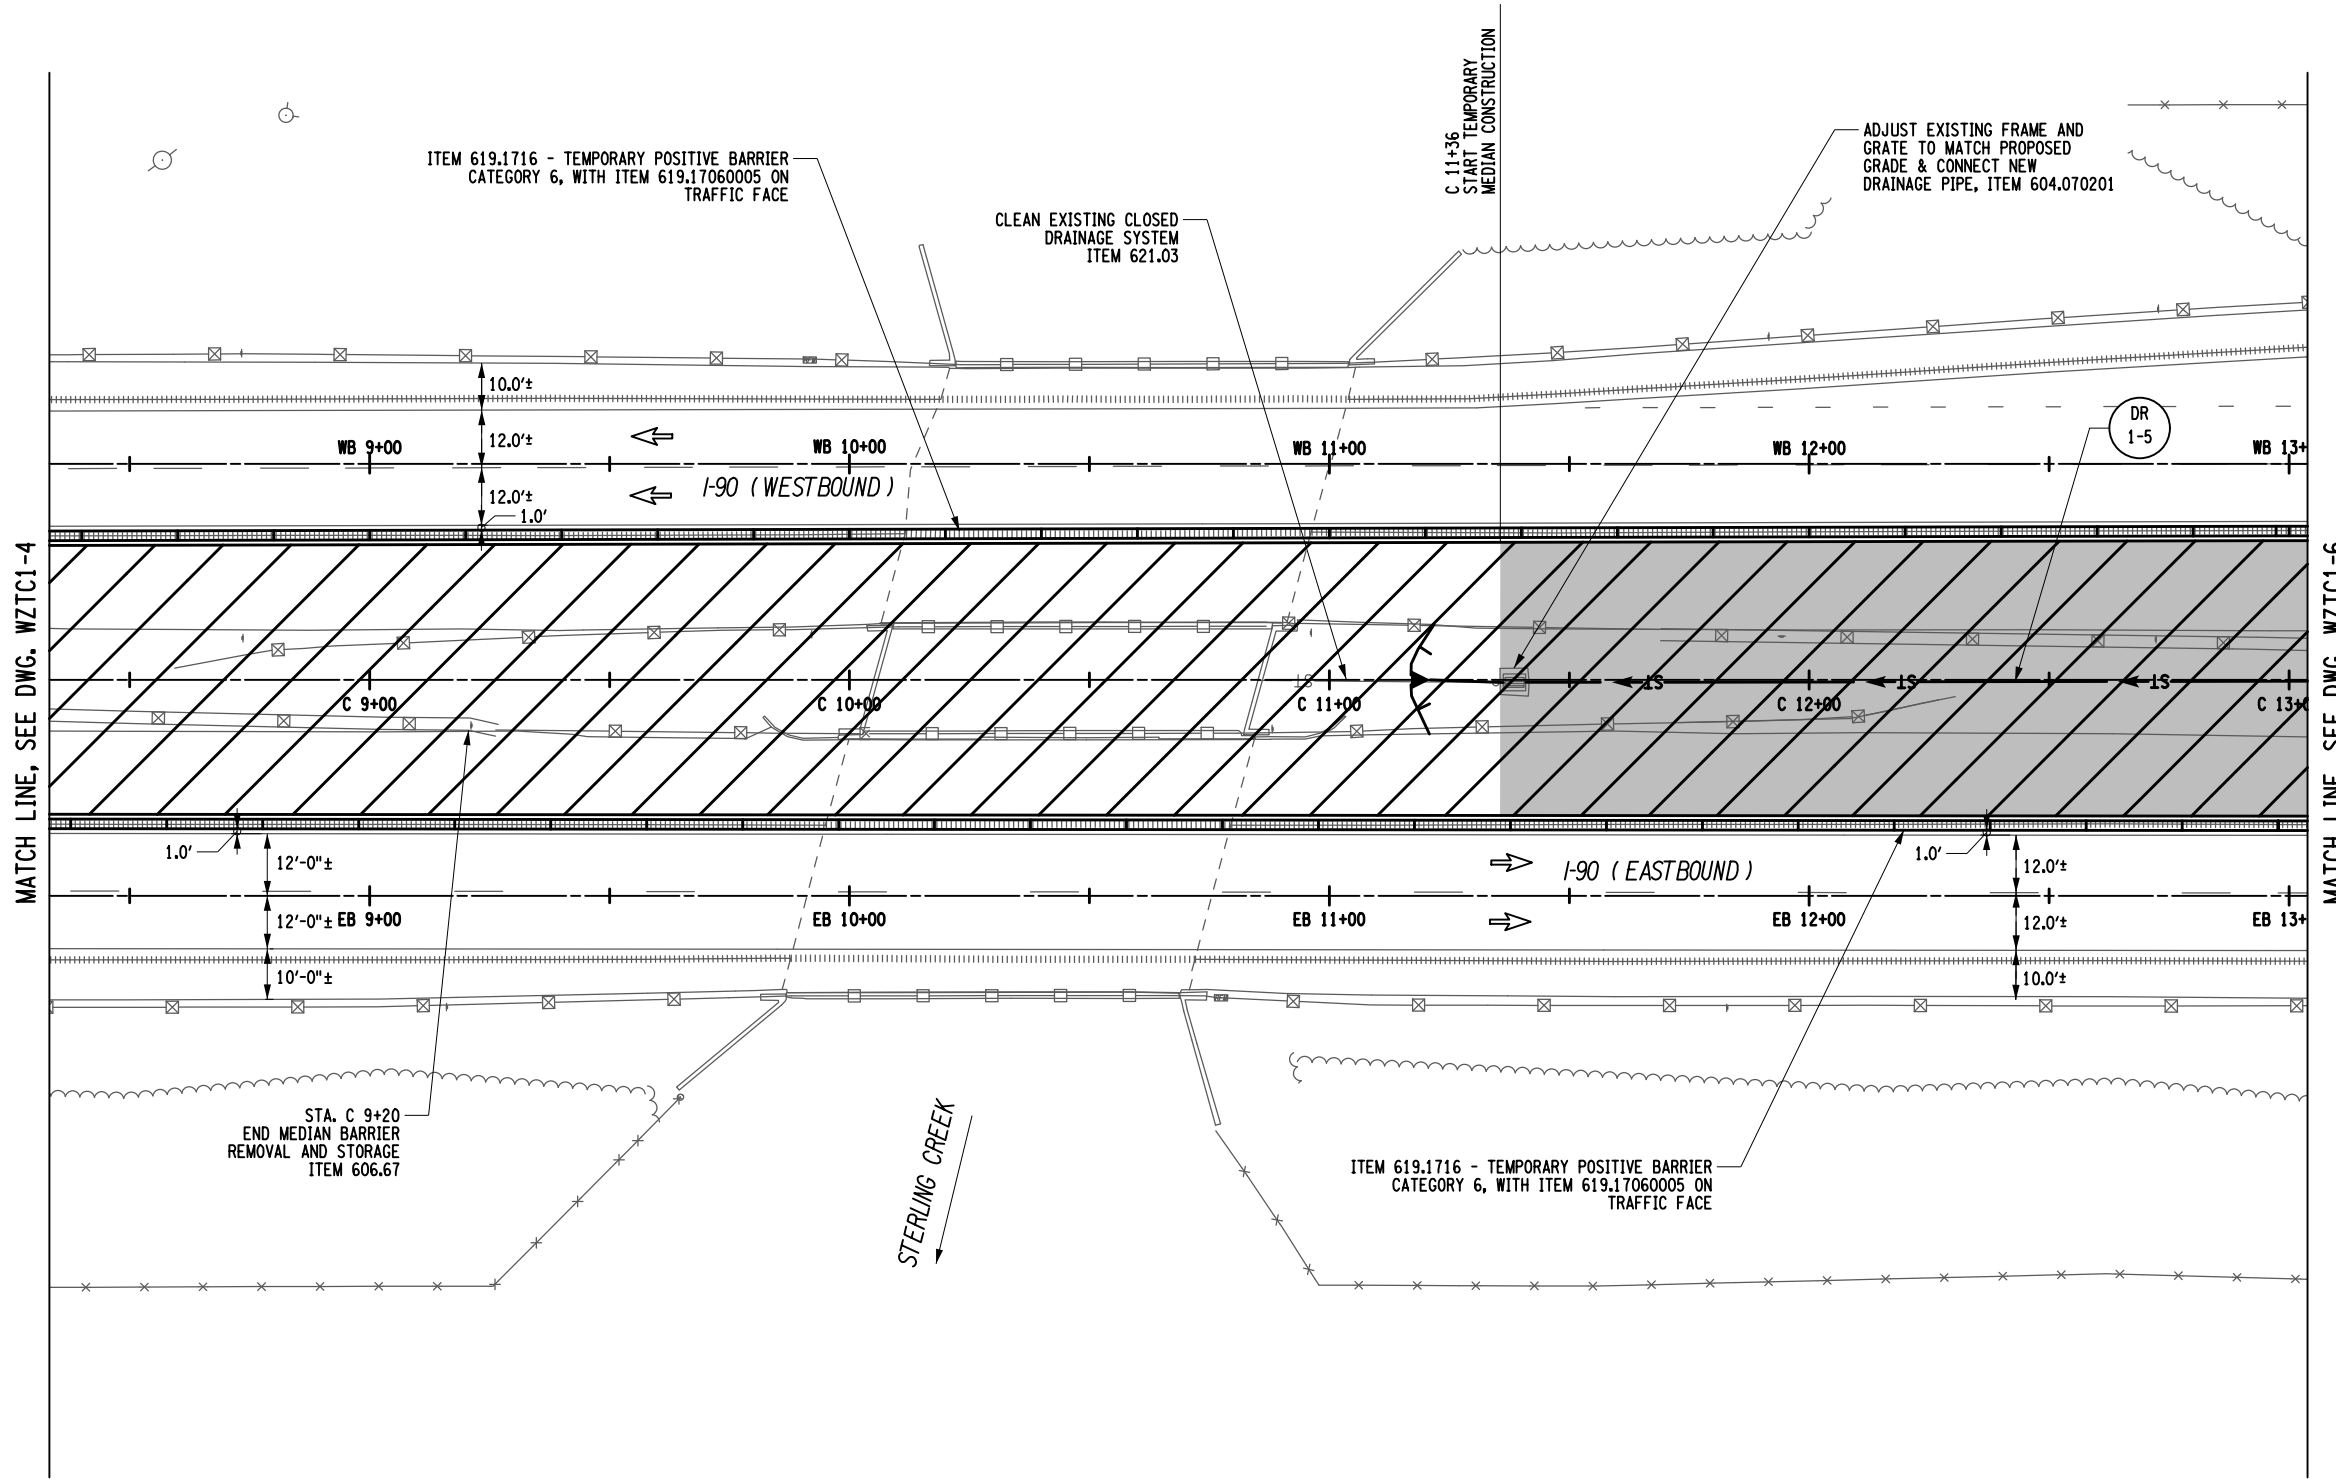

LEGEND	
	CONSTRUCTION DRUM @ 40.0' O.C. (MAX.), ITEM 619.01
	TEMPORARY SIGN, ITEM 619.01
	DIRECTION OF TRAFFIC
	PHASE 1 WORK SPACE
	PAVED MEDIAN CONSTRUCTION
	TEMPORARY POSITIVE BARRIER

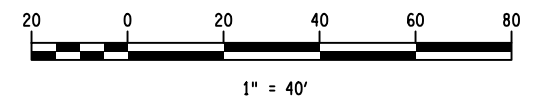

- NOTE:**
- CONTRACTOR SHALL REMOVE EXISTING RUMBLE STRIPS (ITEM 649.2599--25), WHERE APPLICABLE.
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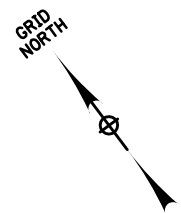
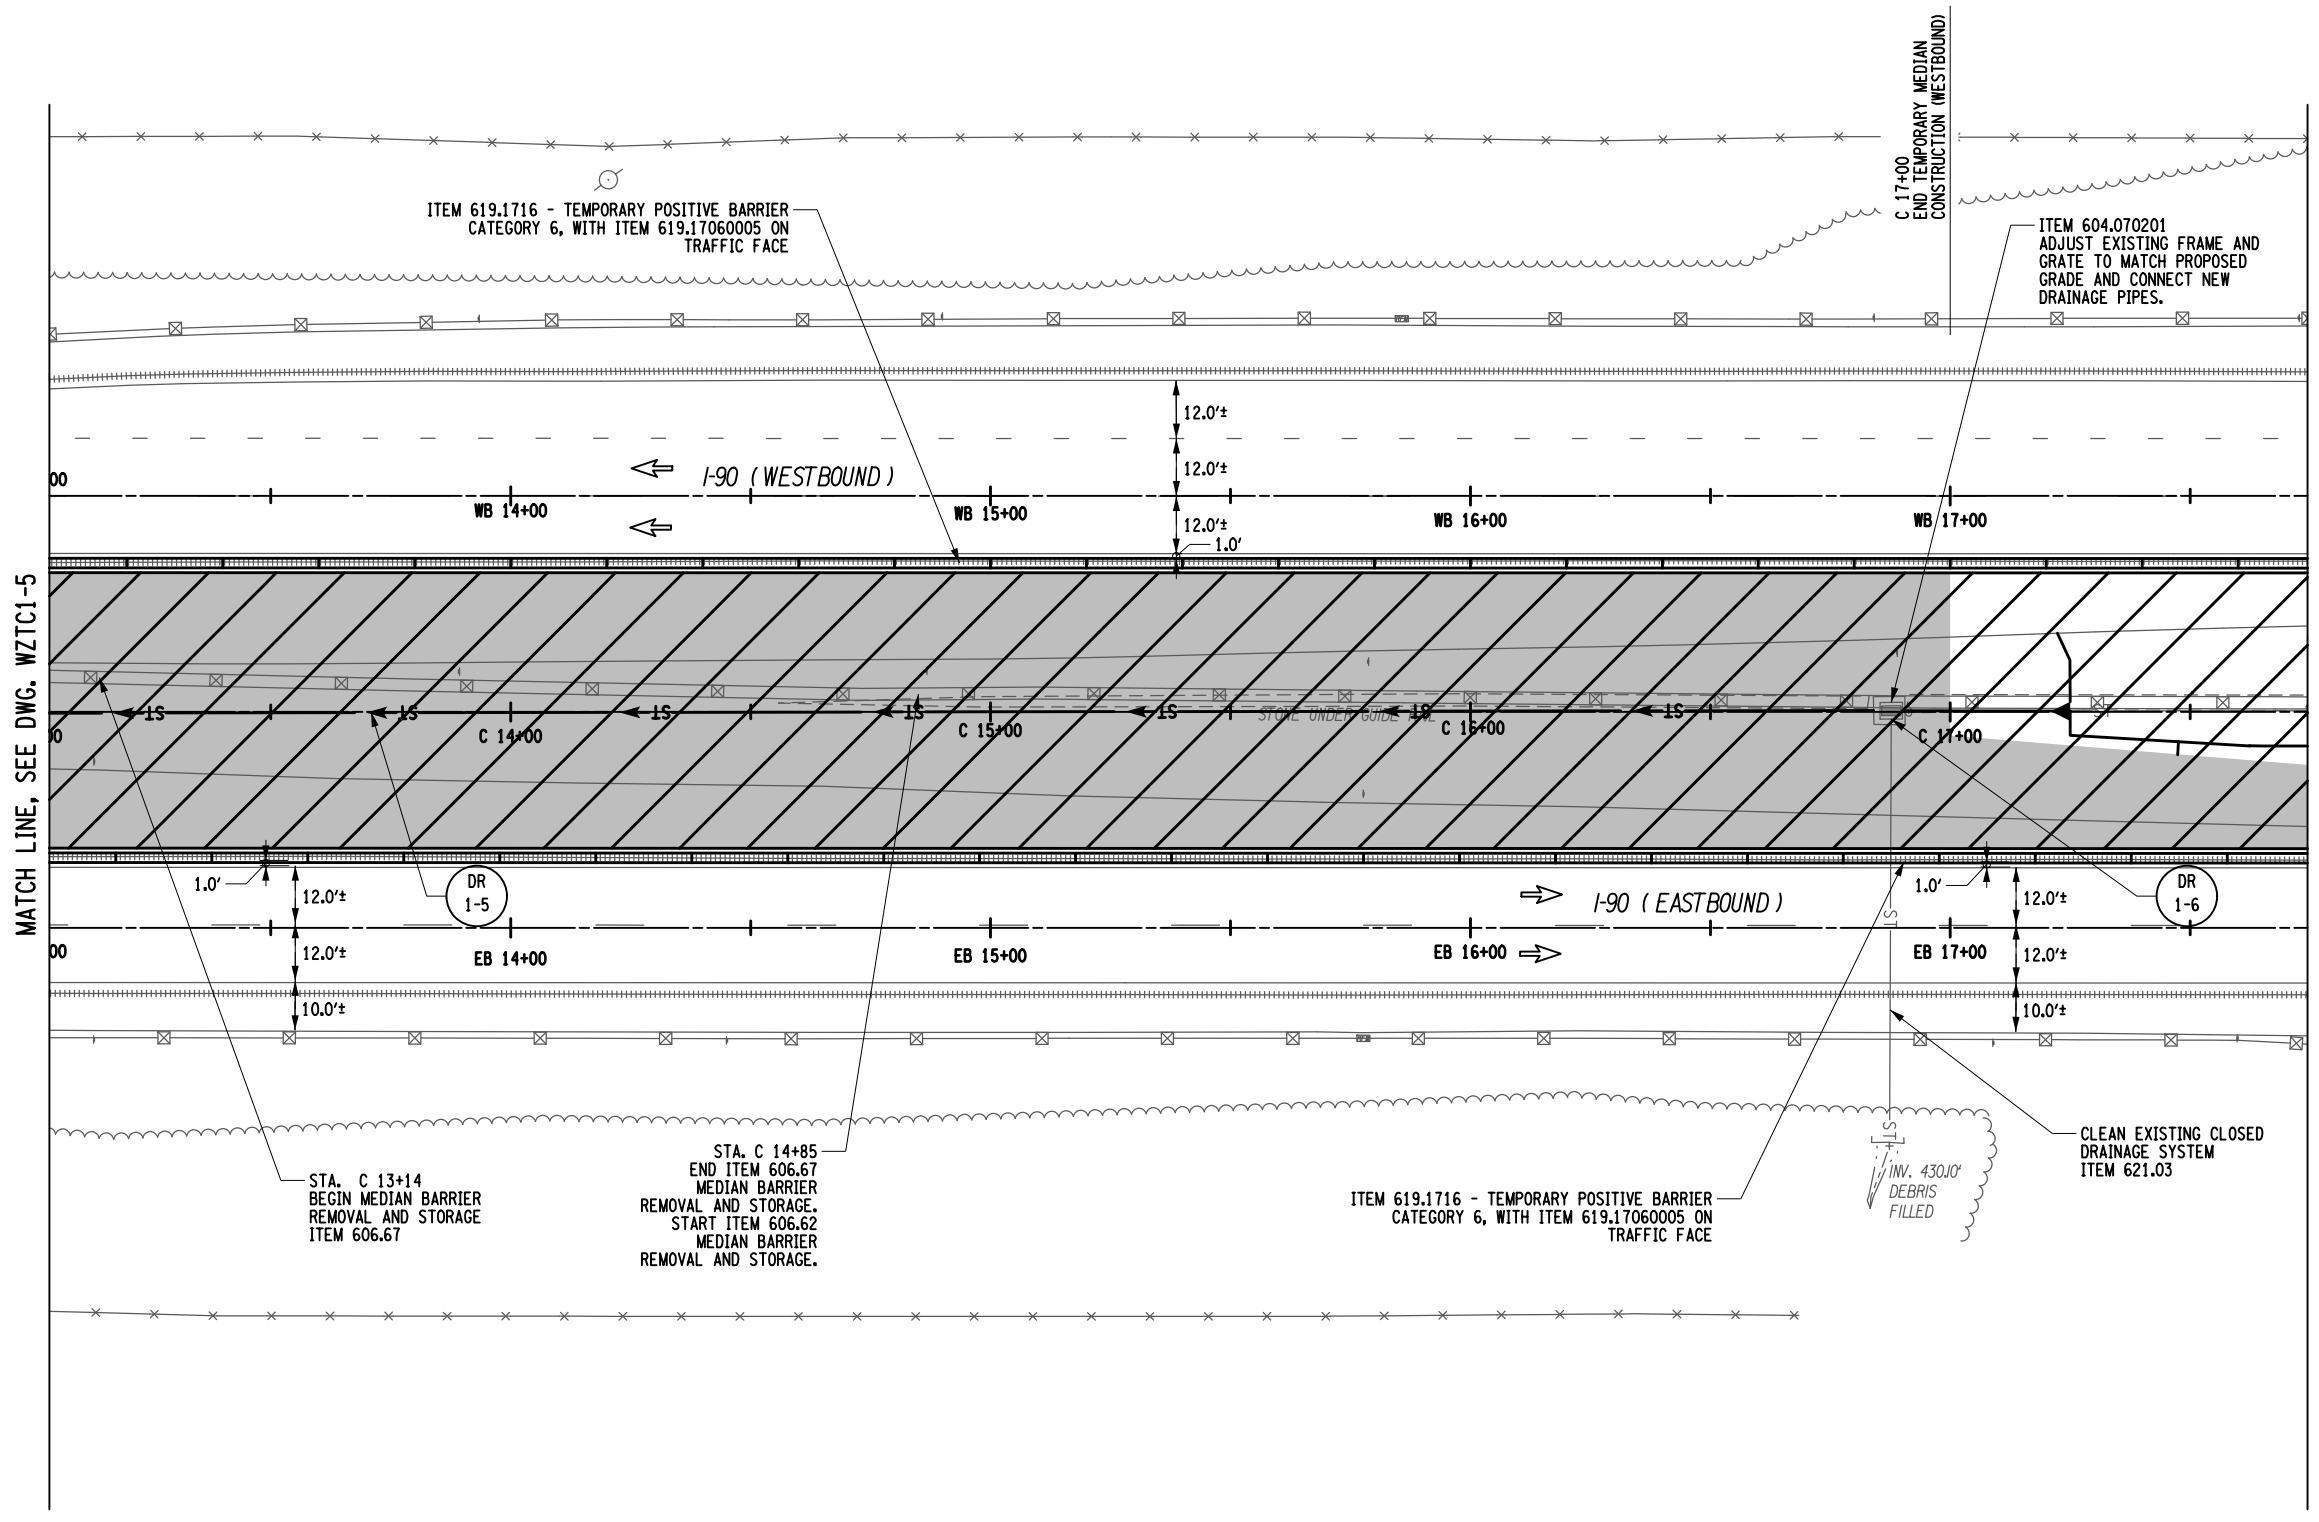
REVISIONS			
DATE	DESCRIPTION	BY	SYM.



TITLE OF PROJECT STERLING CREEK BRIDGE REHABILITATION	CONTRACT NUMBER: TAS 24-5B
LOCATION OF PROJECT SYRACUSE DIVISION BIN 5516091 & 5516092 MP 227.40 & MP 227.41	DATE: Nov. 2023
TITLE OF DRAWING WORK ZONE TRAFFIC CONTROL PLAN-MAINLINE PHASE 1	DRAWING NUMBER: WZTC1-5




PW/ R. PAPA/J.D. CLARK
 CHECKED BY: R. PAPA/J.D. CLARK
 DRAFTED BY: T. SAMSON/W. DILONE
 CHECKED BY: T. SAMSON/W. DILONE
 D. CLARK
 CHECKED BY: D. CLARK
 T. SAMSON
 DESIGNED BY: T. SAMSON



MATCH LINE, SEE DWG. WZTC1-5

MATCH LINE, SEE DWG. WZTC1-7

LEGEND	
	CONSTRUCTION DRUM @ 40.0' O.C. (MAX.), ITEM 619.01
	TEMPORARY SIGN, ITEM 619.01
	DIRECTION OF TRAFFIC
	PHASE 1 WORK SPACE
	PAVED MEDIAN CONSTRUCTION
	TEMPORARY POSITIVE BARRIER

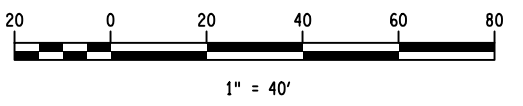

ALTERED ON:	AFFIXED ON: 11/08/2023
SIGNATURE: STAMP:	SIGNATURE: STAMP:


- NOTE:**
- CONTRACTOR SHALL REMOVE EXISTING RUMBLE STRIPS (ITEM 649.2599--25), WHERE APPLICABLE.
 - CONTRACTOR SHALL CLEAN DRAINAGE SYSTEM AND DRAINAGE STRUCTURES PRIOR TO TEMPORARY PAVING.

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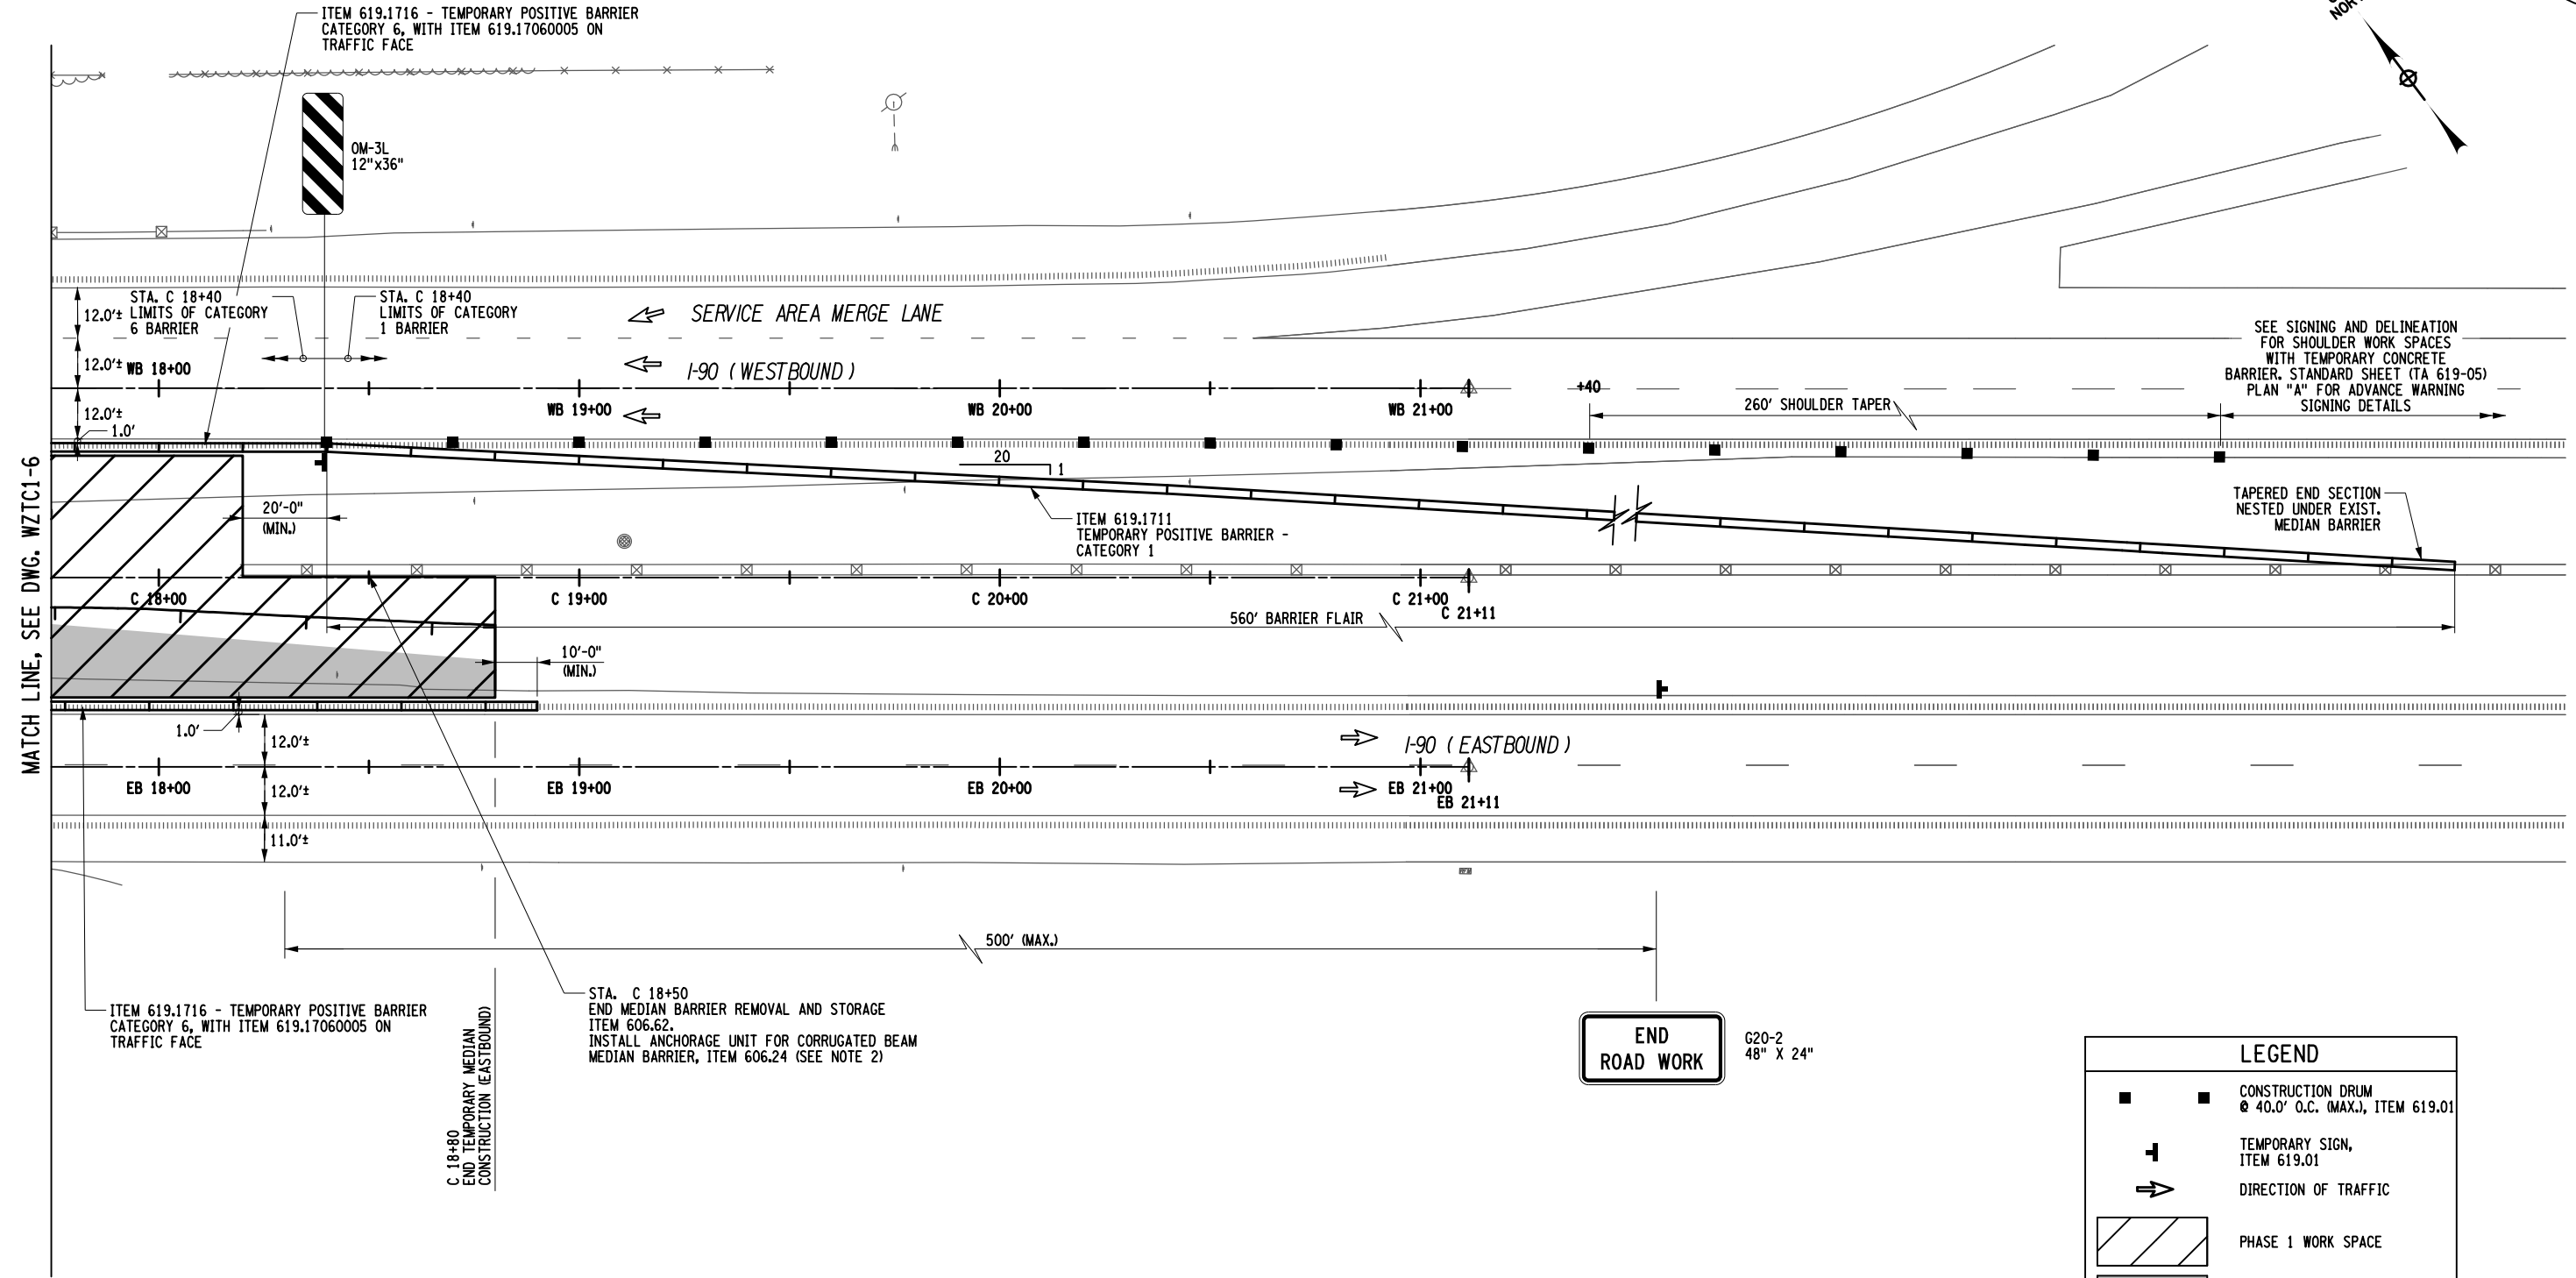
REVISIONS			
DATE	DESCRIPTION	BY	SYM.




TITLE OF PROJECT STERLING CREEK BRIDGE REHABILITATION	CONTRACT NUMBER: TAS 24-5B
LOCATION OF PROJECT SYRACUSE DIVISION BIN 5516091 & 5516092 MP 227.40 & MP 227.41	DATE: Nov. 2023
TITLE OF DRAWING WORK ZONE TRAFFIC CONTROL PLAN-MAINLINE PHASE 1	DRAWING NUMBER: WZTC1-6

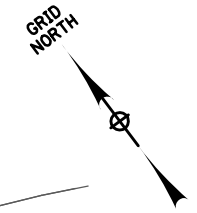

PW/ R. PAPA, J.D. CLARK
 CHECKED BY: R. PAPA, J.D. CLARK
 DRAFTED BY: T. SAMSON, W. DILONE
 CHECKED BY: D. CLARK
 DESIGNED BY: T. SAMSON



LEGEND	
	CONSTRUCTION DRUM @ 40.0' O.C. (MAX.), ITEM 619.01
	TEMPORARY SIGN, ITEM 619.01
	DIRECTION OF TRAFFIC
	PHASE 1 WORK SPACE
	PAVED MEDIAN CONSTRUCTION
	TEMPORARY POSITIVE BARRIER

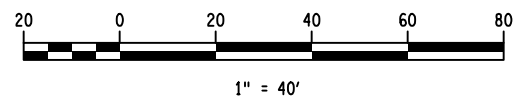

- NOTE:**
- CONTRACTOR SHALL REMOVE EXISTING RUMBLE STRIPS (ITEM 649.2599--25), WHERE APPLICABLE.
 - CONTRACTOR SHALL INSTALL ANCHORAGE UNIT ON END OF EXISTING MEDIAN BARRIER WHEN PORTION OF MEDIAN BARRIER IS REMOVED. CONTRACTOR SHALL REMOVE ANCHORAGE UNIT WHEN PROPOSED MEDIAN BARRIER IS INSTALLED. COST OF REMOVAL AND STORAGE OF ANCHORAGE UNIT TO BE INCLUDED IN ITEM 606.6910.

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REVISIONS			
DATE	DESCRIPTION	BY	SYM.



TITLE OF PROJECT
STERLING CREEK BRIDGE REHABILITATION

LOCATION OF PROJECT
SYRACUSE DIVISION
BIN 5516091 & 5516092 MP 227.40 & MP 227.41

TITLE OF DRAWING
WORK ZONE TRAFFIC CONTROL
PLAN-MAINLINE PHASE 1

CONTRACT NUMBER:
TAS 24-5B

DATE:
Nov. 2023

DRAWING NUMBER:
WZTC1-7


ALTERED ON:
11/30/2023

SIGNATURE:
STAMP:


AFFIXED ON:
11/30/2023

SIGNATURE:
STAMP:

PW/ R. PAPA, J. CLARK
 CHECKED BY: R. PAPA, J. CLARK
 T. SAMSON, W. DILONE
 DRAFTED BY: T. SAMSON, W. DILONE
 D. CLARK
 CHECKED BY: D. CLARK
 T. SAMSON
 DESIGNED BY: T. SAMSON
 R. PAPA, J. CLARK
 DESIGN SUPERVISOR: R. PAPA, J. CLARK

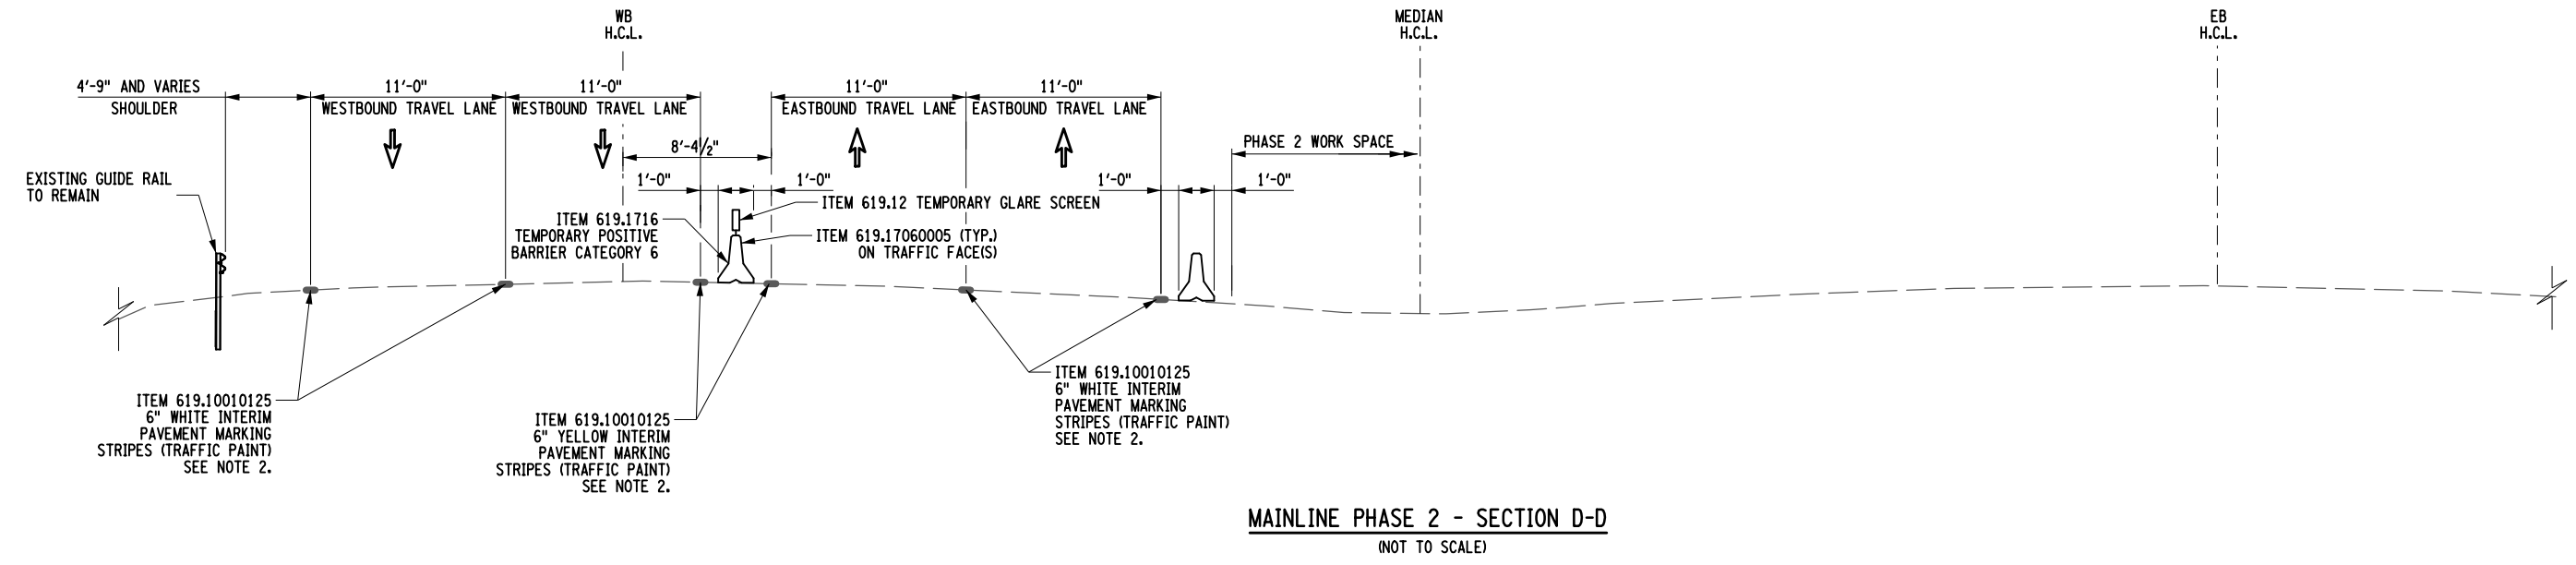

MAINLINE PHASE 2 - SECTION D-D
(NOT TO SCALE)

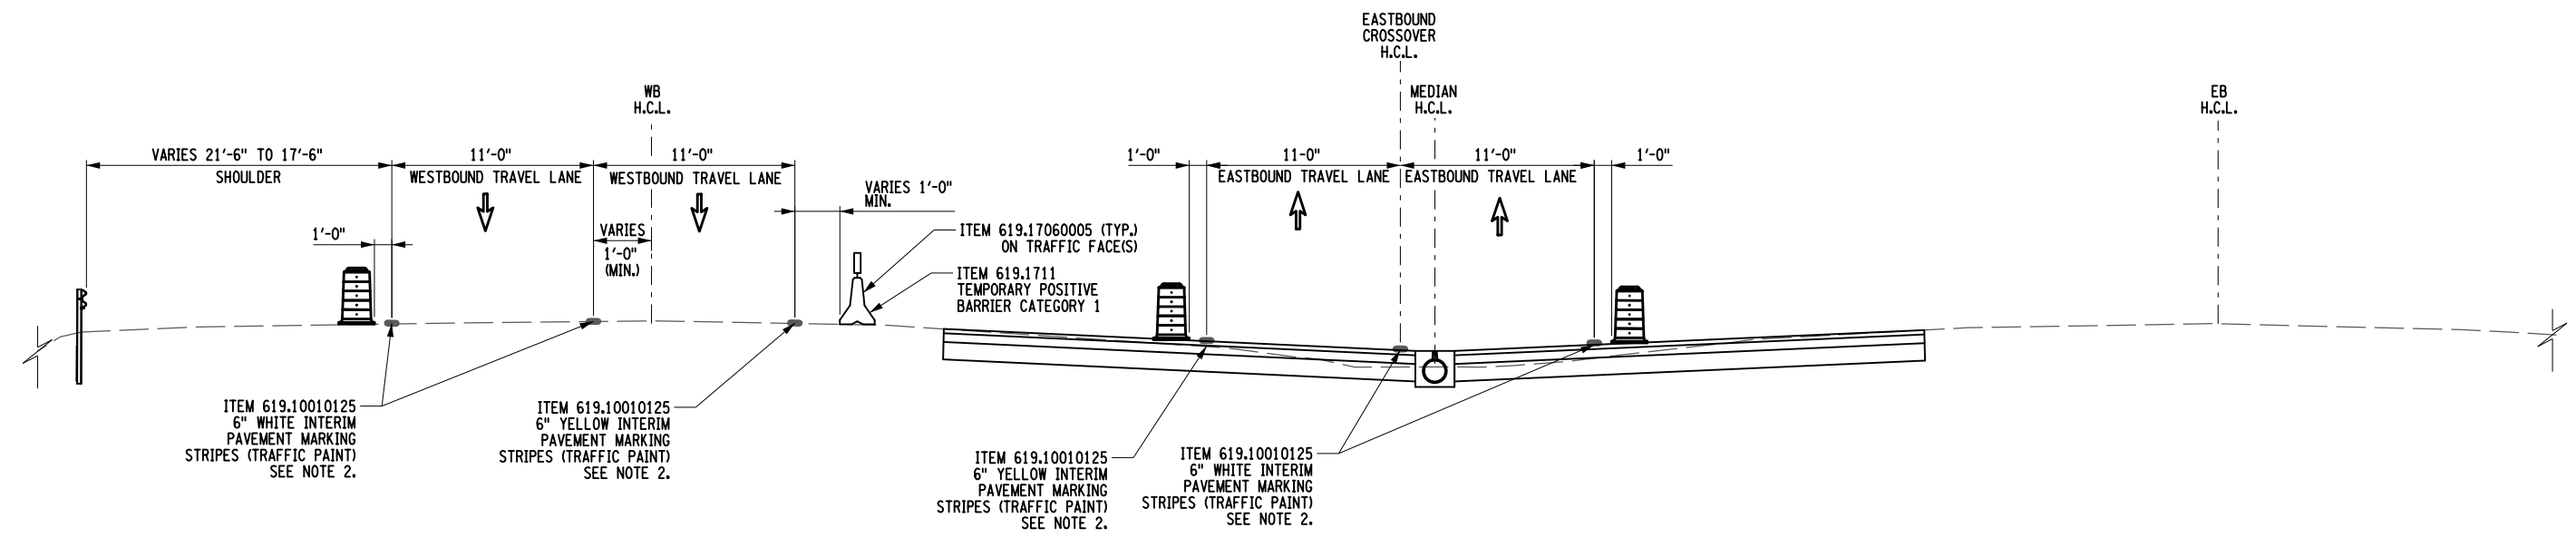

MAINLINE PHASE 2 - EASTBOUND CROSSOVER - SECTION E-E
(NOT TO SCALE)

ALTERED ON:	AFFIXED ON: 11/08/2023
SIGNATURE: STAMP:	SIGNATURE: STAMP:

IT IS A VIOLATION OF LAW FOR ANY PERSON, UNLESS THEY ARE ACTING UNDER THE DIRECTION OF A LICENSED PROFESSIONAL ENGINEER, ARCHITECT, LANDSCAPE ARCHITECT, OR LAND SURVEYOR, TO ALTER AN ITEM IN ANY WAY. IF AN ITEM BEARING THE STAMP OF A LICENSED PROFESSIONAL IS ALTERED, THE ALTERING ENGINEER, ARCHITECT, LANDSCAPE ARCHITECT, OR LAND SURVEYOR SHALL STAMP THE DOCUMENT AND INCLUDE THE NOTATION "ALTERED BY" FOLLOWED BY THEIR SIGNATURE, THE DATE OF SUCH ALTERATION, AND A SPECIFIC DESCRIPTION OF THE ALTERATION.


REVISIONS			
DATE	DESCRIPTION	BY	SYM.




RAVI ENGINEERING & LAND SURVEYING, P.C.

TITLE OF PROJECT STERLING CREEK BRIDGE REHABILITATION	CONTRACT NUMBER: TAS 24-5B
LOCATION OF PROJECT SYRACUSE DIVISION BIN 5516091 & 5516092 MP 227.40 & MP 227.41	DATE: Nov. 2023
TITLE OF DRAWING WORK ZONE TRAFFIC CONTROL PLAN-MAINLINE PHASE 2	DRAWING NUMBER: WZTC2-1

- NOTES:
- CONTRACTOR SHALL PIN TEMPORARY POSITIVE BARRIER TO EXISTING BRIDGE DECK. CONTRACTOR SHALL NOT PIN TEMPORARY POSITIVE BARRIER TO PROPOSED BRIDGE DECK, APPROACH SLAB, OR FINISHED ASPHALT SURFACE. UNDER THESE SITUATIONS THE CONTRACTOR SHALL INSTALL ITEM 619.1715 TEMPORARY BARRIER CATEGORY 5.
 - CONTRACTOR SHALL REPLACE ITEM 619.10010125, INTERIM PAVEMENT MARKING STRIPES (TRAFFIC PAINT), WITH ITEM 619.100104, INTERIM PAVEMENT MARKING STRIPES (REMOVABLE WET REFLECTIVE TAPE), WHEN PAVEMENT MARKINGS ARE APPLIED TO THE PROPOSED BRIDGE DECK, APPROACH SLAB, OR FINISHED ASPHALT SURFACE.

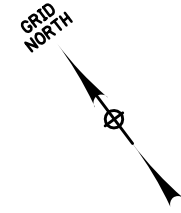

PW/ CHECKED BY: R. PAPAUD, CLARK DRAFTED BY: T. SAMSON/W. DILONE CHECKED BY: D. CLARK DESIGNED BY: T. SAMSON DESIGN SUPERVISOR: R. PAPAJ

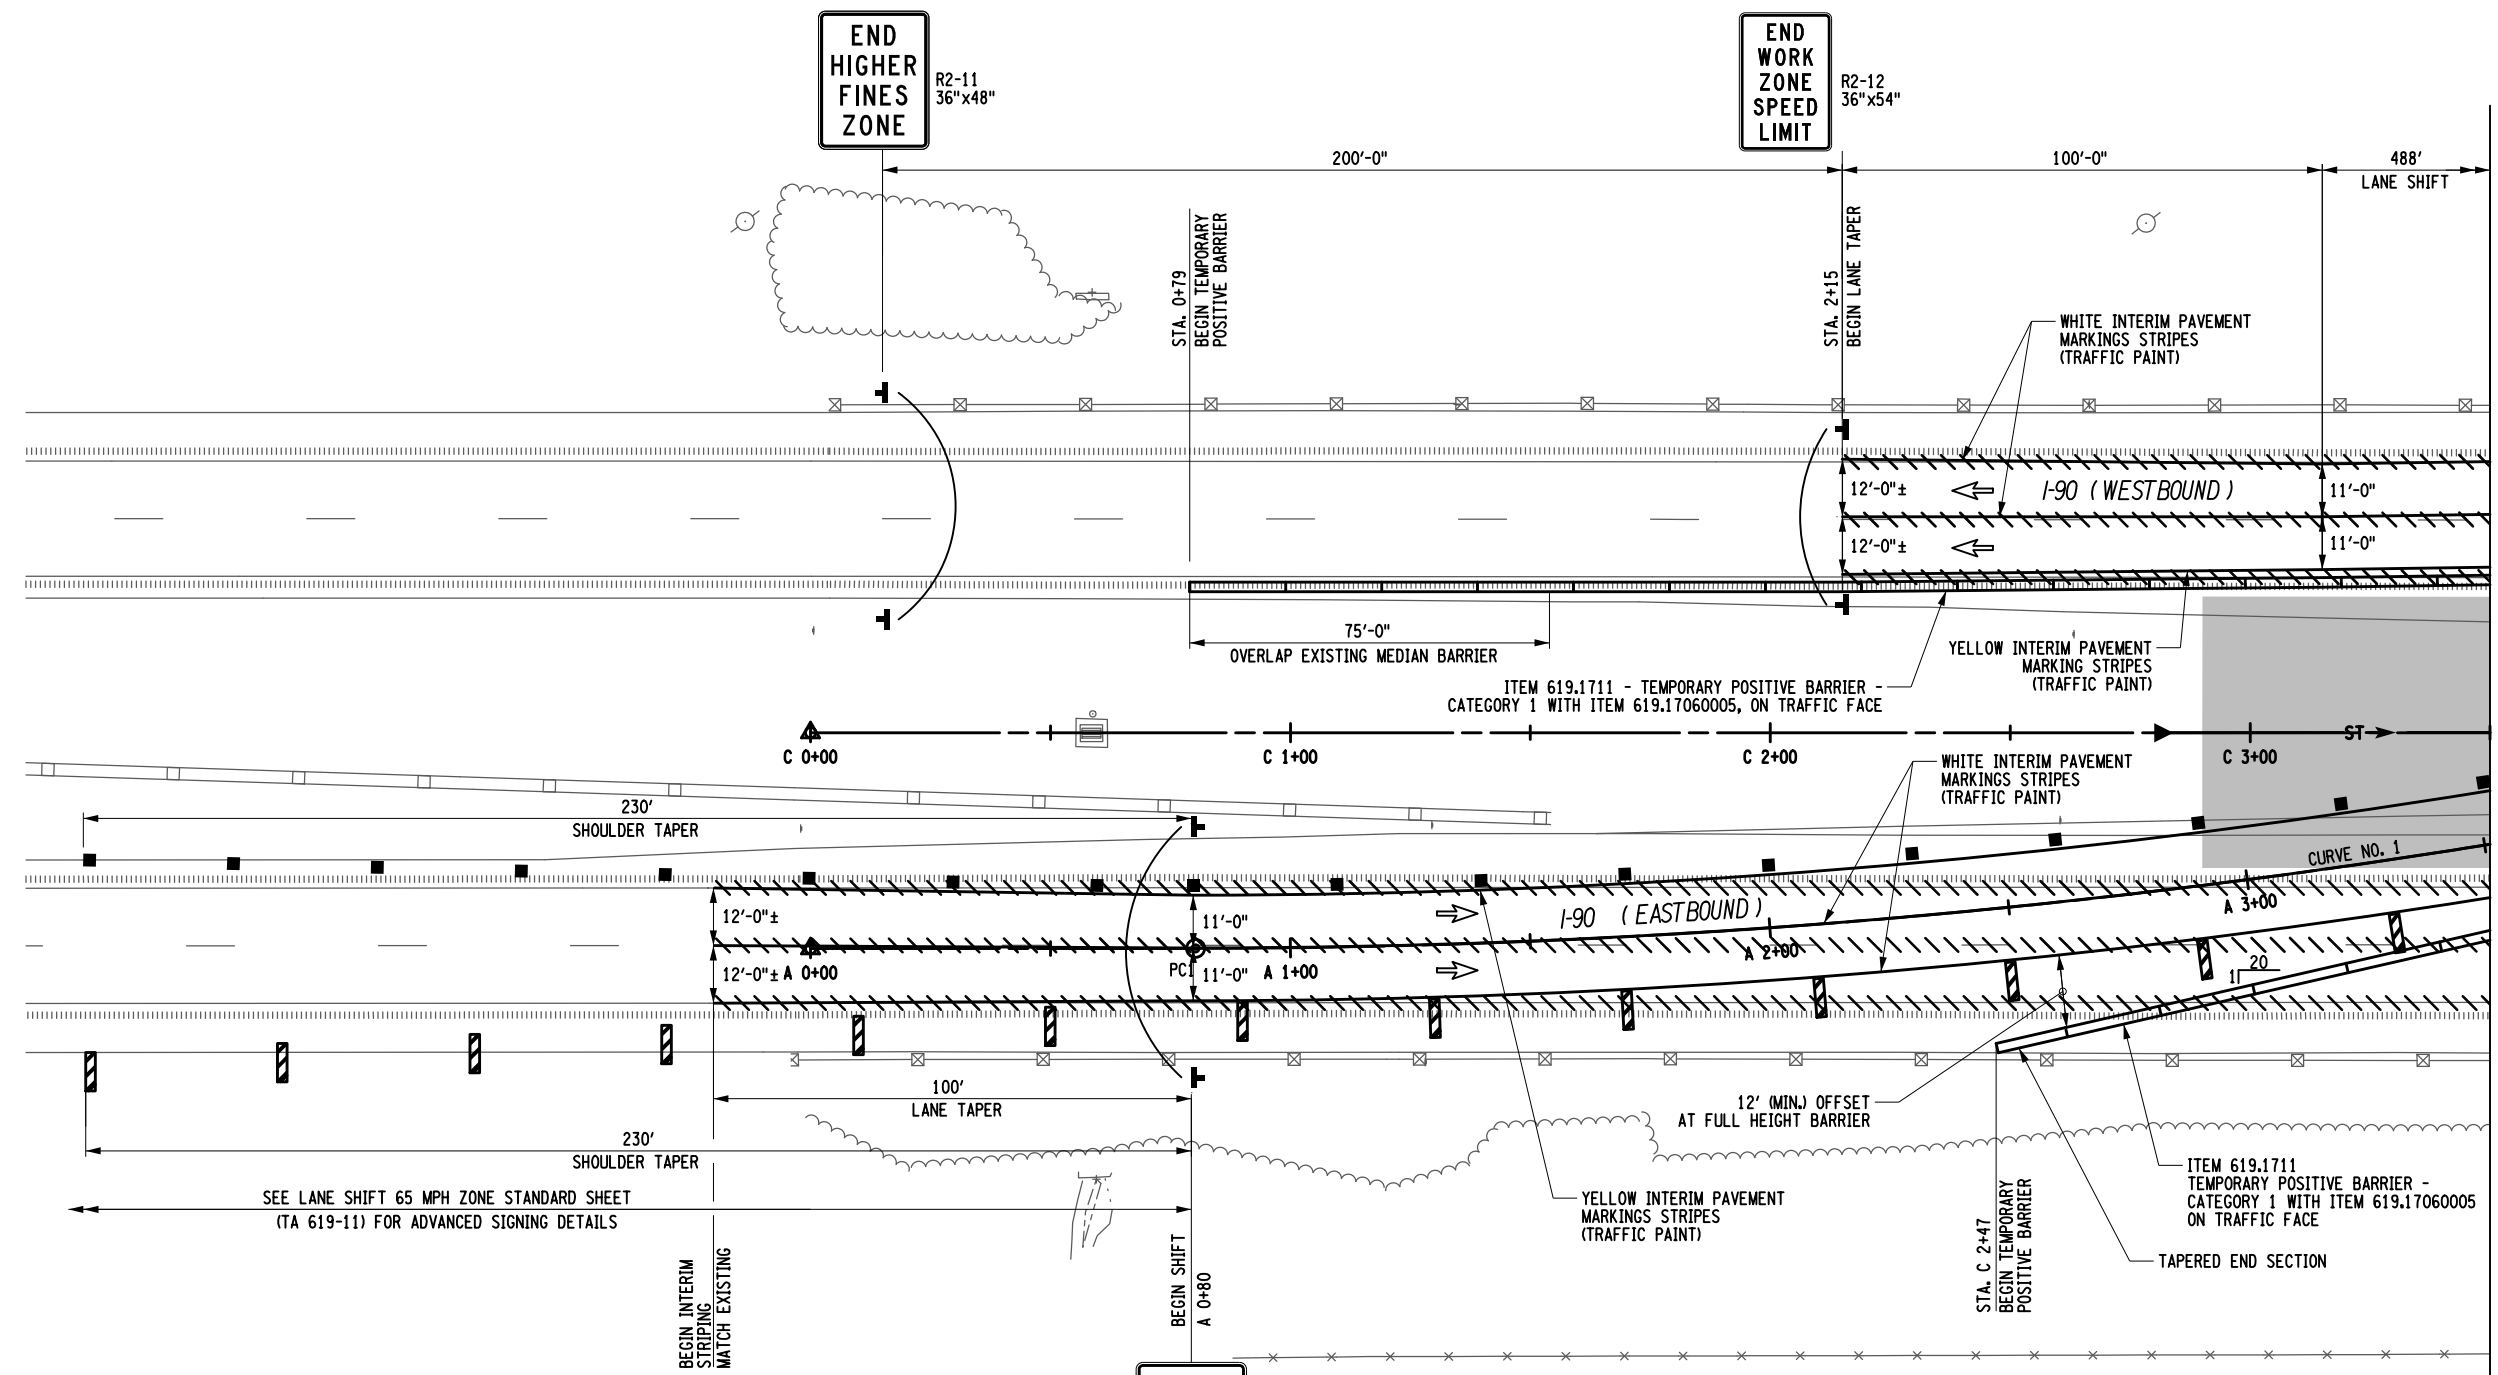

LEGEND

- 6" INTERIM PAVEMENT MARKINGS STRIPES (TRAFFIC PAINT), ITEM 619.10010125
- CONSTRUCTION DRUM @ 40.0' O.C. (MAX.), ITEM 619.01
- TEMPORARY SIGN, ITEM 619.01
- DIRECTION OF TRAFFIC
- PHASE 2 WORK SPACE
- PAVED MEDIAN CONSTRUCTION (COMPLETED UNDER PHASE 1)
- REMOVE PAVEMENT MARKING STRIPES, 6" EPOXY PAINT ITEM 619.08010225
- TYPE III BARRICADE @ 40' SPACING ITEM 619.04
- TEMPORARY POSITIVE BARRIER


POB - STA. A 0+00
N 1547849.0595
E 328535.7149

WORK ZONE
G20-5cP
36"x24"

SPEED LIMIT 55
R2-1
36"x48"

EASTBOUND CROSSOVER CURVE #1

R = 1,700 FT.	PC1 - STA A 0+80.23
Δ = 10°-00'-13.153"	N 1547800.8194
L = 296.814 FT.	E 328599.8195
D = 3°-22'-13.224"	PI1 - STA A 2+29.01
T = 148.785 FT.	N 1547711.3564
	E 328718.7037
	PT1 - STA A 3+77.04
	N 1547643.9050
	E 328851.3212

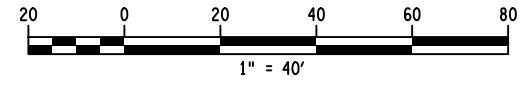

IT IS A VIOLATION OF LAW FOR ANY PERSON, UNLESS THEY ARE ACTING UNDER THE DIRECTION OF A LICENSED PROFESSIONAL ENGINEER, ARCHITECT, LANDSCAPE ARCHITECT, OR LAND SURVEYOR, TO ALTER AN ITEM IN ANY WAY. IF AN ITEM BEARING THE STAMP OF A LICENSED PROFESSIONAL IS ALTERED, THE ALTERING ENGINEER, ARCHITECT, LANDSCAPE ARCHITECT, OR LAND SURVEYOR SHALL STAMP THE DOCUMENT AND INCLUDE THE NOTATION "ALTERED BY" FOLLOWED BY THEIR SIGNATURE, THE DATE OF SUCH ALTERATION, AND A SPECIFIC DESCRIPTION OF THE ALTERATION.

REVISIONS			
DATE	DESCRIPTION	BY	SYM.



TITLE OF PROJECT
STERLING CREEK BRIDGE REHABILITATION

LOCATION OF PROJECT
SYRACUSE DIVISION
BIN 5516091 & 5516092 MP 227.40 & MP 227.41

TITLE OF DRAWING
WORK ZONE TRAFFIC CONTROL
PLAN-MAINLINE PHASE 2



CONTRACT NUMBER:
TAS 24-5B

DATE:
Nov. 2023

DRAWING NUMBER:
WZTC2-2

MATCH LINE, SEE DWG. WZTC2-3

PW/ R. PAPA/J.D. CLARK
 CHECKED BY: R. PAPA/J.D. CLARK
 DRAFTED BY: T. SAMSON/W. DILONE
 CHECKED BY: D. CLARK
 DESIGNED BY: T. SAMSON
 DESIGN SUPERVISOR: R. PAPA/J

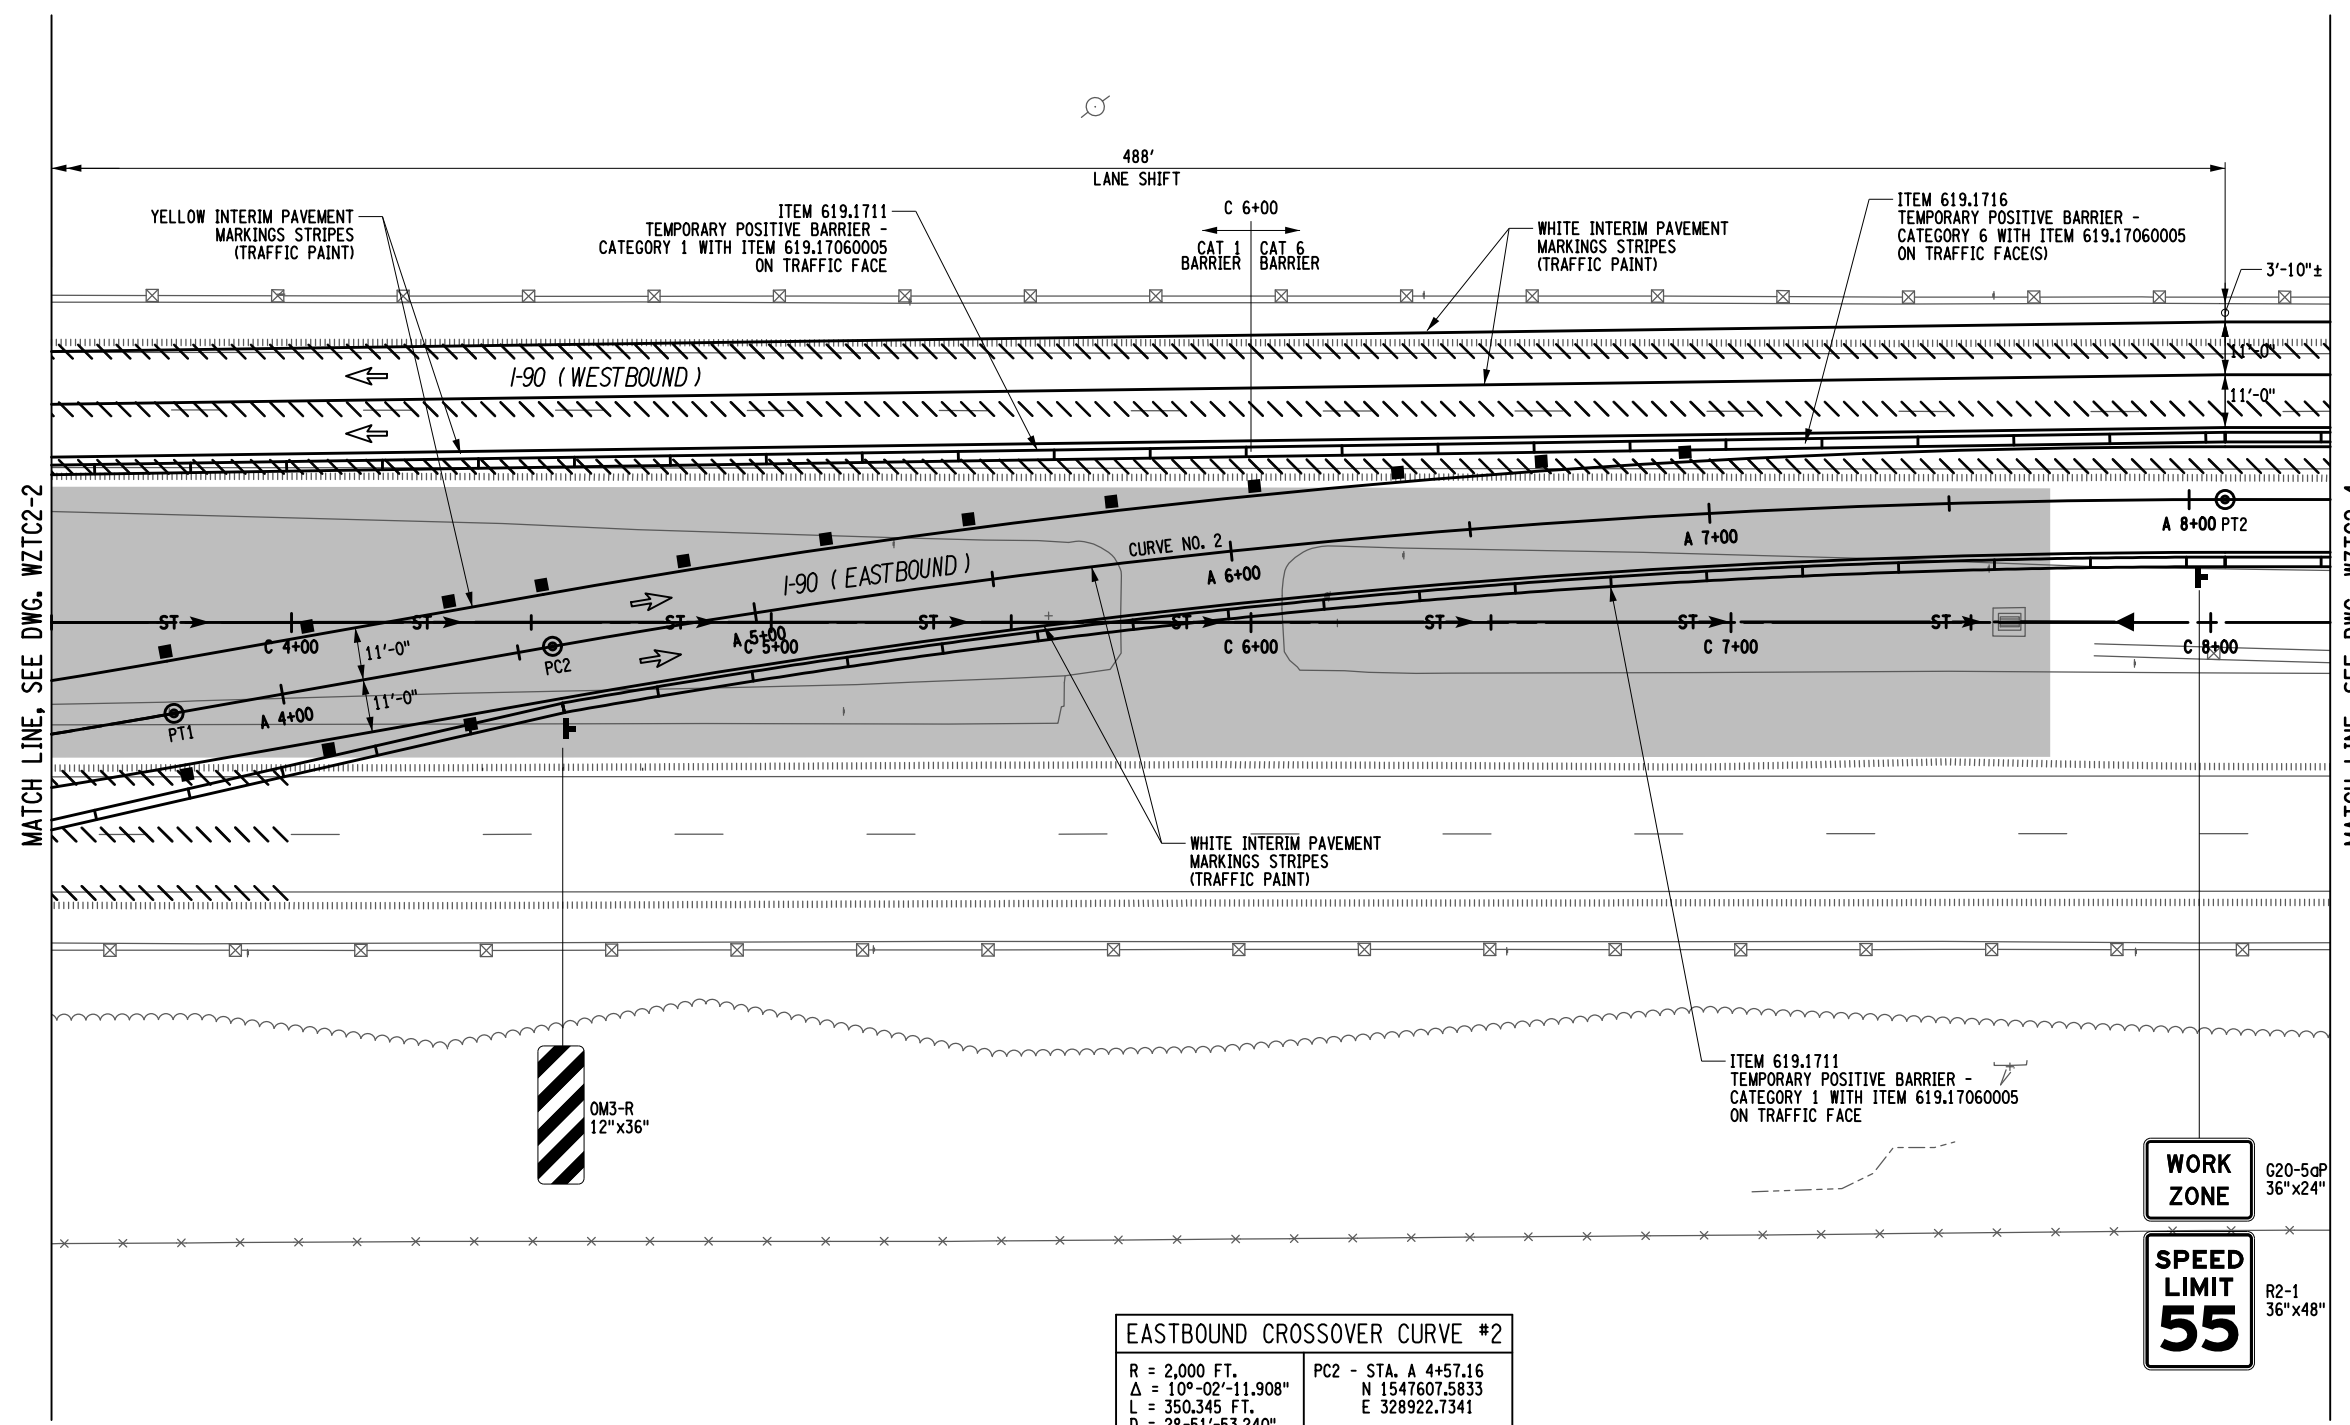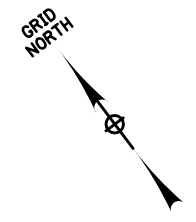


MATCH LINE, SEE DWG. WZTC2-2

MATCH LINE, SEE DWG. WZTC2-4

EASTBOUND CROSSOVER CURVE #2	
R = 2,000 FT.	PC2 - STA. A 4+57.16 N 1547607.5833 E 328922.7341
Δ = 10°-02'-11.908"	
L = 350.345 FT.	PI2 - STA. A 6+32.78 N 1547527.9657 E 329079.2718
D = 2°-51'-53.240"	
T = 175.622 FT.	PT2 - STA. A 8+07.51 N 1547422.2855 E 329219.5383

LEGEND	
	6" INTERIM PAVEMENT MARKINGS STRIPES (TRAFFIC PAINT), ITEM 619.10010125
	CONSTRUCTION DRUM @ 40.0' O.C. (MAX.), ITEM 619.01
	TEMPORARY SIGN, ITEM 619.01
	DIRECTION OF TRAFFIC
	PHASE 2 WORK SPACE
	PAVED MEDIAN CONSTRUCTION (COMPLETED UNDER PHASE 1)
	REMOVE PAVEMENT MARKING STRIPES, 6" EPOXY PAINT ITEM 619.08010225
	TEMPORARY POSITIVE BARRIER

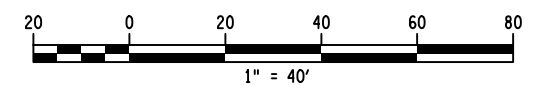

ALTERED ON:	AFFIXED ON: 11/08/2023
SIGNATURE: STAMP:	SIGNATURE: STAMP:



IT IS A VIOLATION OF LAW FOR ANY PERSON, UNLESS THEY ARE ACTING UNDER THE DIRECTION OF A LICENSED PROFESSIONAL ENGINEER, ARCHITECT, LANDSCAPE ARCHITECT, OR LAND SURVEYOR, TO ALTER AN ITEM IN ANY WAY. IF AN ITEM BEARING THE STAMP OF A LICENSED PROFESSIONAL IS ALTERED, THE ALTERING ENGINEER, ARCHITECT, LANDSCAPE ARCHITECT, OR LAND SURVEYOR SHALL STAMP THE DOCUMENT AND INCLUDE THE NOTATION "ALTERED BY" FOLLOWED BY THEIR SIGNATURE, THE DATE OF SUCH ALTERATION, AND A SPECIFIC DESCRIPTION OF THE ALTERATION.

REVISIONS			
DATE	DESCRIPTION	BY	SYM.

Thruway Authority

TITLE OF PROJECT STERLING CREEK BRIDGE REHABILITATION	CONTRACT NUMBER: TAS 24-5B
LOCATION OF PROJECT SYRACUSE DIVISION BIN 5516091 & 5516092 MP 227.40 & MP 227.41	DATE: Nov. 2023
TITLE OF DRAWING WORK ZONE TRAFFIC CONTROL PLAN-MAINLINE PHASE 2	DRAWING NUMBER: WZTC2-3


PW/ R. PAPA, J.D. CLARK
 CHECKED BY: R. PAPA, J.D. CLARK
 DRAFTED BY: T. SAMSON, W. DILONE
 CHECKED BY: D. CLARK
 DESIGNED BY: T. SAMSON
 DESIGN SUPERVISOR: R. PAPA, J.D. CLARK

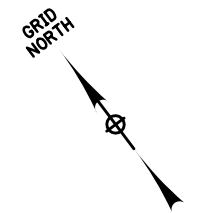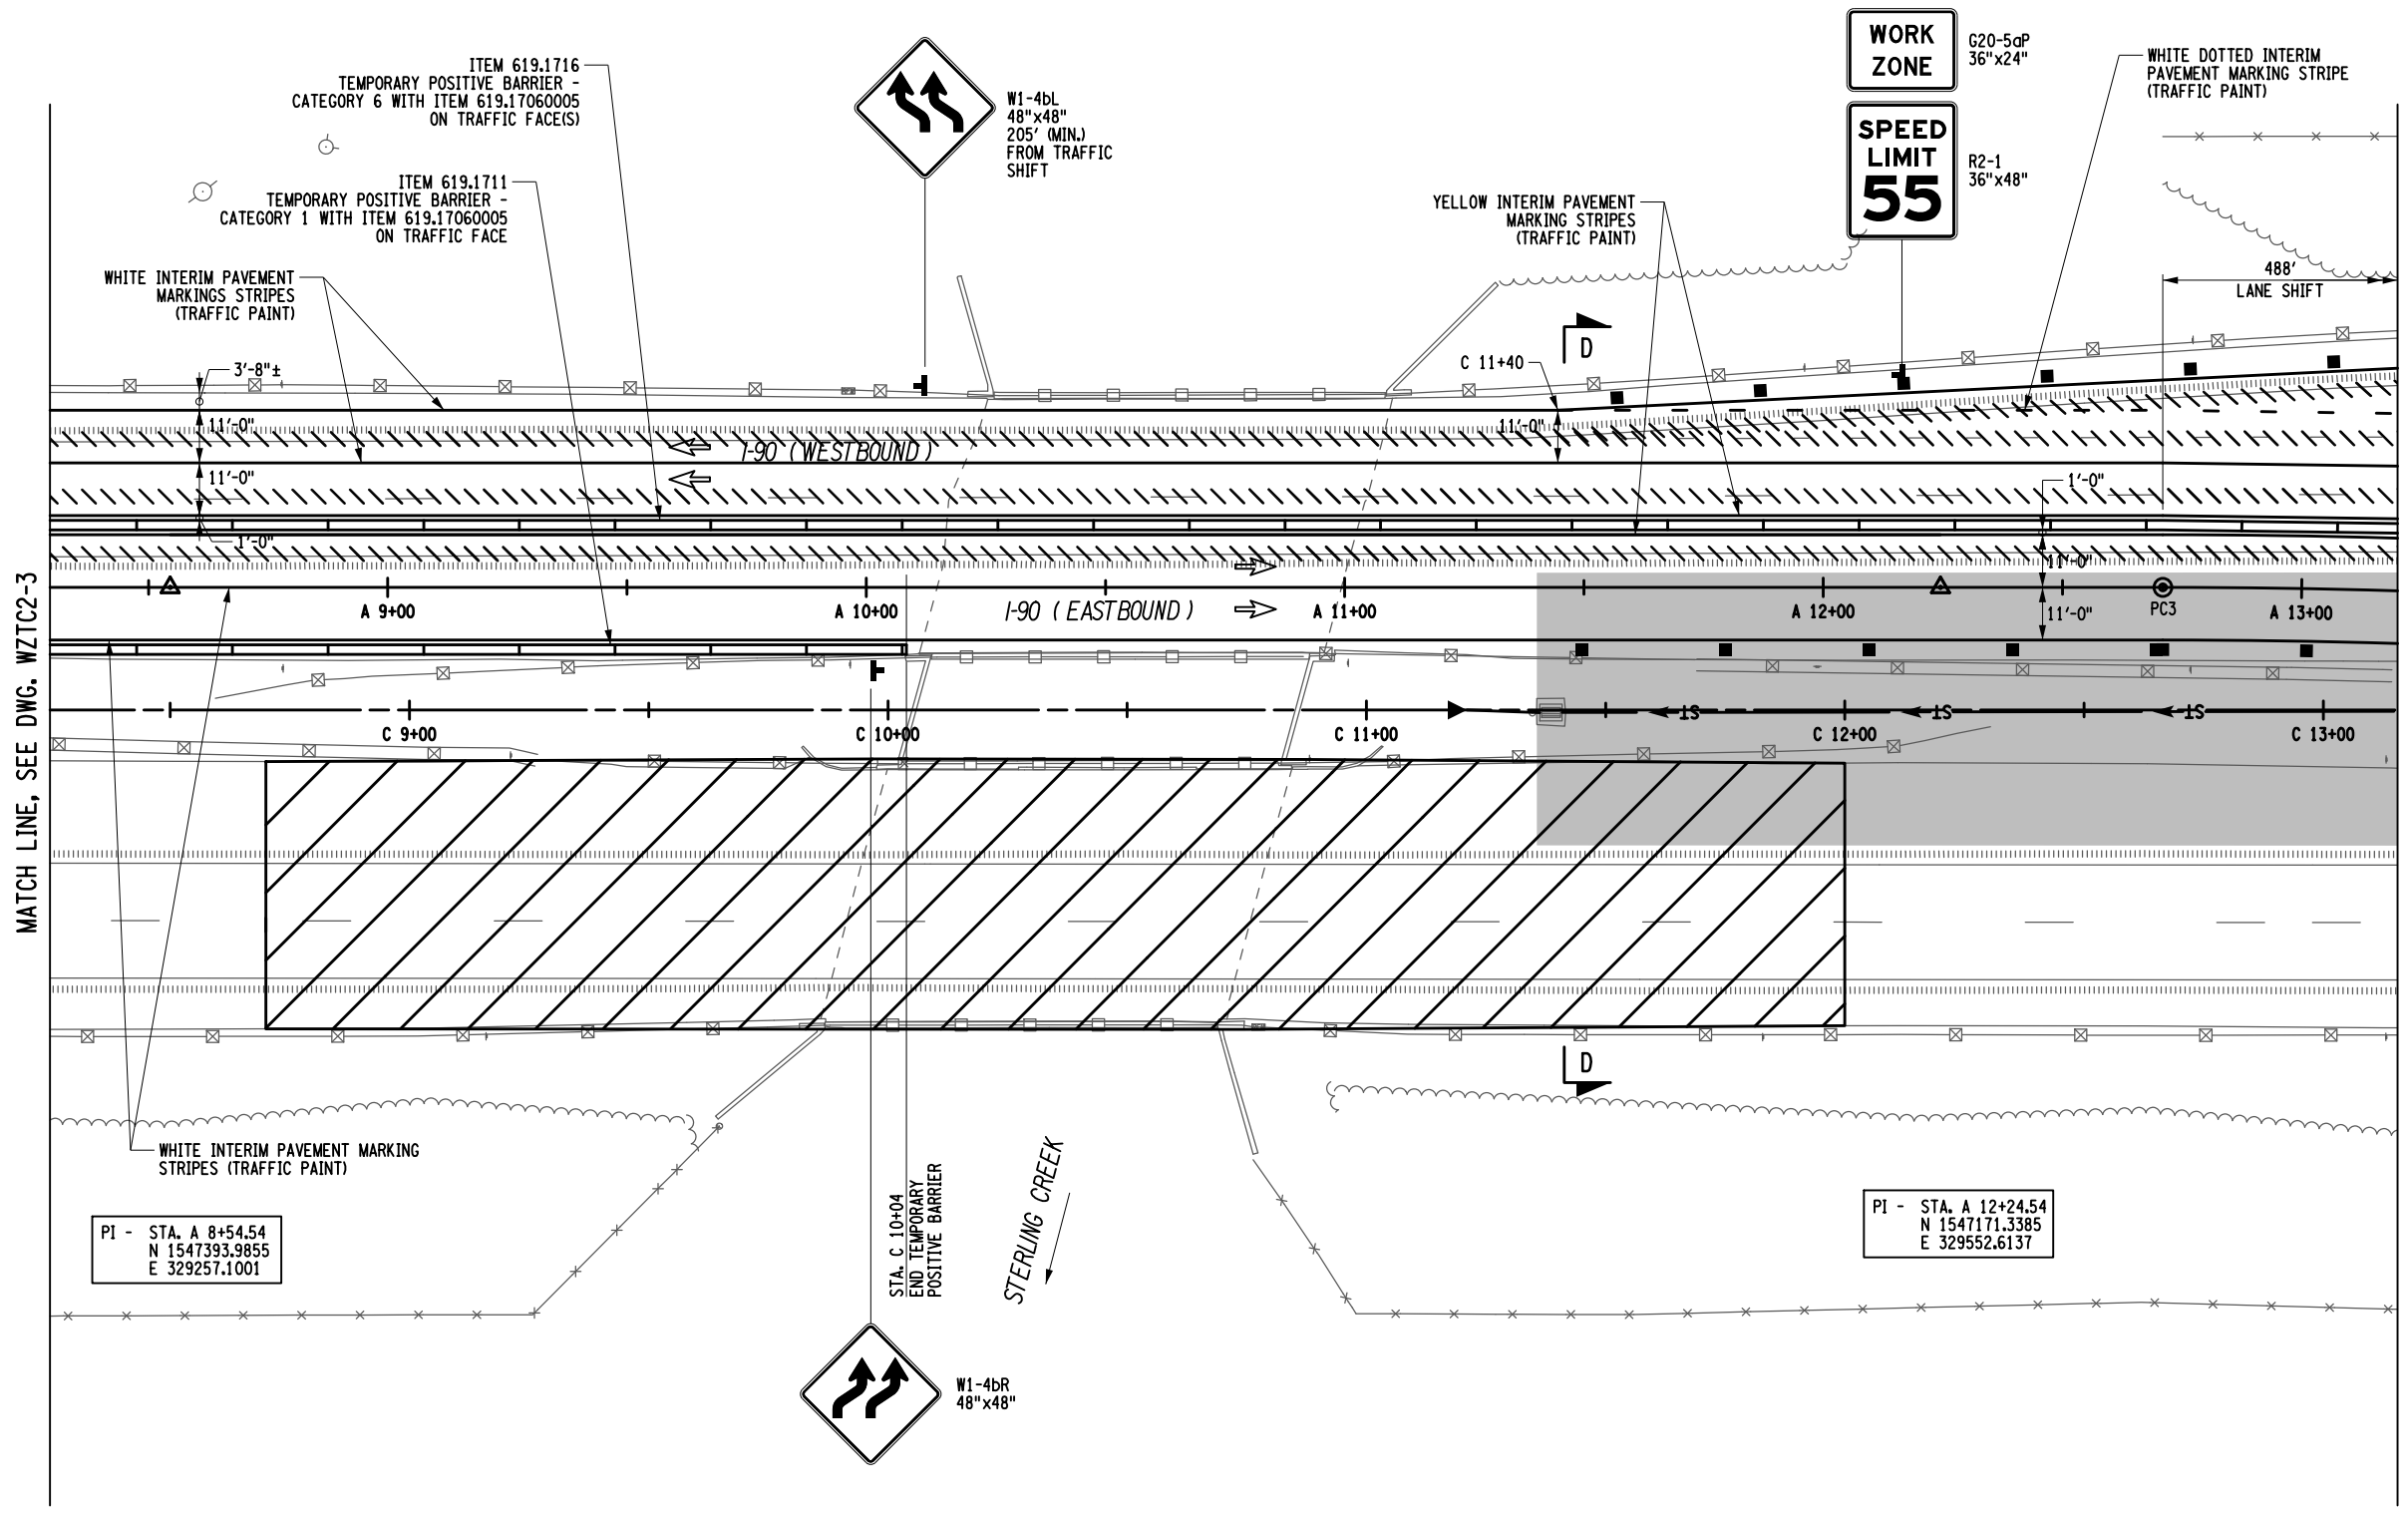

MATCH LINE, SEE DWG. WZTC2-3

MATCH LINE, SEE DWG. WZTC2-5

LEGEND	
	6" INTERIM PAVEMENT MARKINGS STRIPES (TRAFFIC PAINT), ITEM 619.10010125
	WHITE DOTTED INTERIM PAVEMENT MARKING STRIPE (TRAFFIC PAINT)
	CONSTRUCTION DRUM @ 40.0' O.C. (MAX.), ITEM 619.01
	TEMPORARY SIGN, ITEM 619.01
	DIRECTION OF TRAFFIC
	PHASE 2 WORK SPACE
	PAVED MEDIAN CONSTRUCTION (COMPLETED UNDER PHASE 1)
	REMOVE PAVEMENT MARKING STRIPES, 6" EPOXY PAINT ITEM 619.08010225
	TEMPORARY POSITIVE BARRIER

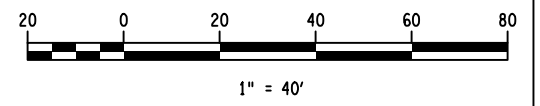

PI - STA. A 8+54.54
N 1547393.9855
E 329257.1001

PI - STA. A 12+24.54
N 1547171.3385
E 329552.6137

STA. C 10+04
END TEMPORARY
POSITIVE BARRIER

STERLING CREEK


ALTERED ON:	AFFIXED ON: 11/08/2023
SIGNATURE: STAMP:	SIGNATURE: STAMP:

IT IS A VIOLATION OF LAW FOR ANY PERSON, UNLESS THEY ARE ACTING UNDER THE DIRECTION OF A LICENSED PROFESSIONAL ENGINEER, ARCHITECT, LANDSCAPE ARCHITECT, OR LAND SURVEYOR, TO ALTER AN ITEM IN ANY WAY. IF AN ITEM BEARING THE STAMP OF A LICENSED PROFESSIONAL IS ALTERED, THE ALTERING ENGINEER, ARCHITECT, LANDSCAPE ARCHITECT, OR LAND SURVEYOR SHALL STAMP THE DOCUMENT AND INCLUDE THE NOTATION "ALTERED BY" FOLLOWED BY THEIR SIGNATURE, THE DATE OF SUCH ALTERATION, AND A SPECIFIC DESCRIPTION OF THE ALTERATION.

REVISIONS			
DATE	DESCRIPTION	BY	SYM.

 Thruway Authority	TITLE OF PROJECT STERLING CREEK BRIDGE REHABILITATION	CONTRACT NUMBER: TAS 24-5B
	LOCATION OF PROJECT SYRACUSE DIVISION BIN 5516091 & 5516092 MP 227.40 & MP 227.41	DATE: Nov. 2023
	TITLE OF DRAWING WORK ZONE TRAFFIC CONTROL PLAN-MAINLINE PHASE 2	DRAWING NUMBER: WZTC2-4

PW/ R. PAPA, J. CLARK
 CHECKED BY: T. SAMSON, W. DILONE
 DRAFTED BY: D. CLARK
 CHECKED BY: T. SAMSON
 DESIGN SUPERVISOR: R. PAPA

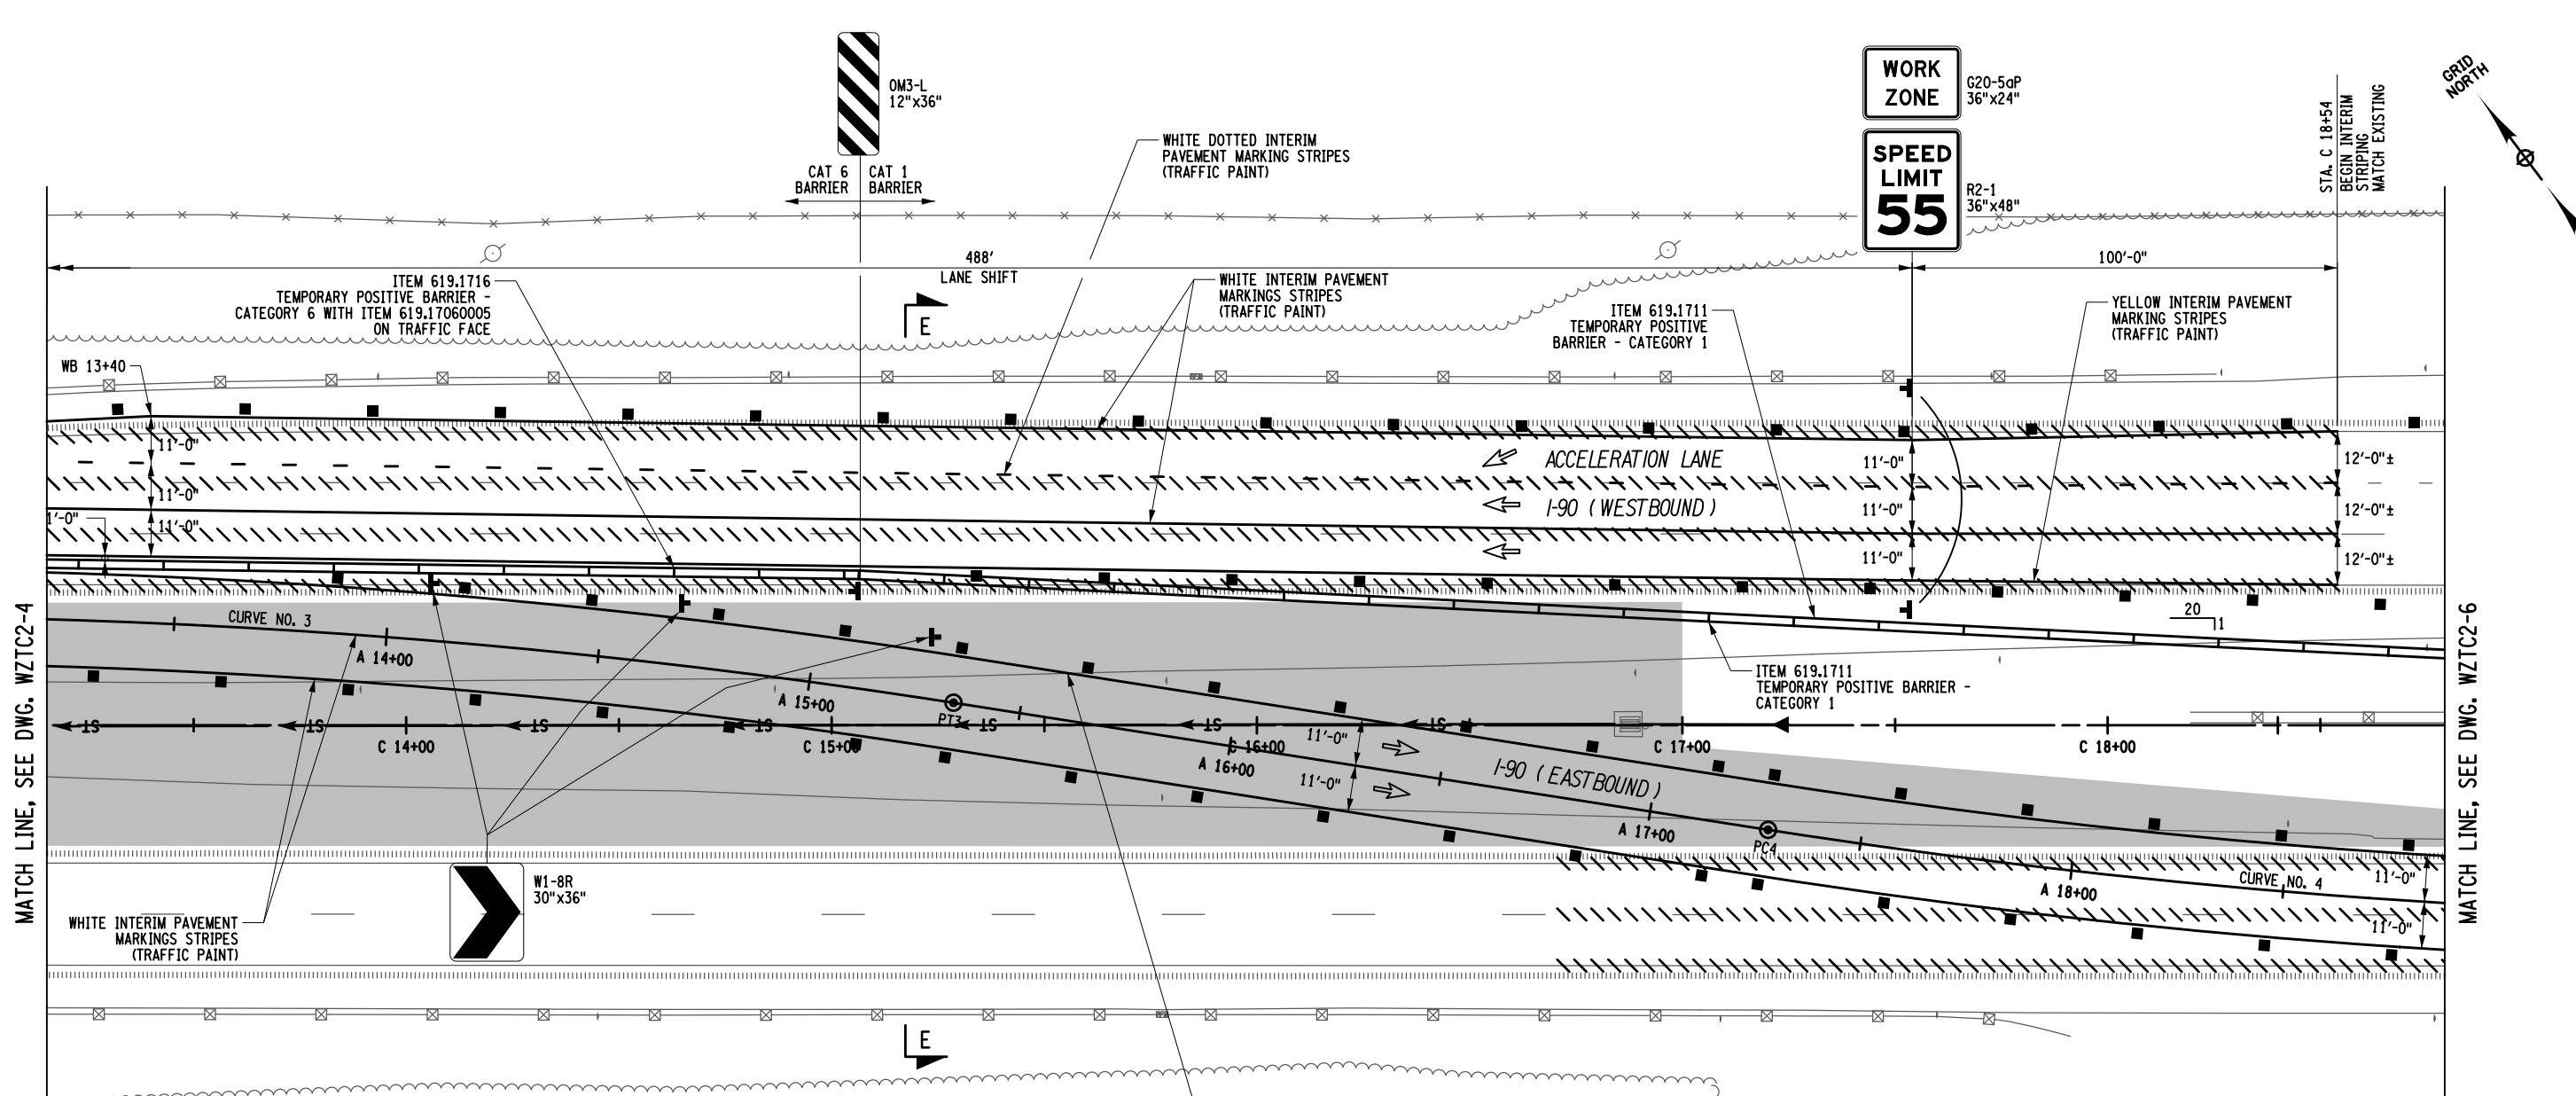

MATCH LINE, SEE DWG. WZTC2-4

MATCH LINE, SEE DWG. WZTC2-6

EASTBOUND CROSSOVER CURVE #3	
R = 1,700 FT.	PC3 - STA. A 12+71.00
$\Delta = 8^{\circ}-52'-18.855"$	N 1547143.3772
L = 263.235 FT.	E 329589.7259
D = $3^{\circ}-22'-13.224"$	PI3 - STA. A 14+02.88
T = 131.881 FT.	N 1547064.0180
	E 329695.0573
	PT3 - STA. A 15+34.24
	N 1546969.3635
	E 329786.8892

LEGEND	
	6" INTERIM PAVEMENT MARKINGS STRIPES (TRAFFIC PAINT), ITEM 619.10010125
	REMOVE PAVEMENT MARKING STRIPES, 6" EPOXY PAINT ITEM 619.08010225
	CONSTRUCTION DRUM @ 40.0' O.C. (MAX.), ITEM 619.01
	TEMPORARY SIGN, ITEM 619.01
	DIRECTION OF TRAFFIC
	PHASE 2 WORK SPACE
	PAVED MEDIAN CONSTRUCTION (COMPLETED UNDER PHASE 1)
	TEMPORARY POSITIVE BARRIER

EASTBOUND CROSSOVER CURVE #4	
R = 1,700 FT.	PC4 - STA. A 17+28.05
$\Delta = 8^{\circ}-50'-30.069"$	N 1546830.2602
L = 262.338 FT.	E 329921.8443
D = $3^{\circ}-22'-13.224"$	PI4 - STA. A 18+59.48
T = 131.430 FT.	N 1546735.9293
	E 330013.3622
	PT4 - STA. A 19+90.39
	N 1546656.7862
	E 330118.2916

ALTERED ON: _____ AFFIXED ON: 11/30/2023


SIGNATURE: _____ STAMP: _____

STATE OF NEW YORK
 DANIEL T. CLARK
 LICENSED PROFESSIONAL ENGINEER
 095433

IT IS A VIOLATION OF LAW FOR ANY PERSON, UNLESS THEY ARE ACTING UNDER THE DIRECTION OF A LICENSED PROFESSIONAL ENGINEER, ARCHITECT, LANDSCAPE ARCHITECT, OR LAND SURVEYOR, TO ALTER AN ITEM IN ANY WAY. IF AN ITEM BEARING THE STAMP OF A LICENSED PROFESSIONAL IS ALTERED, THE ALTERING ENGINEER, ARCHITECT, LANDSCAPE ARCHITECT, OR LAND SURVEYOR SHALL STAMP THE DOCUMENT AND INCLUDE THE NOTATION "ALTERED BY" FOLLOWED BY THEIR SIGNATURE, THE DATE OF SUCH ALTERATION, AND A SPECIFIC DESCRIPTION OF THE ALTERATION.


REVISIONS			
DATE	DESCRIPTION	BY	SYM.

Thruway Authority
 RAVI ENGINEERING & LAND SURVEYING, P.C.

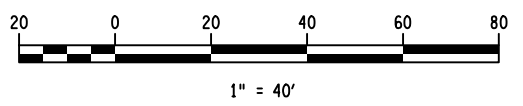


TITLE OF PROJECT STERLING CREEK BRIDGE REHABILITATION	CONTRACT NUMBER: TAS 24-5B
LOCATION OF PROJECT SYRACUSE DIVISION BIN 5516091 & 5516092 MP 227.40 & MP 227.41	DATE: Nov. 2023
TITLE OF DRAWING WORK ZONE TRAFFIC CONTROL PLAN-MAINLINE PHASE 2	DRAWING NUMBER: WZTC2-5

PW/ R. PAPA/ J.D. CLARK
 CHECKED BY: T. SAMSON/ W. DILONE
 DRAFTED BY: D. CLARK
 CHECKED BY: T. SAMSON
 DESIGNED BY: R. PAPA/ J.

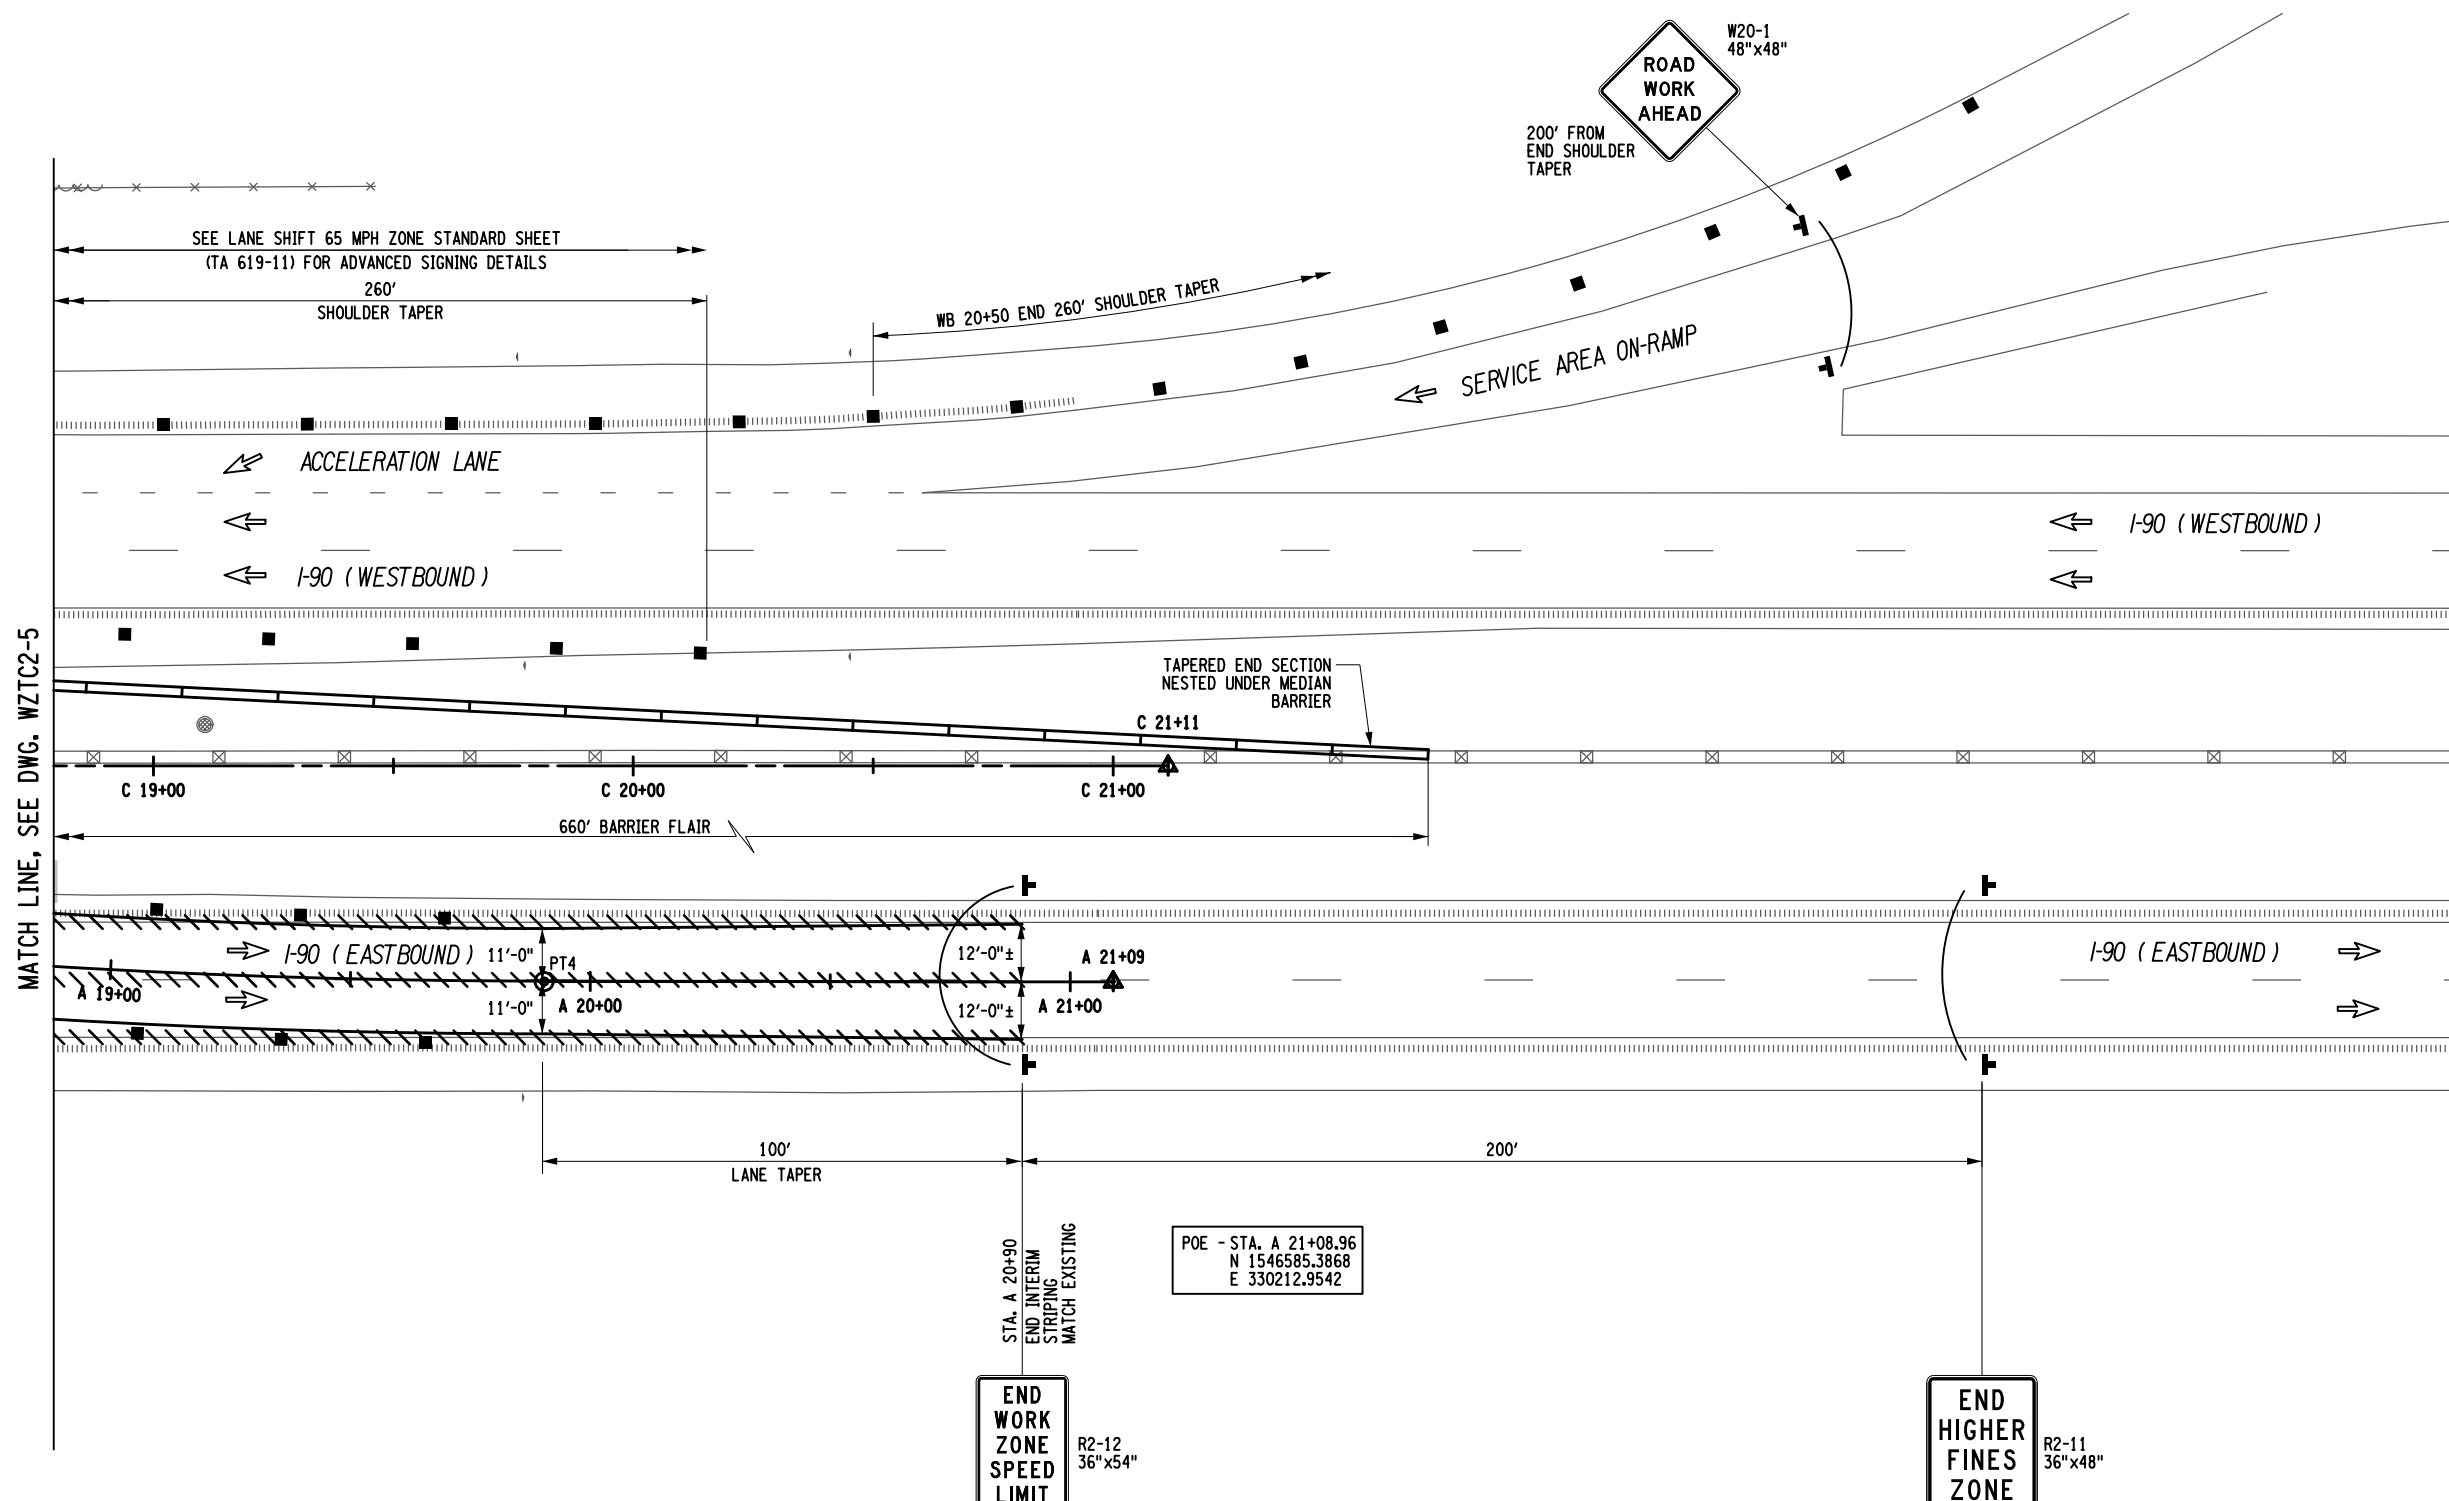

LEGEND	
	6" INTERIM PAVEMENT MARKINGS STRIPES (TRAFFIC PAINT), ITEM 619.10010125
	CONSTRUCTION DRUM @ 40.0' O.C. (MAX.), ITEM 619.01
	TEMPORARY SIGN, ITEM 619.01
	DIRECTION OF TRAFFIC
	PHASE 2 WORK SPACE
	PAVED MEDIAN CONSTRUCTION (COMPLETED UNDER PHASE 1)
	REMOVE PAVEMENT MARKING STRIPES, 6" EPOXY PAINT ITEM 619.08010225
	TEMPORARY POSITIVE BARRIER

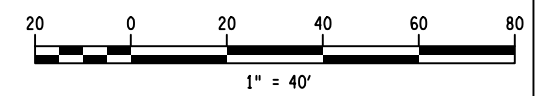

ALTERED ON:	AFFIXED ON: 11/30/2023
SIGNATURE: STAMP:	SIGNATURE: STAMP:

IT IS A VIOLATION OF LAW FOR ANY PERSON, UNLESS THEY ARE ACTING UNDER THE DIRECTION OF A LICENSED PROFESSIONAL ENGINEER, ARCHITECT, LANDSCAPE ARCHITECT, OR LAND SURVEYOR, TO ALTER AN ITEM IN ANY WAY. IF AN ITEM BEARING THE STAMP OF A LICENSED PROFESSIONAL IS ALTERED, THE ALTERING ENGINEER, ARCHITECT, LANDSCAPE ARCHITECT, OR LAND SURVEYOR SHALL STAMP THE DOCUMENT AND INCLUDE THE NOTATION "ALTERED BY" FOLLOWED BY THEIR SIGNATURE, THE DATE OF SUCH ALTERATION, AND A SPECIFIC DESCRIPTION OF THE ALTERATION.


REVISIONS			
DATE	DESCRIPTION	BY	SYM.

Thruway Authority

Ravi Engineering & Land Surveying, P.C.


TITLE OF PROJECT STERLING CREEK BRIDGE REHABILITATION	CONTRACT NUMBER: TAS 24-5B
LOCATION OF PROJECT SYRACUSE DIVISION BIN 5516091 & 5516092 MP 227.40 & MP 227.41	DATE: Nov. 2023
TITLE OF DRAWING WORK ZONE TRAFFIC CONTROL PLAN-MAINLINE PHASE 2	DRAWING NUMBER: WZTC2-6

PW/ CHECKED BY: R. PAPA/J.D. CLARK
 DRAFTED BY: T. SAMSON/W. DILONE
 CHECKED BY: D. CLARK
 DESIGNED BY: T. SAMSON
 DESIGN SUPERVISOR: R. PAPA/J

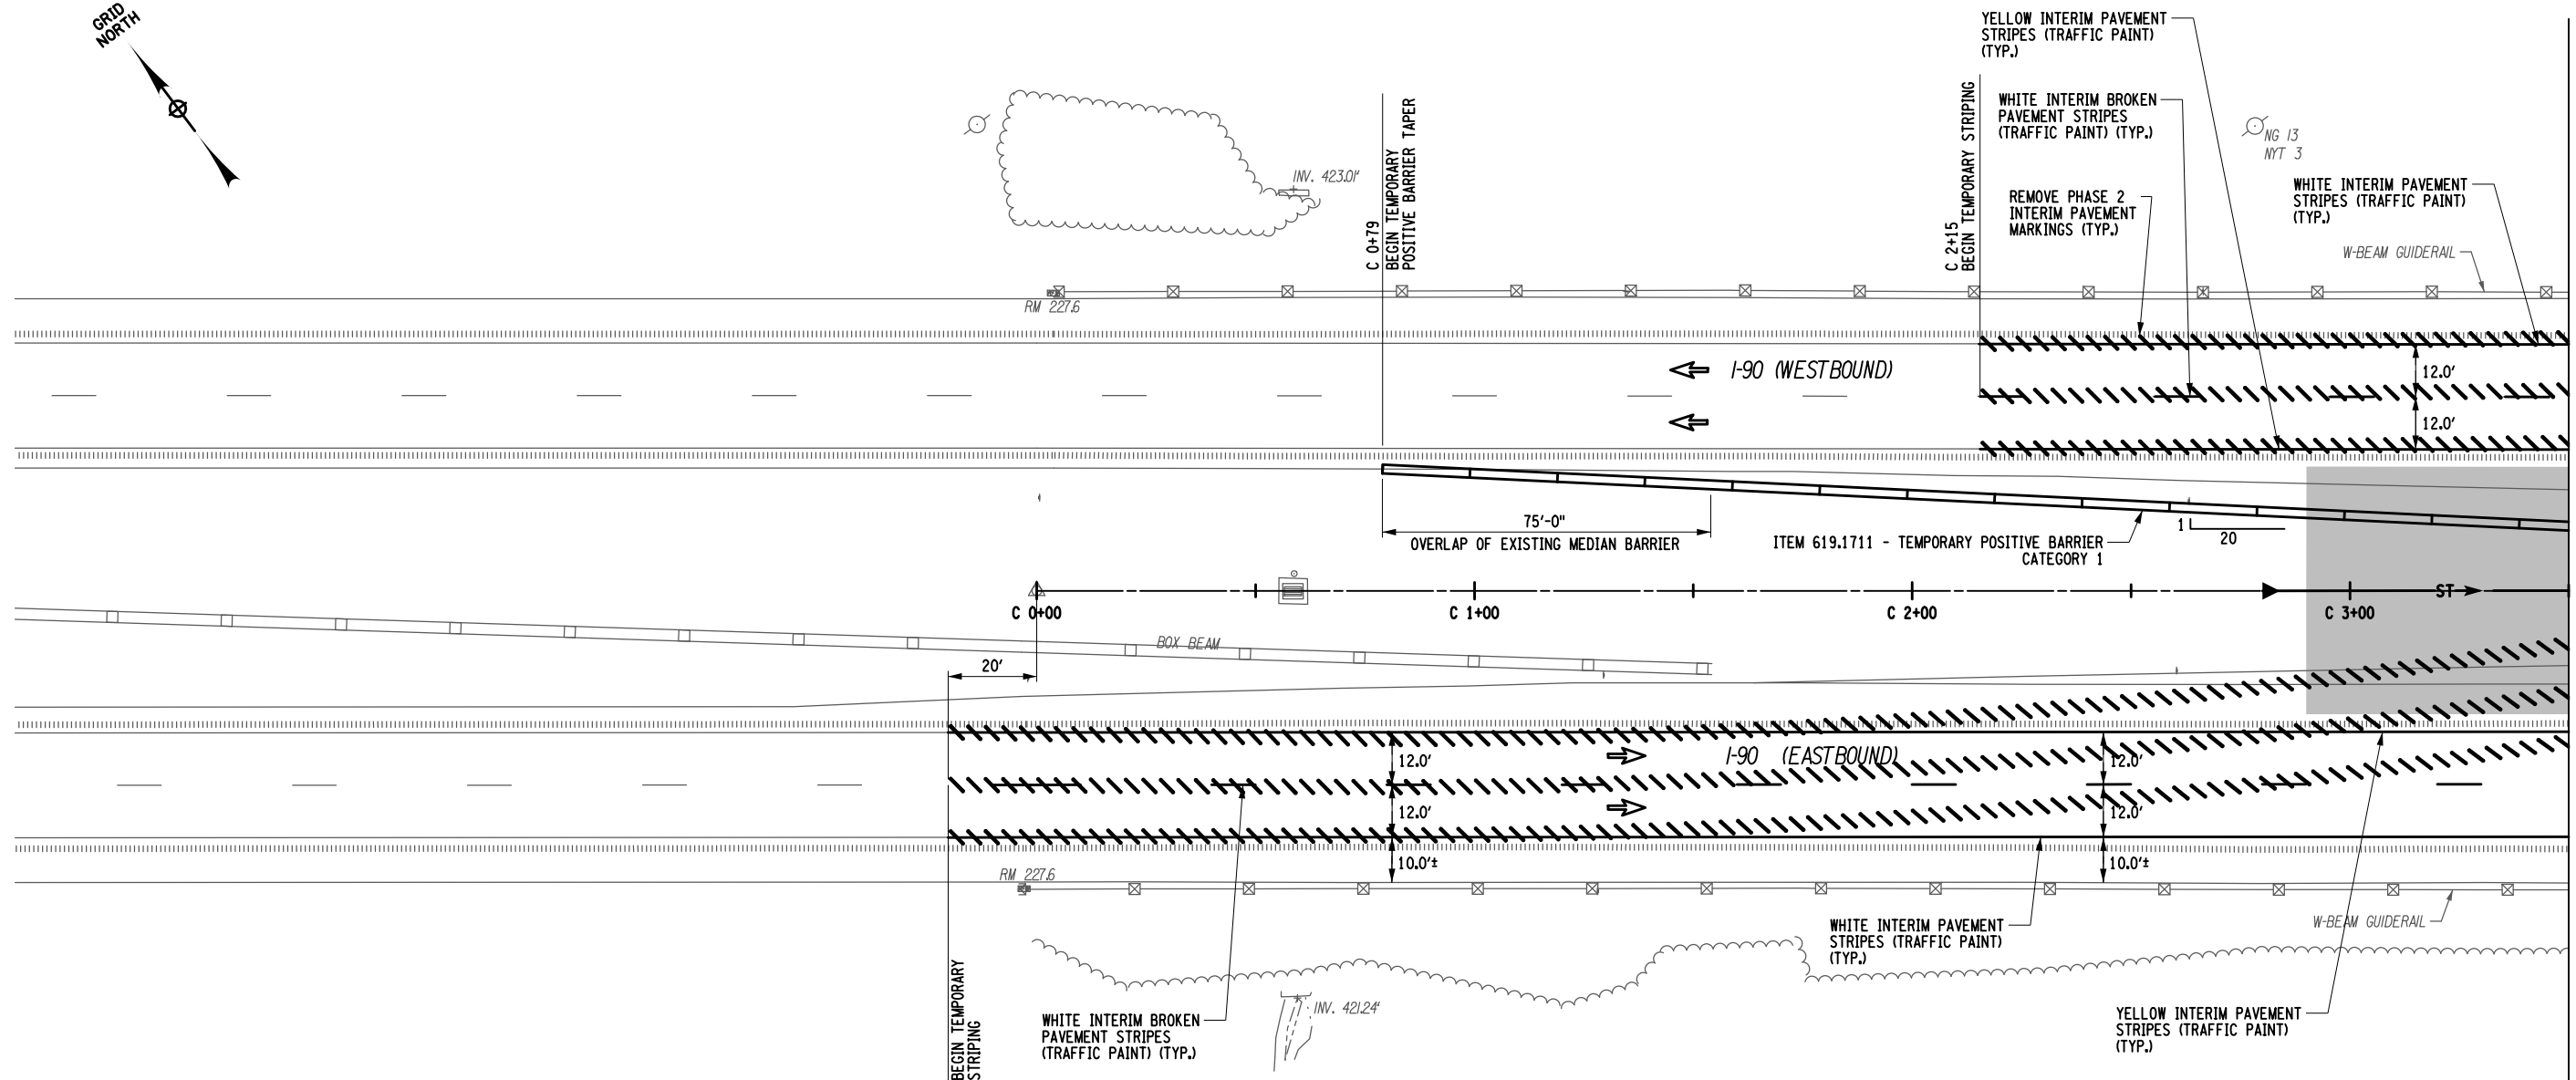

MATCH LINE, SEE DWG. WZTC3-2

LEGEND	
	SOLID 6" INTERIM PAVEMENT MARKINGS, STRIPES (TRAFFIC PAINT) ITEM 619.10010125
	BROKEN 6" INTERIM PAVEMENT MARKINGS, STRIPES (TRAFFIC PAINT) ITEM 619.10010125
	CONSTRUCTION DRUM @ 40.0' O.C. (MAX.), ITEM 619.01
	TEMPORARY SIGN, ITEM 619.01
	DIRECTION OF TRAFFIC
	PAVED MEDIAN CONSTRUCTION (COMPLETED UNDER PHASE 1)
	REMOVE PAVEMENT MARKING STRIPES, 6" TRAFFIC PAINT ITEM 619.08010125
	TEMPORARY POSITIVE BARRIER

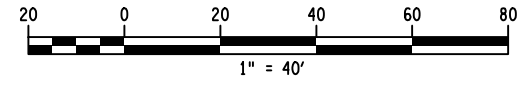

ALTERED ON:	AFFIXED ON: 11/30/2023
SIGNATURE: STAMP:	SIGNATURE: STAMP:

IT IS A VIOLATION OF LAW FOR ANY PERSON, UNLESS THEY ARE ACTING UNDER THE DIRECTION OF A LICENSED PROFESSIONAL ENGINEER, ARCHITECT, LANDSCAPE ARCHITECT, OR LAND SURVEYOR, TO ALTER AN ITEM IN ANY WAY. IF AN ITEM BEARING THE STAMP OF A LICENSED PROFESSIONAL IS ALTERED, THE ALTERING ENGINEER, ARCHITECT, LANDSCAPE ARCHITECT, OR LAND SURVEYOR SHALL STAMP THE DOCUMENT AND INCLUDE THE NOTATION "ALTERED BY" FOLLOWED BY THEIR SIGNATURE, THE DATE OF SUCH ALTERATION, AND A SPECIFIC DESCRIPTION OF THE ALTERATION.



REVISIONS			
DATE	DESCRIPTION	BY	SYM.

Thruway Authority


Ravi Engineering & Land Surveying, P.C.

TITLE OF PROJECT STERLING CREEK BRIDGE REHABILITATION	CONTRACT NUMBER: TAS 24-5B
LOCATION OF PROJECT SYRACUSE DIVISION BIN 5516091 & 5516092 MP 227.40 & MP 227.41	DATE: Nov. 2023
TITLE OF DRAWING WORK ZONE TRAFFIC CONTROL PLAN-MAINLINE PHASE 3 WINTER	DRAWING NUMBER: WZTC3-1

PW/ CHECKED BY: R. PAPA/J.D. CLARK
 DRAFTED BY: T. SAMSON/W. DILONE
 CHECKED BY: D. CLARK
 DESIGNED BY: T. SAMSON
 DESIGN SUPERVISOR: R. PAPA/J

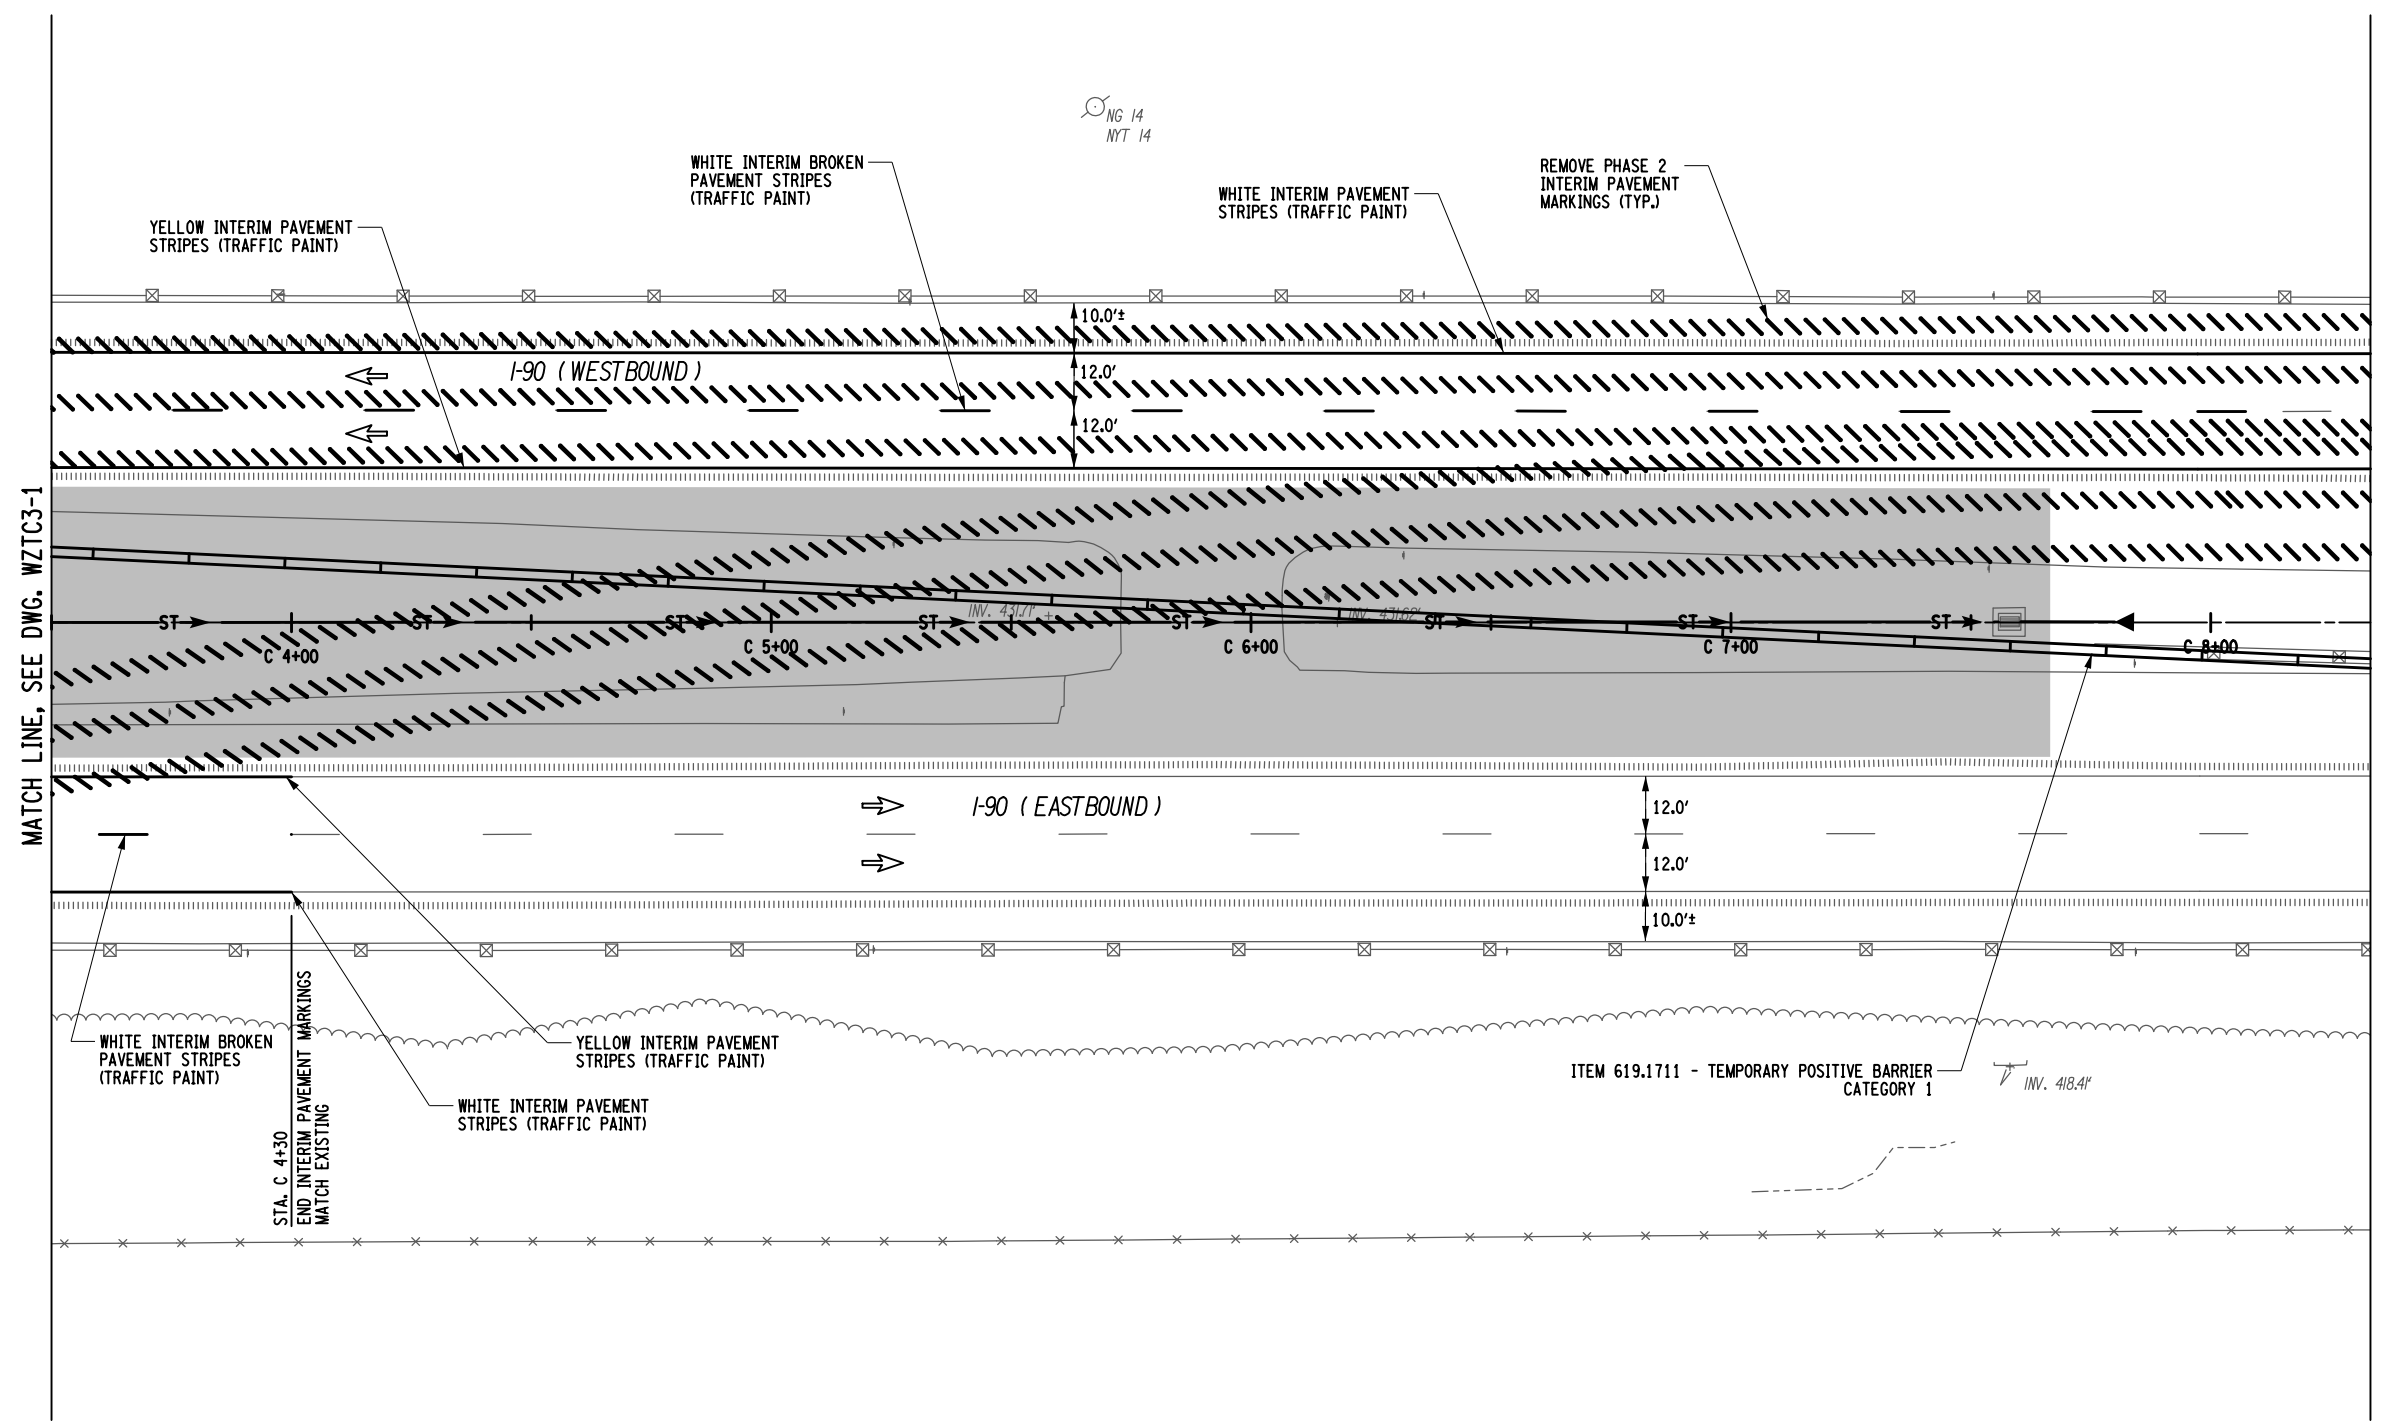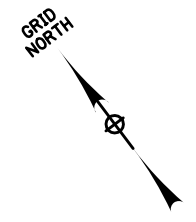

LEGEND	
	6" INTERIM PAVEMENT MARKINGS, STRIPES (TRAFFIC PAINT)
	ITEM 619.10010125
	CONSTRUCTION DRUM @ 40.0' O.C. (MAX.), ITEM 619.01
	TEMPORARY SIGN, ITEM 619.01
	DIRECTION OF TRAFFIC
	PAVED MEDIAN CONSTRUCTION (COMPLETED UNDER PHASE 1)
	REMOVE PAVEMENT MARKING STRIPES, 6" TRAFFIC PAINT ITEM 619.08010125
	TEMPORARY POSITIVE BARRIER

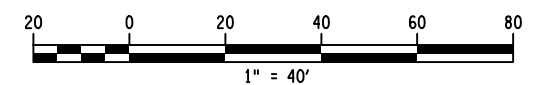

ALTERED ON:	AFFIXED ON: 11/30/2023
SIGNATURE: STAMP:	SIGNATURE: STAMP:

IT IS A VIOLATION OF LAW FOR ANY PERSON, UNLESS THEY ARE ACTING UNDER THE DIRECTION OF A LICENSED PROFESSIONAL ENGINEER, ARCHITECT, LANDSCAPE ARCHITECT, OR LAND SURVEYOR, TO ALTER AN ITEM IN ANY WAY. IF AN ITEM BEARING THE STAMP OF A LICENSED PROFESSIONAL IS ALTERED, THE ALTERING ENGINEER, ARCHITECT, LANDSCAPE ARCHITECT, OR LAND SURVEYOR SHALL STAMP THE DOCUMENT AND INCLUDE THE NOTATION "ALTERED BY" FOLLOWED BY THEIR SIGNATURE, THE DATE OF SUCH ALTERATION, AND A SPECIFIC DESCRIPTION OF THE ALTERATION.



REVISIONS			
DATE	DESCRIPTION	BY	SYM.

Thruway Authority

Ravi Engineering & Land Surveying, P.C.

TITLE OF PROJECT STERLING CREEK BRIDGE REHABILITATION	CONTRACT NUMBER: TAS 24-5B
LOCATION OF PROJECT SYRACUSE DIVISION BIN 5516091 & 5516092 MP 227.40 & MP 227.41	DATE: Nov. 2023
TITLE OF DRAWING WORK ZONE TRAFFIC CONTROL PLAN-MAINLINE PHASE 3 WINTER	DRAWING NUMBER: WZTC3-2


PW/ R. PAPA, J.D. CLARK
 CHECKED BY: R. PAPA, J.D. CLARK
 DRAFTED BY: T. SAMSON, W. DILONE
 CHECKED BY: D. CLARK
 DESIGNED BY: T. SAMSON

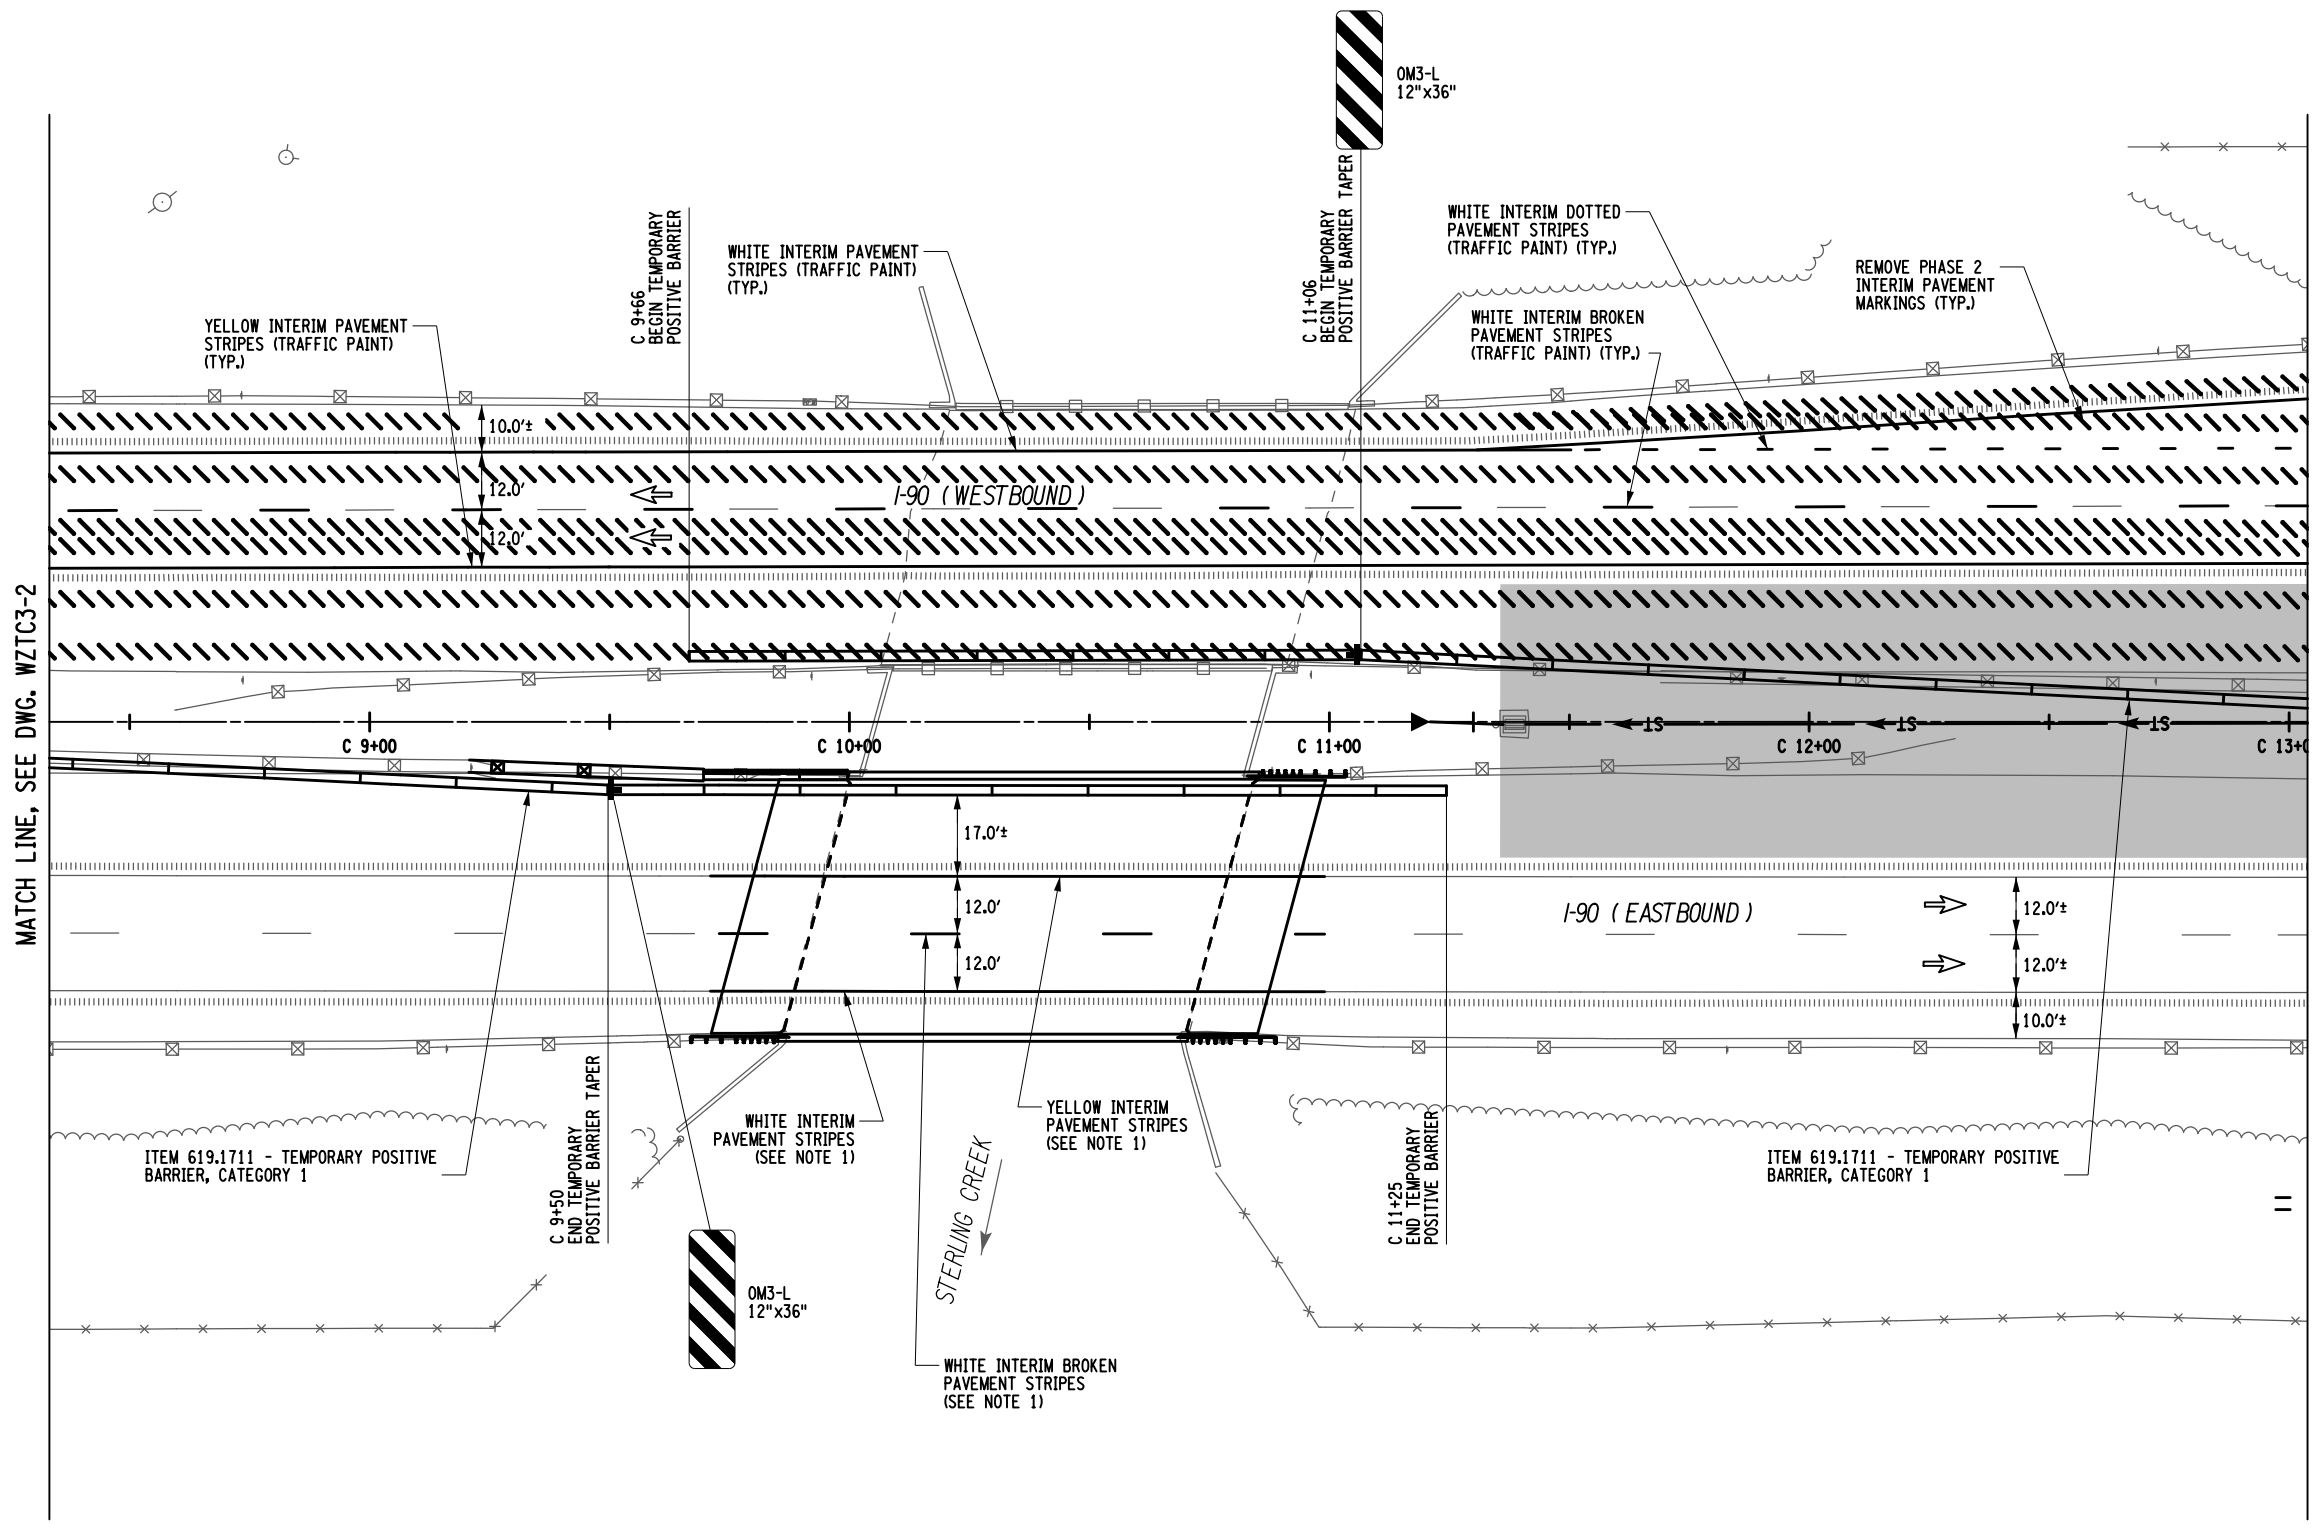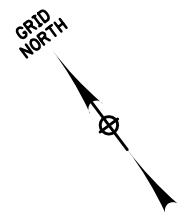

MATCH LINE, SEE DWG. WZTC3-2

MATCH LINE, SEE DWG. WZTC3-4

LEGEND	
	6" INTERIM PAVEMENT MARKING STRIPES (TRAFFIC PAINT)
	6" INTERIM PAVEMENT MARKING STRIPES (TRAFFIC PAINT)
	ITEM 619.1001025
	CONSTRUCTION DRUM @ 40.0' O.C. (MAX.), ITEM 619.01
	TEMPORARY SIGN, ITEM 619.01
	DIRECTION OF TRAFFIC
	PAVED MEDIAN CONSTRUCTION (COMPLETED UNDER PHASE 1)
	REMOVE PAVEMENT MARKING STRIPES, 6" TRAFFIC PAINT ITEM 619.0801025
	TEMPORARY POSITIVE BARRIER

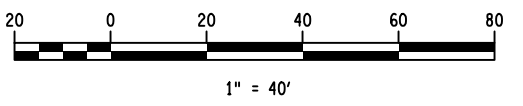

ALTERED ON: AFFIXED ON:
11/30/2023

SIGNATURE: STAMP:

NOTE:



- ON NEW BRIDGE DECK AND ANY FINAL PAVEMENT SURFACES CONTRACTOR SHALL SUBSTITUTE ITEM 619.1001025, INTERIM PAVEMENT MARKINGS (TRAFFIC PAINT), WITH ITEM 619.100104, INTERIM PAVEMENT MARKINGS (REMOVABLE WET REFLECTIVE TAPE)

IT IS A VIOLATION OF LAW FOR ANY PERSON, UNLESS THEY ARE ACTING UNDER THE DIRECTION OF A LICENSED PROFESSIONAL ENGINEER, ARCHITECT, LANDSCAPE ARCHITECT, OR LAND SURVEYOR, TO ALTER AN ITEM IN ANY WAY. IF AN ITEM BEARING THE STAMP OF A LICENSED PROFESSIONAL IS ALTERED, THE ALTERING ENGINEER, ARCHITECT, LANDSCAPE ARCHITECT, OR LAND SURVEYOR SHALL STAMP THE DOCUMENT AND INCLUDE THE NOTATION "ALTERED BY" FOLLOWED BY THEIR SIGNATURE, THE DATE OF SUCH ALTERATION, AND A SPECIFIC DESCRIPTION OF THE ALTERATION.

REVISIONS			
DATE	DESCRIPTION	BY	SYM.

RAVI ENGINEERING & LAND SURVEYING, P.C.

TITLE OF PROJECT STERLING CREEK BRIDGE REHABILITATION	CONTRACT NUMBER: TAS 24-5B
LOCATION OF PROJECT SYRACUSE DIVISION BIN 5516091 & 5516092 MP 227.40 & MP 227.41	DATE: Nov. 2023
TITLE OF DRAWING WORK ZONE TRAFFIC CONTROL PLAN-MAINLINE PHASE 3 WINTER	DRAWING NUMBER: WZTC3-3

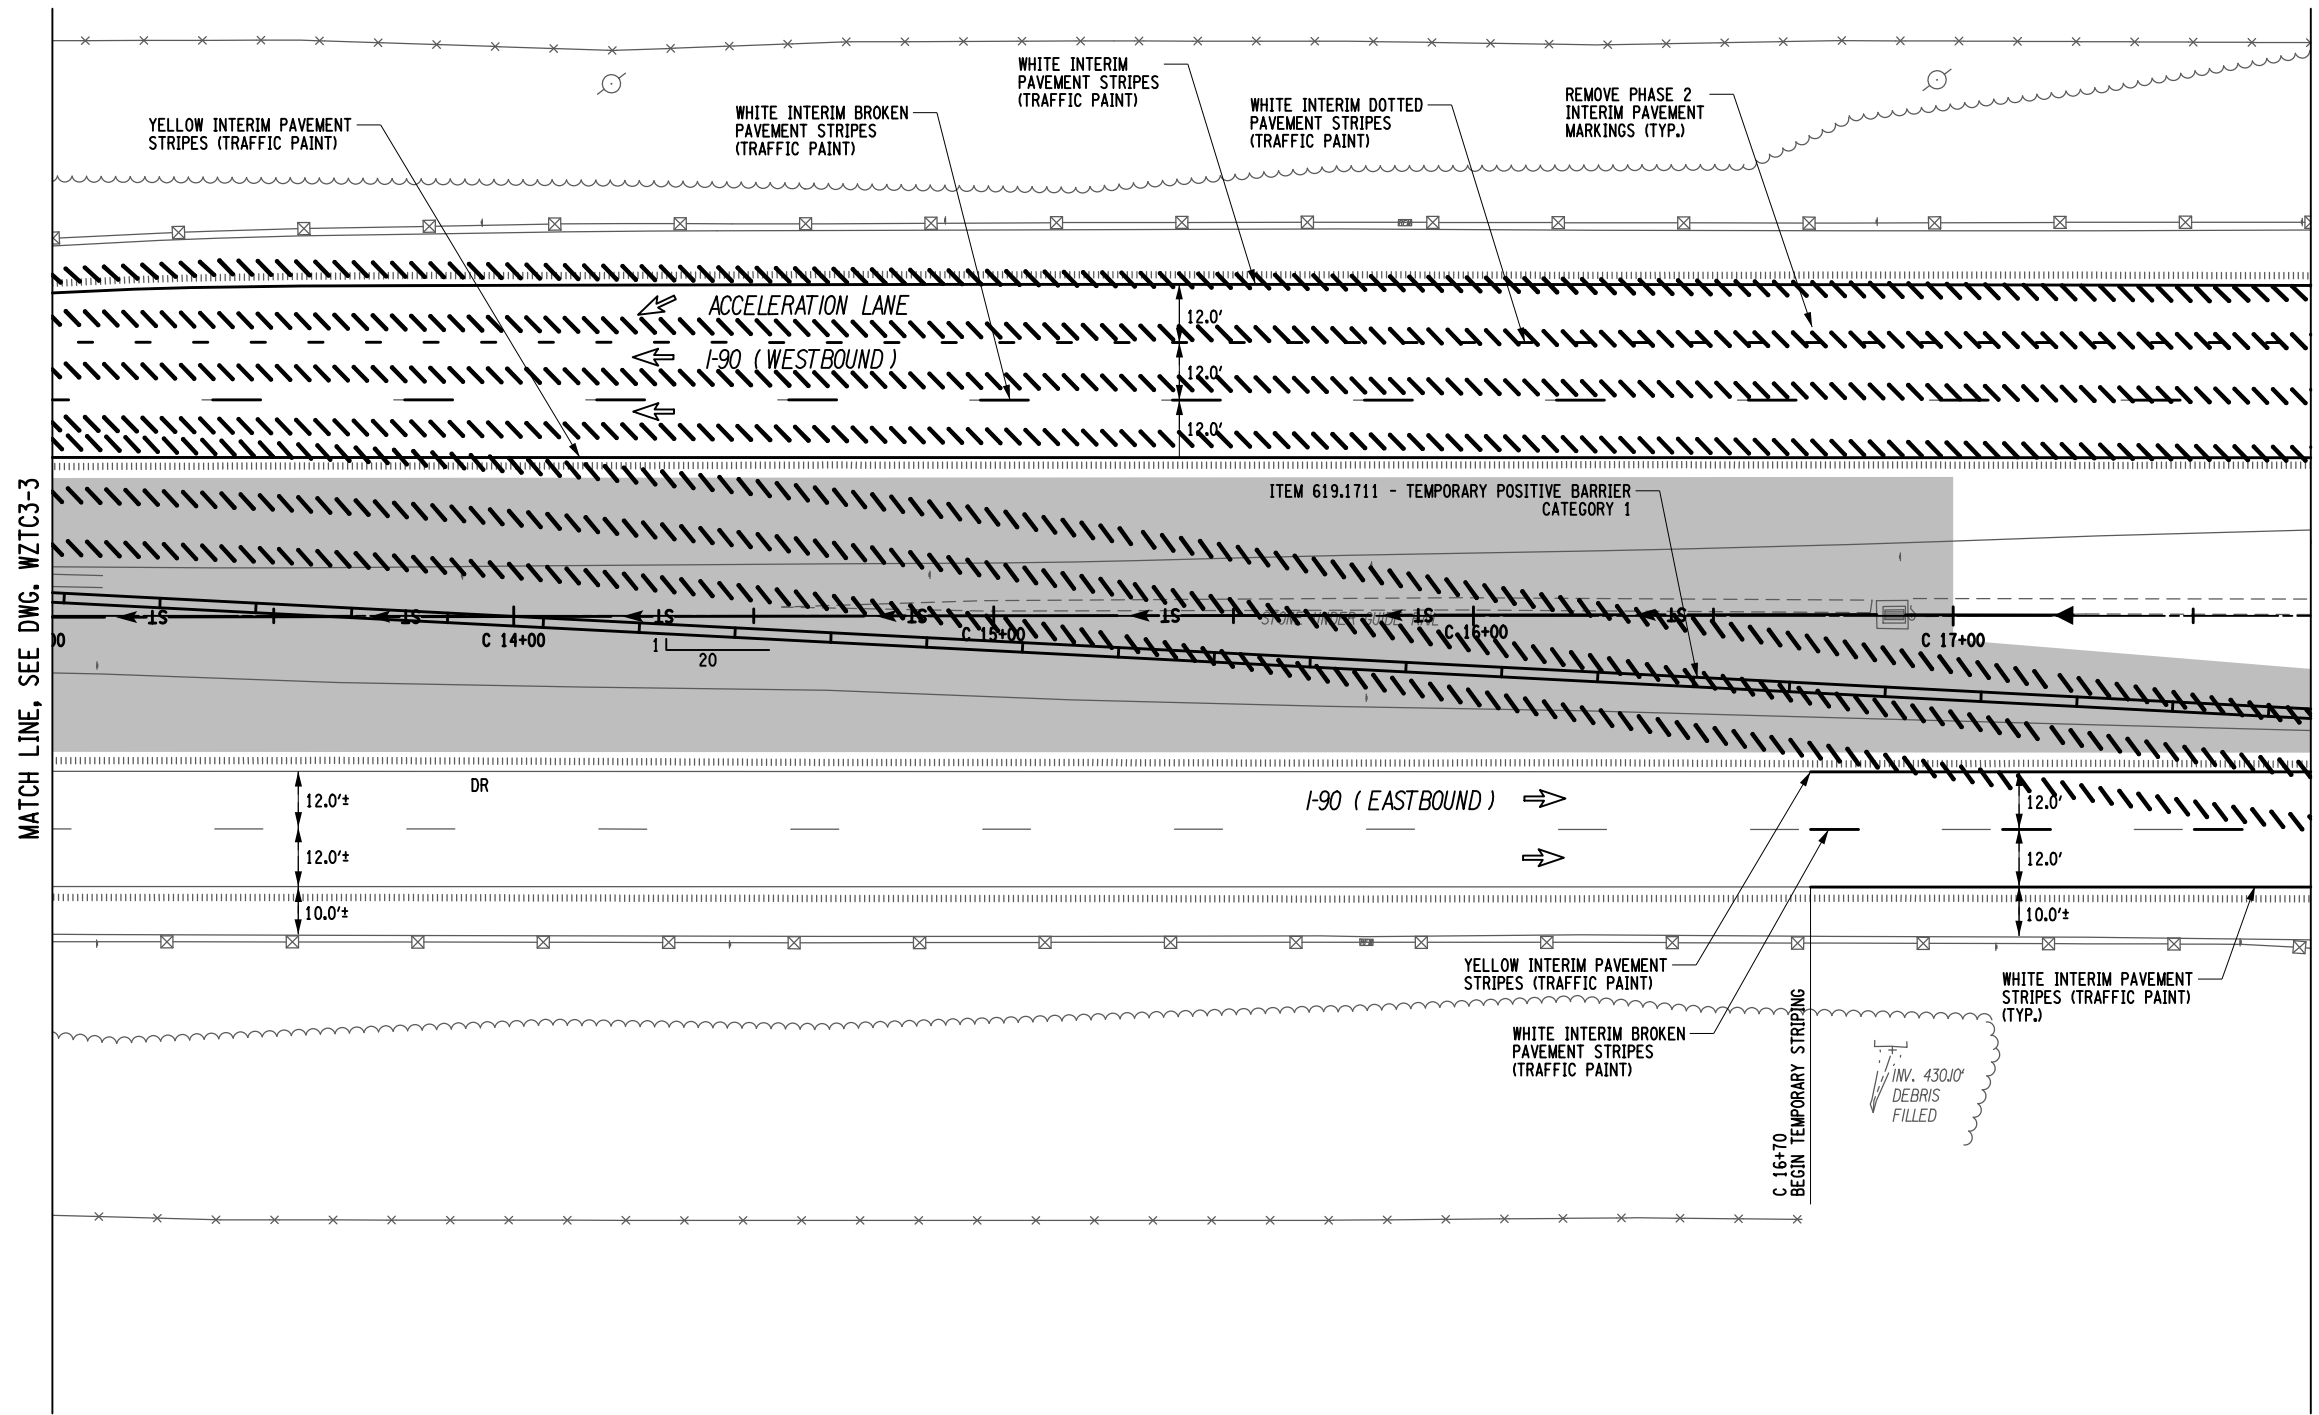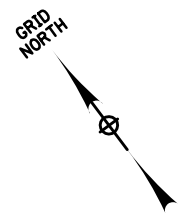


MATCH LINE, SEE DWG. WZTC3-3

MATCH LINE, SEE DWG. WZTC3-5

DESIGNED BY: T. SAMSON
CHECKED BY: D. CLARK
DRAFTED BY: T. SAMSON/W. DILONE
CHECKED BY: R. PAPA/J.D. CLARK
PW/

LEGEND	
	6" INTERIM PAVEMENT MARKING STRIPES (TRAFFIC PAINT)
	ITEM 619.10010125
	ITEM 619.10010125
	CONSTRUCTION DRUM @ 40.0' O.C. (MAX.), ITEM 619.01
	TEMPORARY SIGN, ITEM 619.01
	DIRECTION OF TRAFFIC
	PAVED MEDIAN CONSTRUCTION (COMPLETED UNDER PHASE 1)
	REMOVE PAVEMENT MARKING STRIPES, 6" TRAFFIC PAINT ITEM 619.08010125
	TEMPORARY POSITIVE BARRIER

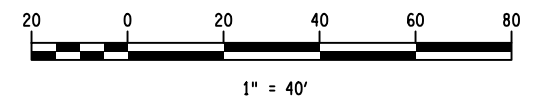

ALTERED ON:	AFFIXED ON: 11/30/2023
SIGNATURE: STAMP:	SIGNATURE: STAMP:

IT IS A VIOLATION OF LAW FOR ANY PERSON, UNLESS THEY ARE ACTING UNDER THE DIRECTION OF A LICENSED PROFESSIONAL ENGINEER, ARCHITECT, LANDSCAPE ARCHITECT, OR LAND SURVEYOR, TO ALTER AN ITEM IN ANY WAY. IF AN ITEM BEARING THE STAMP OF A LICENSED PROFESSIONAL IS ALTERED, THE ALTERING ENGINEER, ARCHITECT, LANDSCAPE ARCHITECT, OR LAND SURVEYOR SHALL STAMP THE DOCUMENT AND INCLUDE THE NOTATION "ALTERED BY" FOLLOWED BY THEIR SIGNATURE, THE DATE OF SUCH ALTERATION, AND A SPECIFIC DESCRIPTION OF THE ALTERATION.



REVISIONS			
DATE	DESCRIPTION	BY	SYM.

Thruway Authority


Ravi Engineering & Land Surveying, P.C.

TITLE OF PROJECT STERLING CREEK BRIDGE REHABILITATION	CONTRACT NUMBER: TAS 24-5B
LOCATION OF PROJECT SYRACUSE DIVISION BIN 5516091 & 5516092 MP 227.40 & MP 227.41	DATE: Nov. 2023
TITLE OF DRAWING WORK ZONE TRAFFIC CONTROL PLAN-MAINLINE PHASE 3 WINTER	DRAWING NUMBER: WZTC3-4

PW/ CHECKED BY: R. PAPA/J.D. CLARK
 DRAFTED BY: T. SAMSON/W. DILONE
 CHECKED BY: D. CLARK
 DESIGNED BY: T. SAMSON
 DESIGN SUPERVISOR: R. PAPA/J

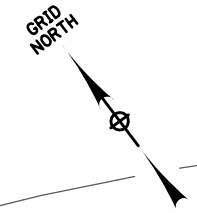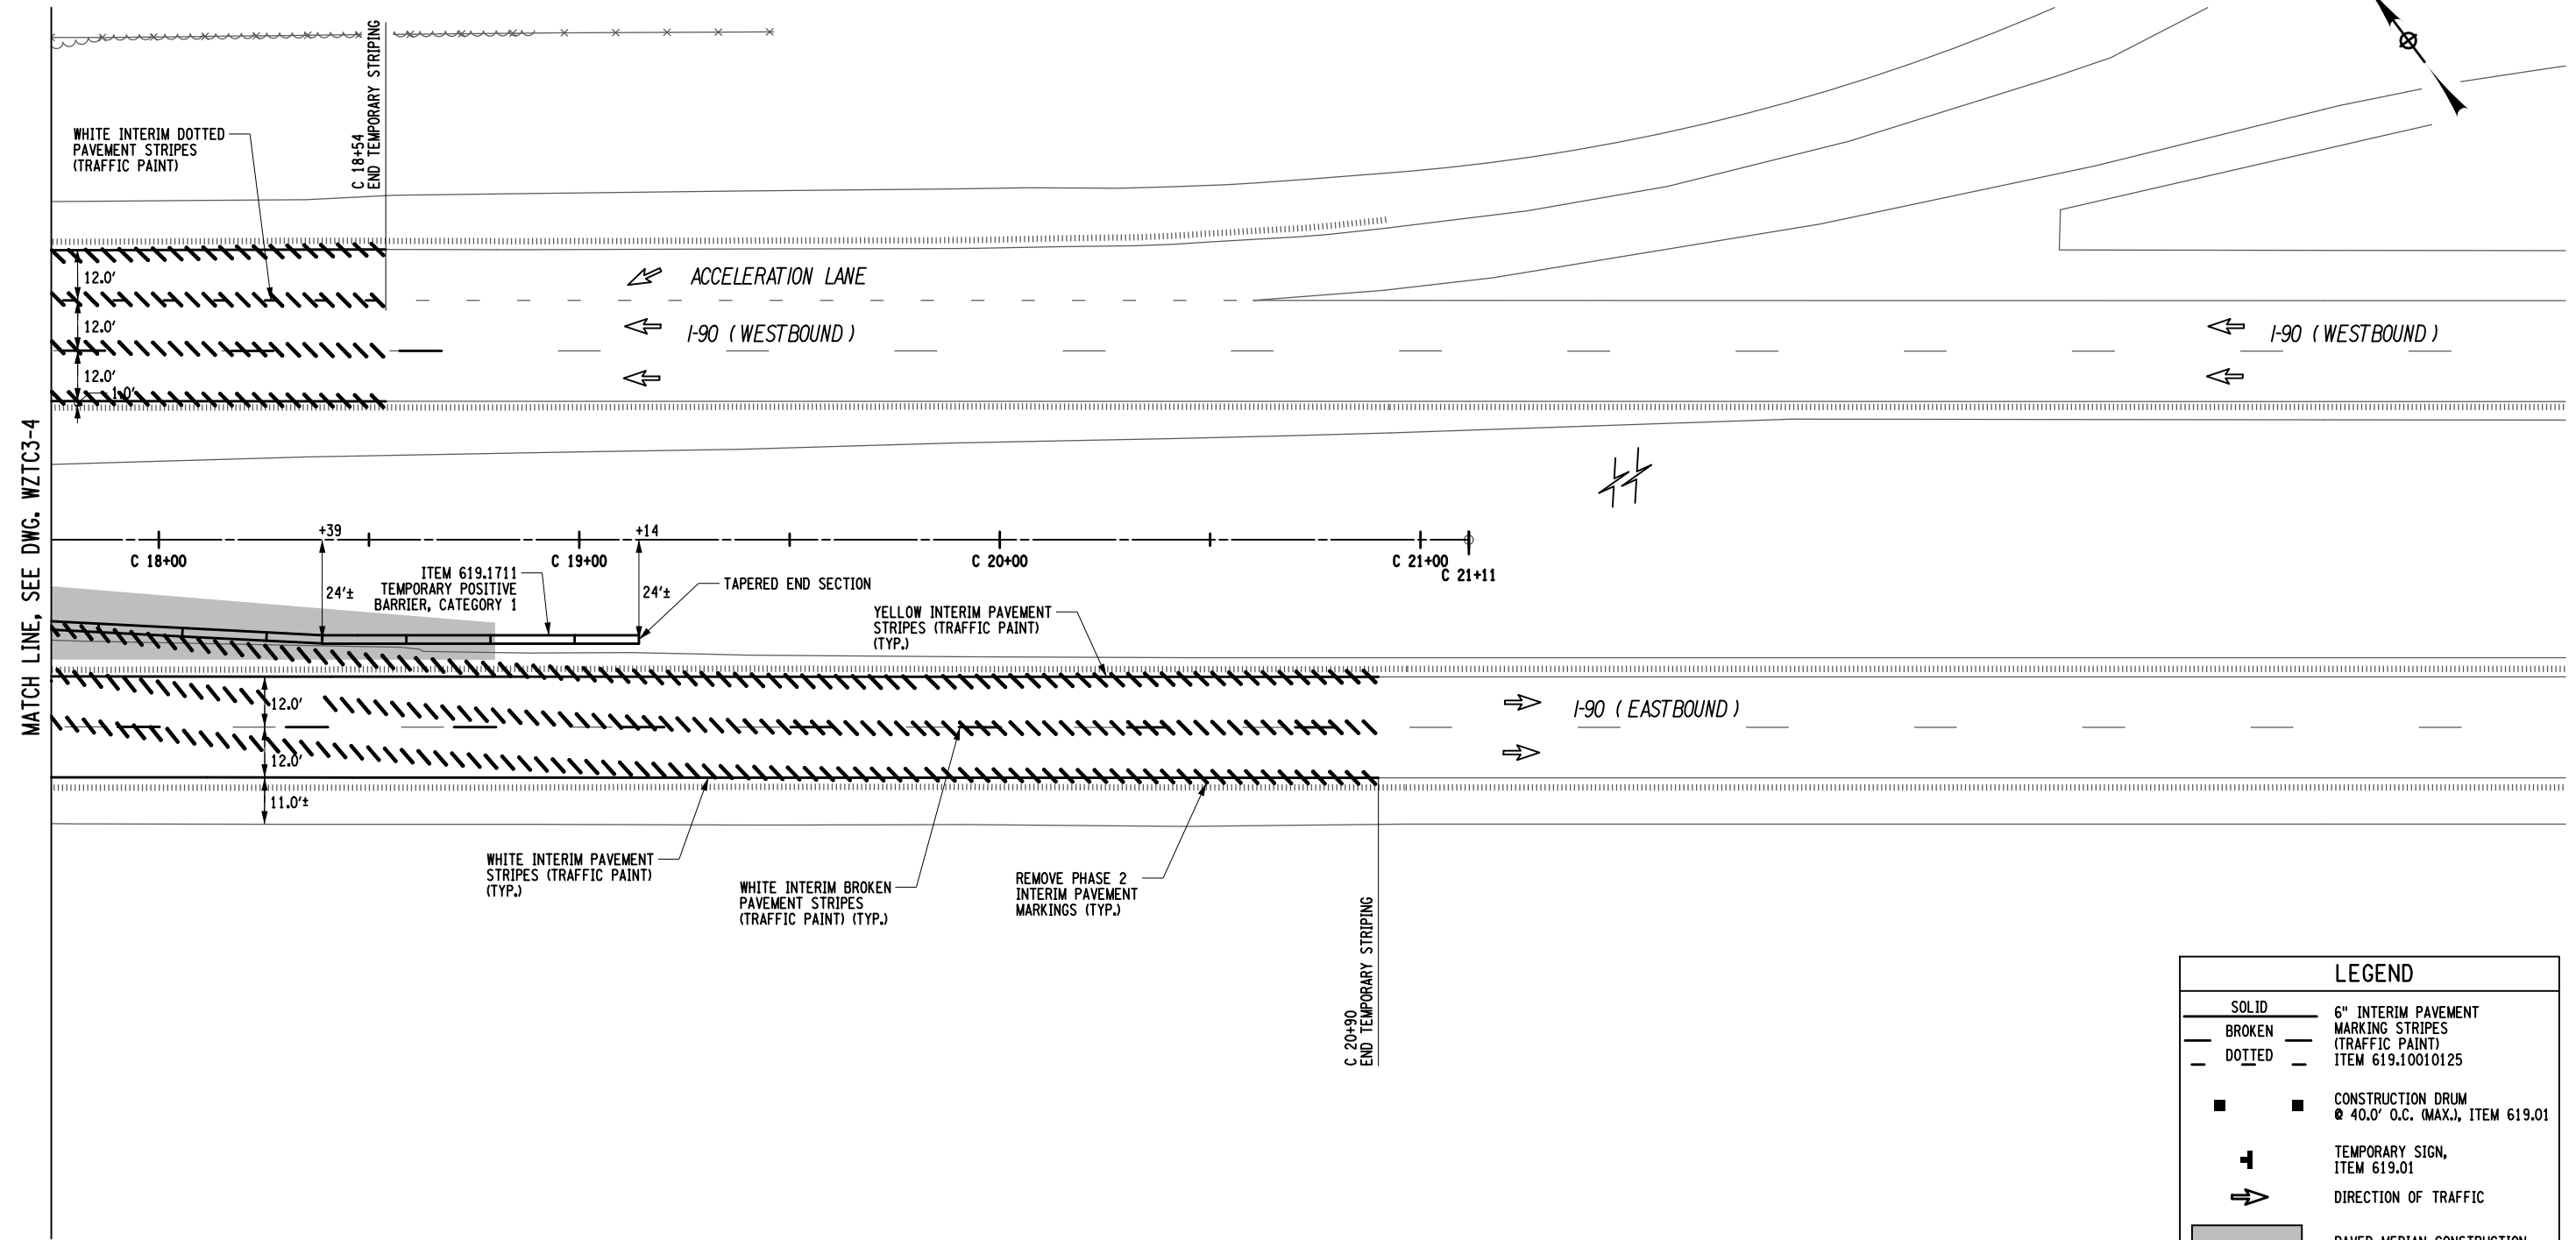

LEGEND	
SOLID	6" INTERIM PAVEMENT MARKING STRIPES (TRAFFIC PAINT)
BROKEN	ITEM 619.10010125
DOTTED	CONSTRUCTION DRUM @ 40.0' O.C. (MAX.), ITEM 619.01
■	TEMPORARY SIGN, ITEM 619.01
➔	DIRECTION OF TRAFFIC
■	PAVED MEDIAN CONSTRUCTION (COMPLETED UNDER PHASE 1)
////	REMOVE PAVEMENT MARKING STRIPES, 6" TRAFFIC PAINT ITEM 619.08010125
▬	TEMPORARY POSITIVE BARRIER

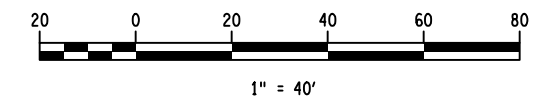


ALTERED ON:	AFFIXED ON: 11/08/2023
SIGNATURE: STAMP:	SIGNATURE: STAMP:

IT IS A VIOLATION OF LAW FOR ANY PERSON, UNLESS THEY ARE ACTING UNDER THE DIRECTION OF A LICENSED PROFESSIONAL ENGINEER, ARCHITECT, LANDSCAPE ARCHITECT, OR LAND SURVEYOR, TO ALTER AN ITEM IN ANY WAY. IF AN ITEM BEARING THE STAMP OF A LICENSED PROFESSIONAL IS ALTERED, THE ALTERING ENGINEER, ARCHITECT, LANDSCAPE ARCHITECT, OR LAND SURVEYOR SHALL STAMP THE DOCUMENT AND INCLUDE THE NOTATION "ALTERED BY" FOLLOWED BY THEIR SIGNATURE, THE DATE OF SUCH ALTERATION, AND A SPECIFIC DESCRIPTION OF THE ALTERATION.


REVISIONS			
DATE	DESCRIPTION	BY	SYM.

 Thruway Authority	TITLE OF PROJECT STERLING CREEK BRIDGE REHABILITATION	CONTRACT NUMBER: TAS 24-5B
	LOCATION OF PROJECT SYRACUSE DIVISION BIN 5516091 & 5516092 MP 227.40 & MP 227.41	DATE: Nov. 2023
TITLE OF DRAWING WORK ZONE TRAFFIC CONTROL PLAN-MAINLINE PHASE 3 WINTER	DRAWING NUMBER: WZTC3-5	

PW/ CHECKED BY: R. PAPAJO, CLARK
 DRAFTED BY: T. SAMSON, W. DILONE
 CHECKED BY: D. CLARK
 DESIGNED BY: T. SAMSON
 DESIGN SUPERVISOR: R. PAPAJO

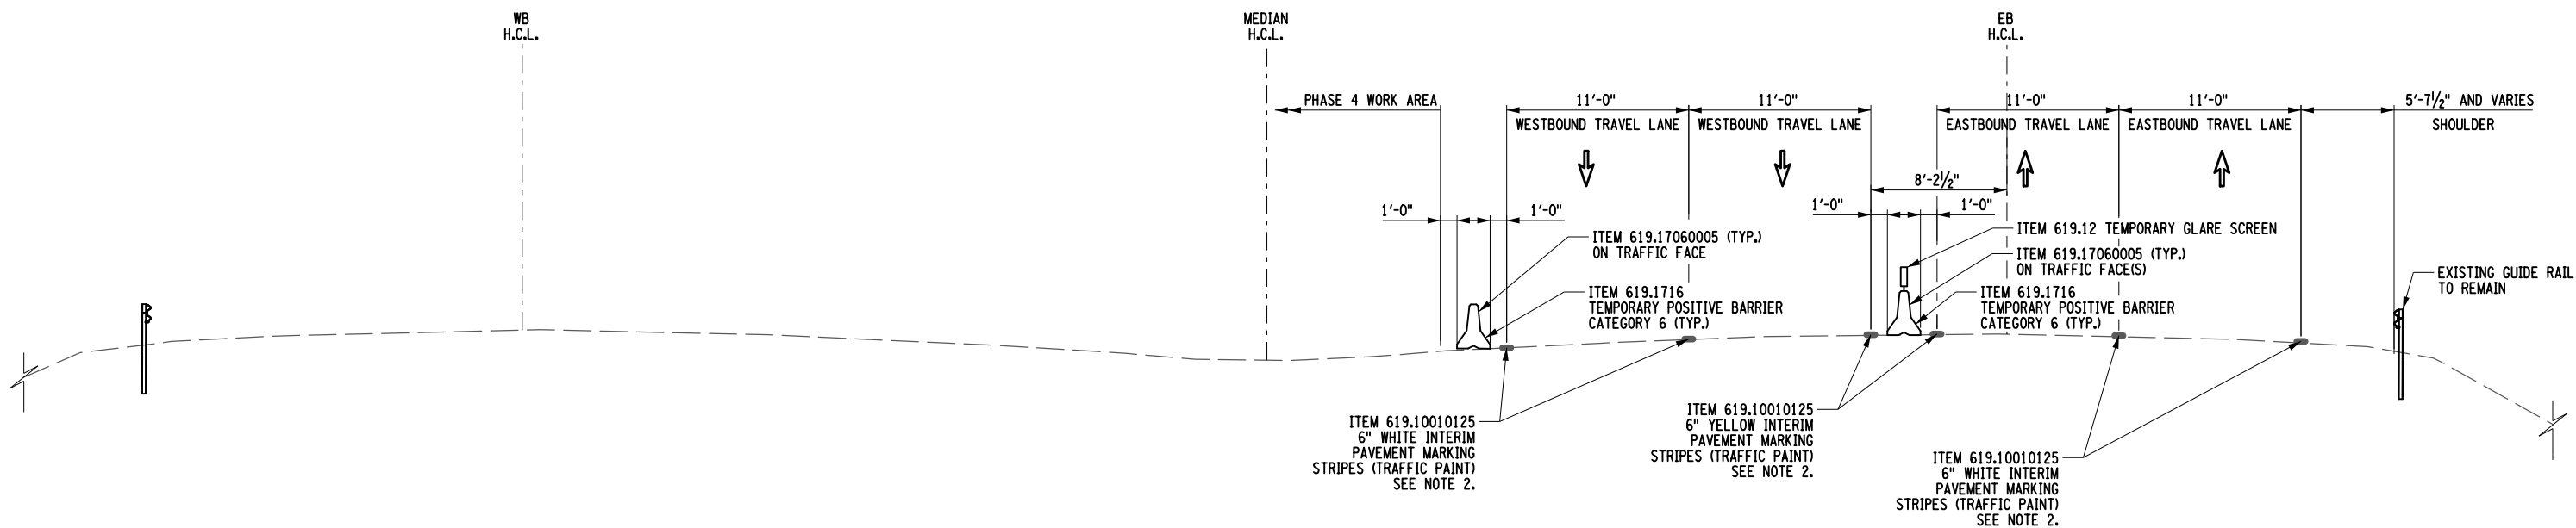

MAINLINE PHASE 4 - SECTION B-B
(NOT TO SCALE)

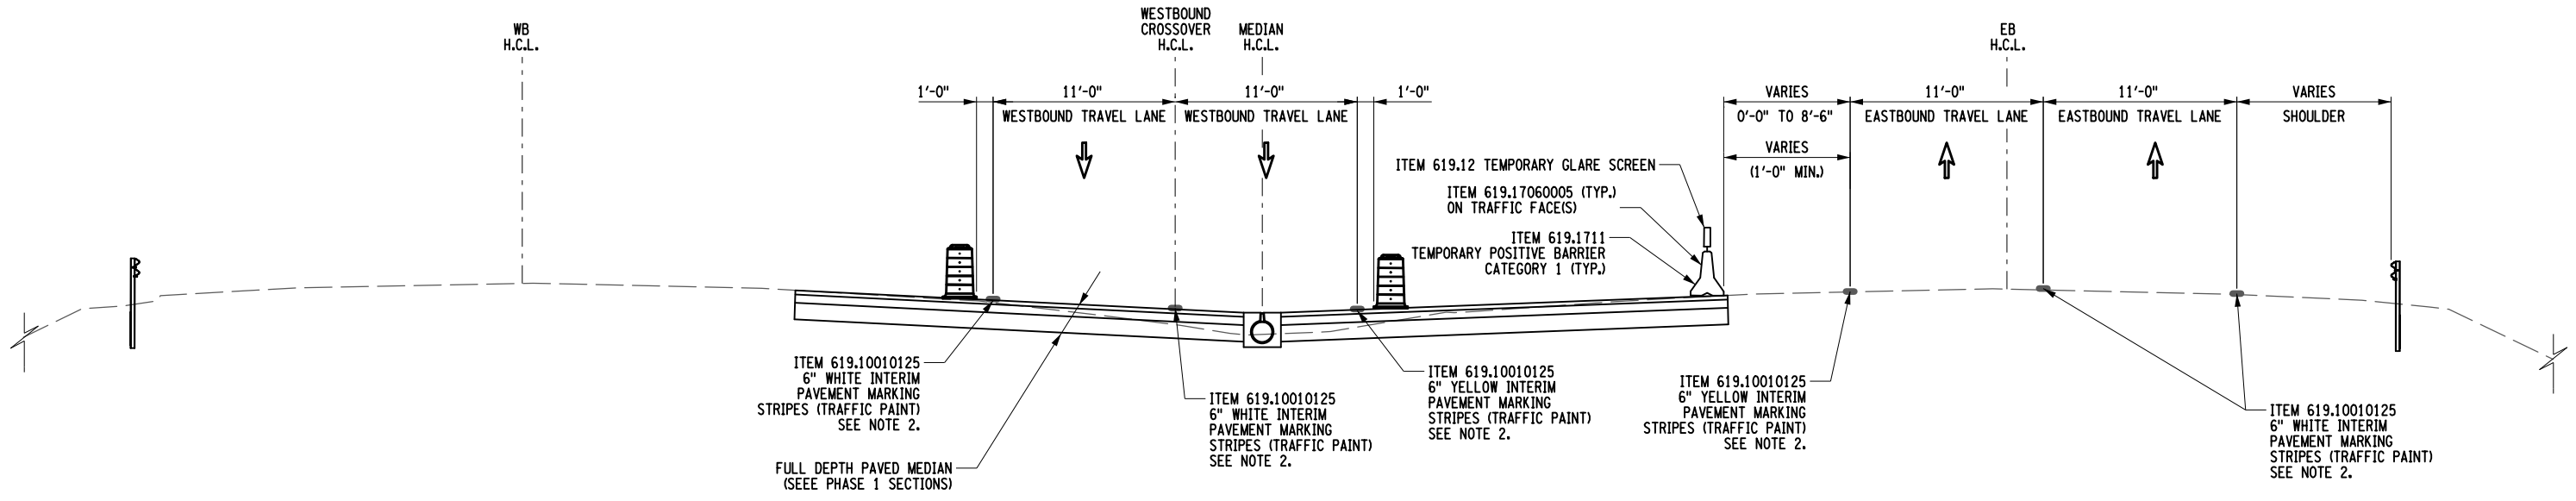

MAINLINE PHASE 4 - WESTBOUND CROSSOVER - SECTION C-C
(NOT TO SCALE)

- NOTES:**
- CONTRACTOR SHALL PIN TEMPORARY POSITIVE BARRIER TO EXISTING BRIDGE DECK. CONTRACTOR SHALL NOT PIN TEMPORARY POSITIVE BARRIER TO PROPOSED BRIDGE DECK, APPROACH SLAB, OR FINISHED ASPHALT SURFACE. UNDER THESE SITUATIONS THE CONTRACTOR SHALL INSTALL ITEM 619.1715 TEMPORARY BARRIER CATEGORY 5.
 - CONTRACTOR SHALL REPLACE ITEM 619.10010125, INTERIM PAVEMENT MARKING STRIPES (TRAFFIC PAINT), WITH ITEM 619.100104, INTERIM PAVEMENT MARKING STRIPES (REMOVABLE WET REFLECTIVE TAPE), WHEN PAVEMENT MARKINGS ARE APPLIED TO THE PROPOSED BRIDGE DECK, APPROACH SLAB, OR FINISHED ASPHALT SURFACE.



ALTERED ON:	AFFIXED ON: 11/08/2023
SIGNATURE: STAMP:	SIGNATURE: STAMP:

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REVISIONS			
DATE	DESCRIPTION	BY	SYM.

 Thruway Authority	TITLE OF PROJECT STERLING CREEK BRIDGE REHABILITATION	CONTRACT NUMBER: TAS 24-5B
	LOCATION OF PROJECT SYRACUSE DIVISION BIN 5516091 & 5516092 MP 227.40 & MP 227.41	DATE: Nov. 2023
	TITLE OF DRAWING WORK ZONE TRAFFIC CONTROL PLAN-MAINLINE PHASE 4	DRAWING NUMBER: WZTC4-1


PW/ R. PAPA/J.D. CLARK
 CHECKED BY: T. SAMSON/W. DILONE
 DRAFTED BY: D. CLARK
 CHECKED BY: T. SAMSON
 DESIGNED BY: R. PAPA/J

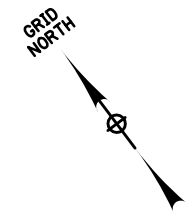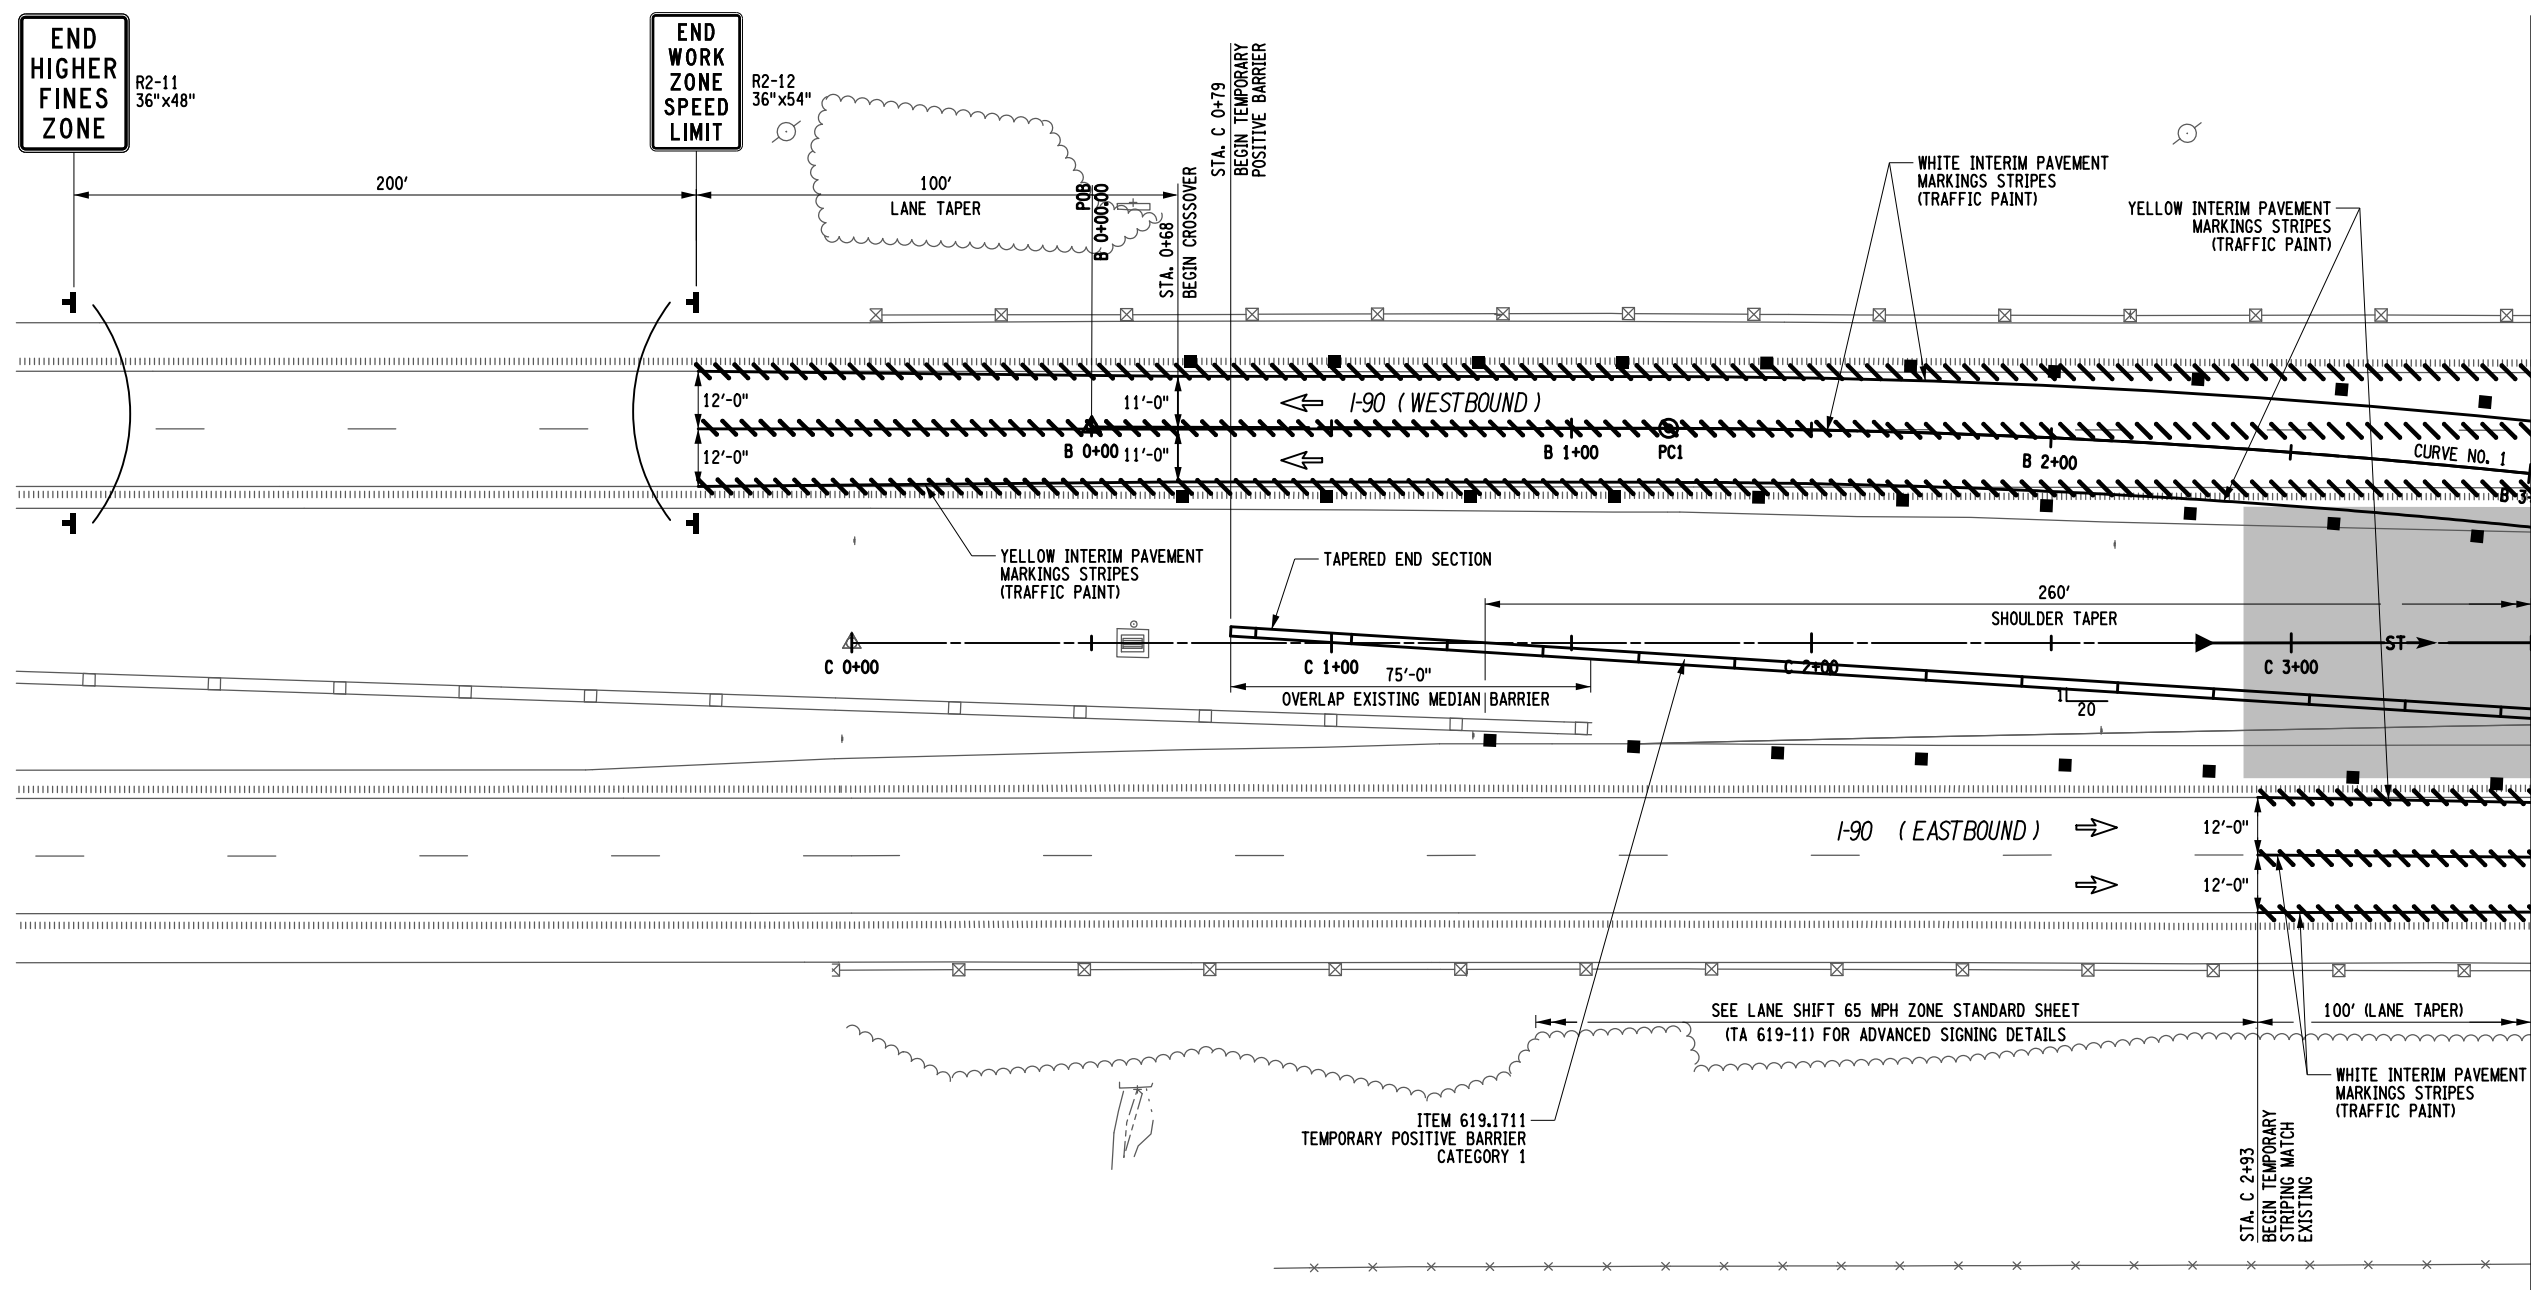

MATCH LINE, SEE DWG. WZTC4-3

LEGEND

- 6" INTERIM PAVEMENT MARKINGS STRIPES (TRAFFIC PAINT), ITEM 619.10010125
- CONSTRUCTION DRUM @ 40.0' O.C. (MAX.), ITEM 619.01
- TEMPORARY SIGN, ITEM 619.01
- DIRECTION OF TRAFFIC
- PHASE 4 WORK SPACE
- PAVED MEDIAN CONSTRUCTION (COMPLETED UNDER PHASE 1)
- REMOVE PAVEMENT MARKING STRIPES, 619.08010125 (6" TRAFFIC PAINT) 619.08010225 (6" EPOXY PAINT)
- TEMPORARY POSITIVE BARRIER

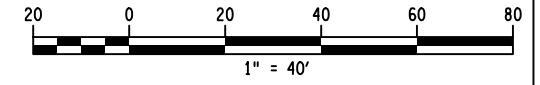

POB - STA. B 0+00
 N 1547890.8537
 E 328629.8066

WESTBOUND CROSSOVER CURVE #1	
R = 1,800 FT.	PC1 - STA. B 1+20.25 N 1547818.2572 E 328725.6764
$\Delta = 9^{\circ}-30'-35.286''$	
L = 298.759 FT.	PI1 - STA. B 2+69.98 N 1547727.8709 E 328845.0390
D = 3^{\circ}-10'-59.156''	
T = 149.724 FT.	PT1 - STA. B 4+19.01 N 1547619.0061 E 328947.8280



ALTERED ON: SIGNATURE: STAMP:	AFFIXED ON: 11/30/2023 SIGNATURE:
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REVISIONS			
DATE	DESCRIPTION	BY	SYM.


 Thruway Authority	TITLE OF PROJECT STERLING CREEK BRIDGE REHABILITATION	CONTRACT NUMBER: TAS 24-5B
	LOCATION OF PROJECT SYRACUSE DIVISION BIN 5516091 & 5516092 MP 227.40 & MP 227.41	DATE: Nov. 2023
	TITLE OF DRAWING WORK ZONE TRAFFIC CONTROL PLAN-MAINLINE PHASE 4	DRAWING NUMBER: WZTC4-2

PW/ CHECKED BY: R. PAPA/J.D. CLARK
 DRAFTED BY: T. SAMSON/W. DILONE
 CHECKED BY: D. CLARK
 DESIGNED BY: T. SAMSON
 DESIGN SUPERVISOR: R. PAPA/J




MATCH LINE, SEE DWG. WZTC4-2

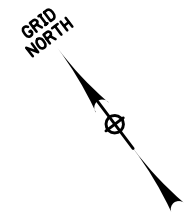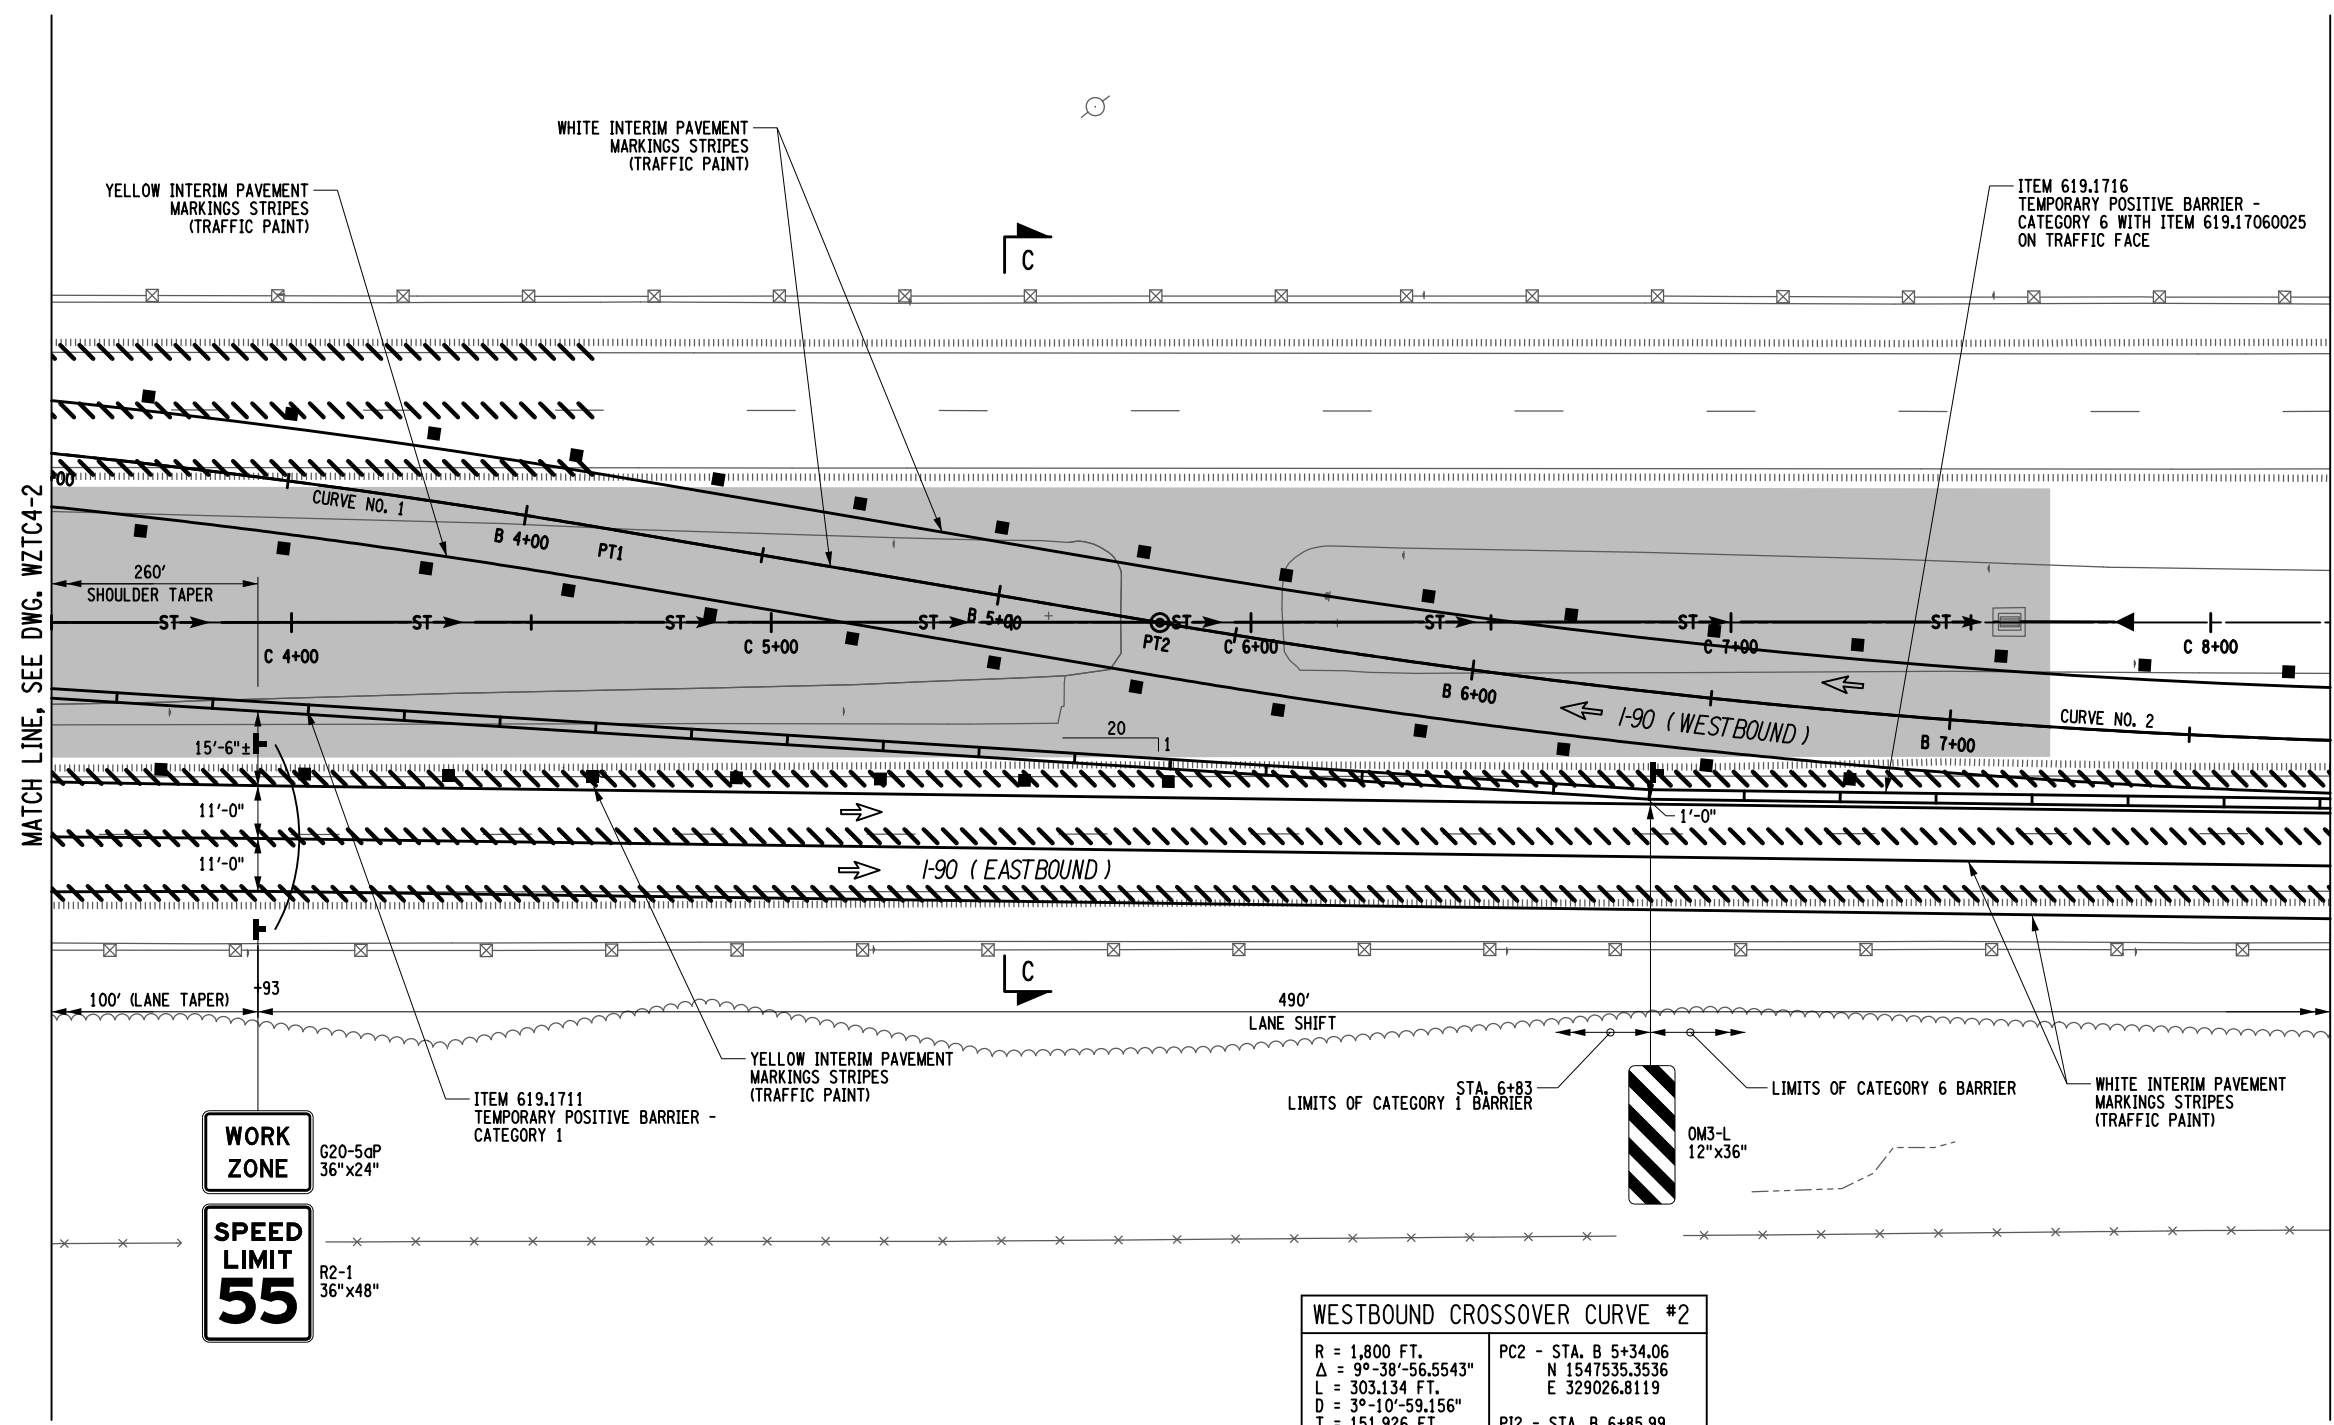MATCH LINE, SEE DWG. WZTC4-4

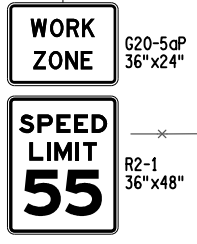

WESTBOUND CROSSOVER CURVE #2	
R = 1,800 FT.	PC2 - STA. B 5+34.06
$\Delta = 9^{\circ}-38'-56.5543''$	N 1547535.3536
L = 303.134 FT.	E 329026.8119
D = $3^{\circ}-10'-59.156''$	PI2 - STA. B 6+85.99
T = 151.926 FT.	N 1547424.8873
	E 329131.1130
	PT2 - STA. B 8+37.20
	N 1547333.4660
	E 329252.4541

LEGEND	
	6" INTERIM PAVEMENT MARKINGS STRIPES (TRAFFIC PAINT), ITEM 619.10010125
	CONSTRUCTION DRUM @ 40.0' O.C. (MAX.), ITEM 619.01
	TEMPORARY SIGN, ITEM 619.01
	DIRECTION OF TRAFFIC
	PHASE 4 WORK SPACE
	PAVED MEDIAN CONSTRUCTION (COMPLETED UNDER PHASE 1)
	REMOVE PAVEMENT MARKING STRIPES, ITEM 619.08010125 (6" TRAFFIC PAINT) ITEM 619.08010225 (6" EPOXY PAINT)
	TEMPORARY POSITIVE BARRIER

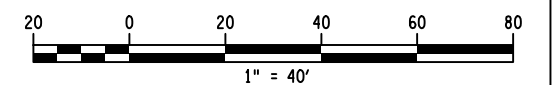

ALTERED ON:	AFFIXED ON: 11/30/2023
SIGNATURE: STAMP:	SIGNATURE: STAMP:

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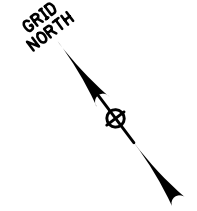
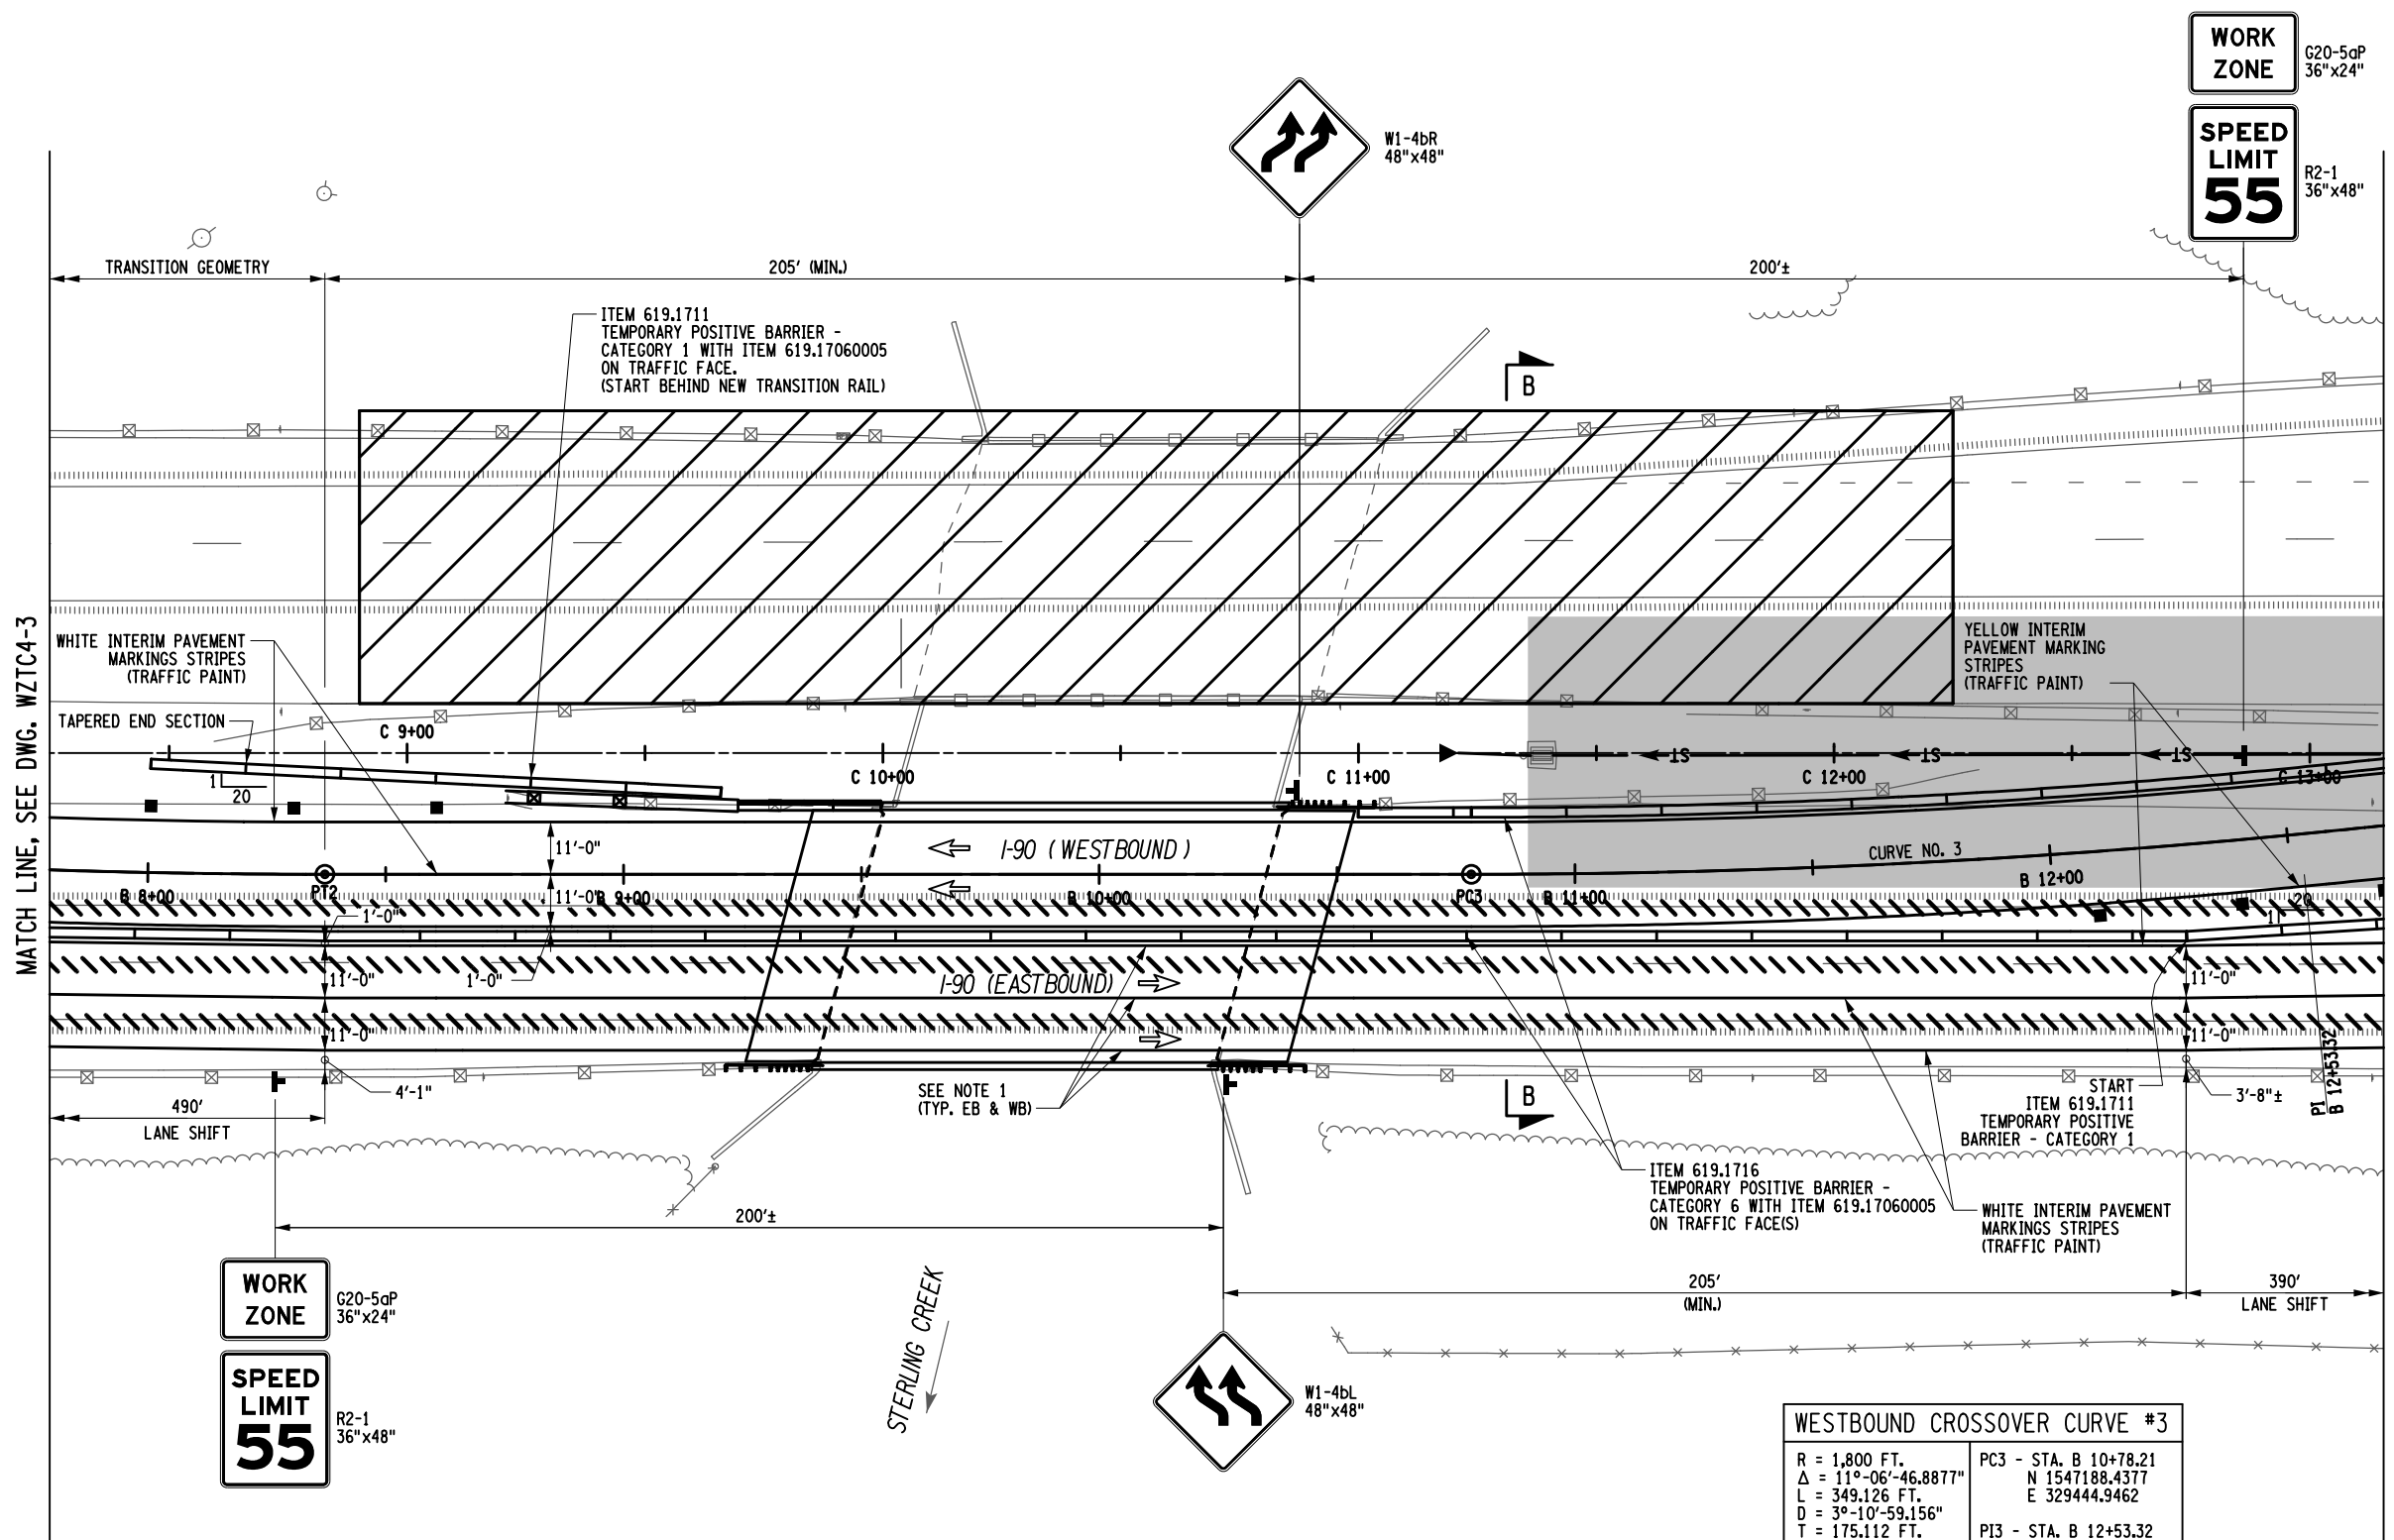
REVISIONS			
DATE	DESCRIPTION	BY	SYM.

Thruway Authority

Ravi Engineering & Land Surveying, P.C.

TITLE OF PROJECT STERLING CREEK BRIDGE REHABILITATION	CONTRACT NUMBER: TAS 24-5B
LOCATION OF PROJECT SYRACUSE DIVISION BIN 5516091 & 5516092 MP 227.40 & MP 227.41	DATE: Nov. 2023
TITLE OF DRAWING WORK ZONE TRAFFIC CONTROL PLAN-MAINLINE PHASE 4	DRAWING NUMBER: WZTC4-3

PW/ R. PAPA/ J. CLARK
 CHECKED BY: T. SAMSON/ W. DILONE
 DRAFTED BY: D. CLARK
 CHECKED BY: T. SAMSON
 DESIGN SUPERVISOR: R. PAPA/ J. CLARK




LEGEND

- 6" INTERIM PAVEMENT MARKINGS STRIPES (TRAFFIC PAINT), ITEM 619.10010125
- CONSTRUCTION DRUM @ 40.0' O.C. (MAX.), ITEM 619.01
- TEMPORARY SIGN, ITEM 619.01
- DIRECTION OF TRAFFIC
- PHASE 4 WORK SPACE
- PAVED MEDIAN CONSTRUCTION (COMPLETED UNDER PHASE 1)
- REMOVE PAVEMENT MARKING STRIPES, ITEM 619.08010125 (6" TRAFFIC PAINT) ITEM 619.08010225 (6" EPOXY PAINT) ITEM 619.08010425 (6" TAPE)
- TEMPORARY POSITIVE BARRIER

WESTBOUND CROSSOVER CURVE #3

R = 1,800 FT.	PC3 - STA. B 10+78.21
Δ = 11°-06'-46.8877"	N 1547188.4377
L = 349.126 FT.	E 329444.9462
D = 3°-10'-59.156"	PI3 - STA. B 12+53.32
T = 175.112 FT.	N 1547083.0641
	E 329584.8058
	PT3 - STA. B 14+27.33
	N 1547006.6236
	E 329742.3532

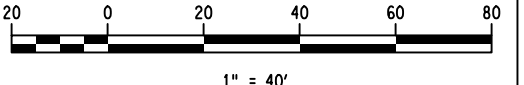

ALTERED ON:
SIGNATURE:
STAMP:

AFFIXED ON:
11/30/2023
SIGNATURE:
STAMP:

NOTE:
1. ON NEW BRIDGE DECK AND ANY FINAL PAVEMENT SURFACES CONTRACTOR SHALL SUBSTITUTE ITEM 619.10010125, INTERIM PAVEMENT MARKINGS (TRAFFIC PAINT), WITH ITEM 619.100104, INTERIM PAVEMENT MARKINGS (REMOVABLE WET REFLECTIVE TAPE)



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REVISIONS			
DATE	DESCRIPTION	BY	SYM.

NEW YORK STATE OF OPPORTUNITY
Thruway Authority
 RAVI ENGINEERING & LAND SURVEYING, P.C.

TITLE OF PROJECT STERLING CREEK BRIDGE REHABILITATION	CONTRACT NUMBER: TAS 24-5B
LOCATION OF PROJECT SYRACUSE DIVISION BIN 5516091 & 5516092 MP 227.40 & MP 227.41	DATE: Nov. 2023
TITLE OF DRAWING WORK ZONE TRAFFIC CONTROL PLAN-MAINLINE PHASE 4	DRAWING NUMBER: WZTC4-4

PW/ R. PAPA, J.D. CLARK
 CHECKED BY: T. SAMSON, W. DILONE
 DRAFTED BY: D. CLARK
 CHECKED BY: T. SAMSON
 DESIGN SUPERVISOR: R. PAPA

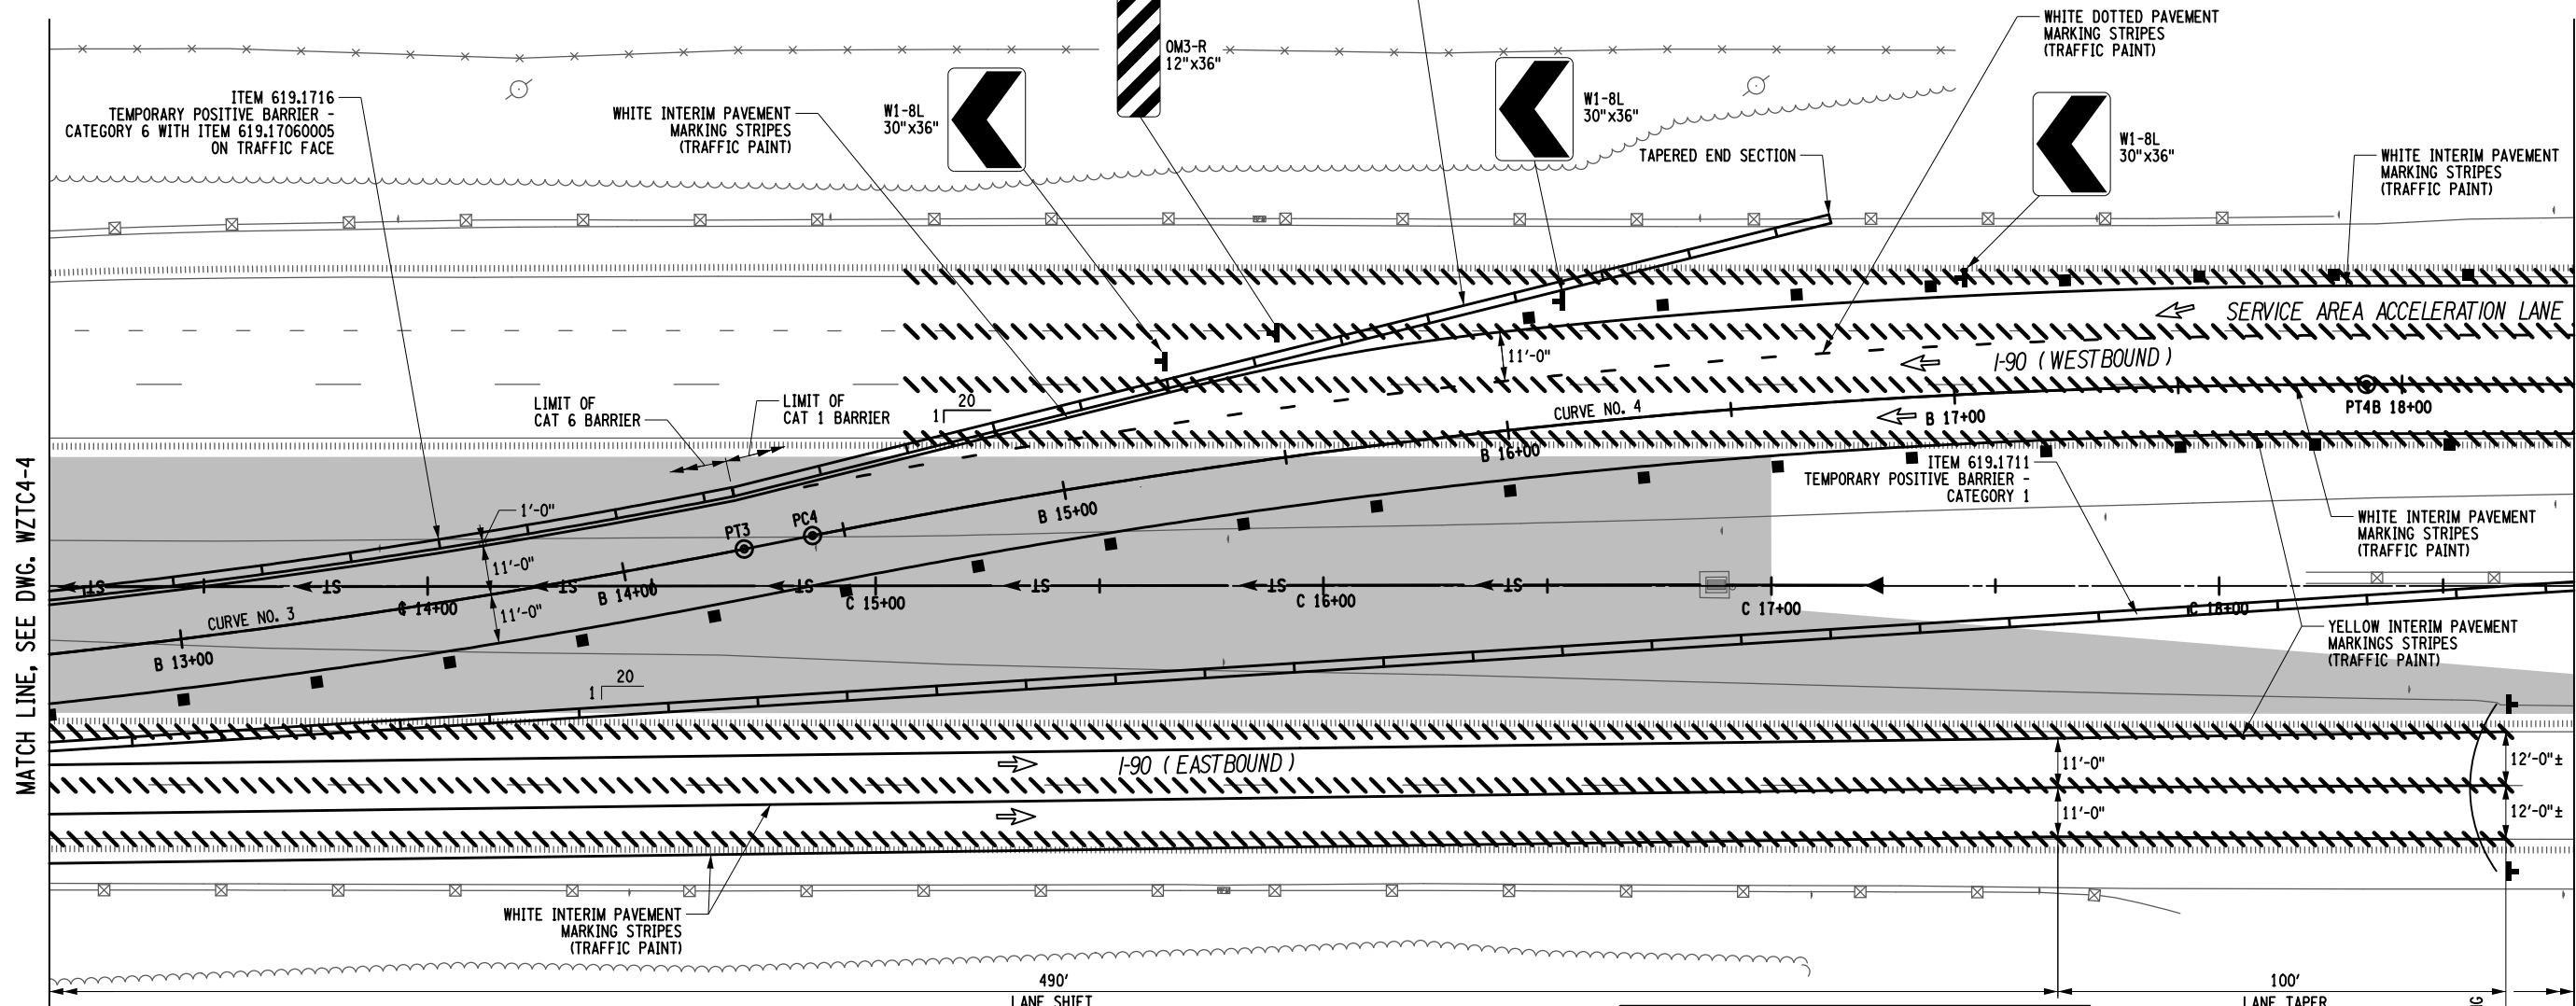
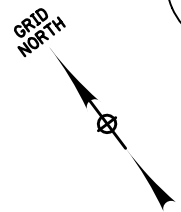


MATCH LINE, SEE DWG. WZTC4-4

MATCH LINE, SEE DWG. WZTC4-6

WESTBOUND CROSSOVER CURVE #4	
R = 1,800 FT.	PC4 - STA. B 14+42.88 N 1546999.8385 E 329756.3376
$\Delta = 11^{\circ}-06'-46.8877''$	PI4 - STA. B 16+17.99 N 1546923.3980 E 329913.8850
L = 349.126 FT.	PT4 - STA. B 17+92.00 N 1546818.0243 E 330053.7446
D = $3^{\circ}-10'-59.156''$	
T = 175.112 FT.	

LEGEND	
SOLID	6" INTERIM PAVEMENT MARKINGS STRIPES (TRAFFIC PAINT), ITEM 619.10010125
DOTTED	CONSTRUCTION DRUM ϕ 40.0' O.C. (MAX.), ITEM 619.01
■	TEMPORARY SIGN, ITEM 619.01
➔	DIRECTION OF TRAFFIC
	PHASE 4 WORK SPACE
	PAVED MEDIAN CONSTRUCTION (COMPLETED UNDER PHASE 1)
	REMOVE PAVEMENT MARKING STRIPES, ITEM 619.08010125 (6" TRAFFIC PAINT) ITEM 619.08010225 (6" EPOXY PAINT)
	TEMPORARY POSITIVE BARRIER

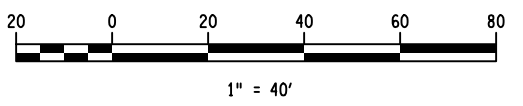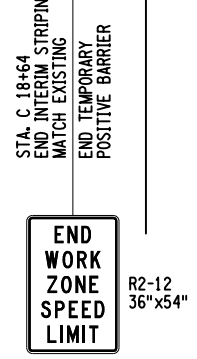

ALTERED ON:	AFFIXED ON: 11/08/2023
SIGNATURE: STAMP:	SIGNATURE: STAMP:


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REVISIONS			
DATE	DESCRIPTION	BY	SYMBOL

 Thruway Authority	TITLE OF PROJECT STERLING CREEK BRIDGE REHABILITATION	CONTRACT NUMBER: TAS 24-5B
	LOCATION OF PROJECT SYRACUSE DIVISION BIN 5516091 & 5516092 MP 227.40 & MP 227.41	DATE: Nov. 2023
	TITLE OF DRAWING WORK ZONE TRAFFIC CONTROL PLAN-MAINLINE PHASE 4	DRAWING NUMBER: WZTC4-5


PW/ CHECKED BY: R. PAPAJD, CLARK
 DRAFTED BY: T. SAMSON/W. DILONE
 CHECKED BY: D. CLARK
 DESIGNED BY: T. SAMSON
 DESIGN SUPERVISOR: R. PAPAJ

MATCH LINE, SEE DWG. WZTC4-5

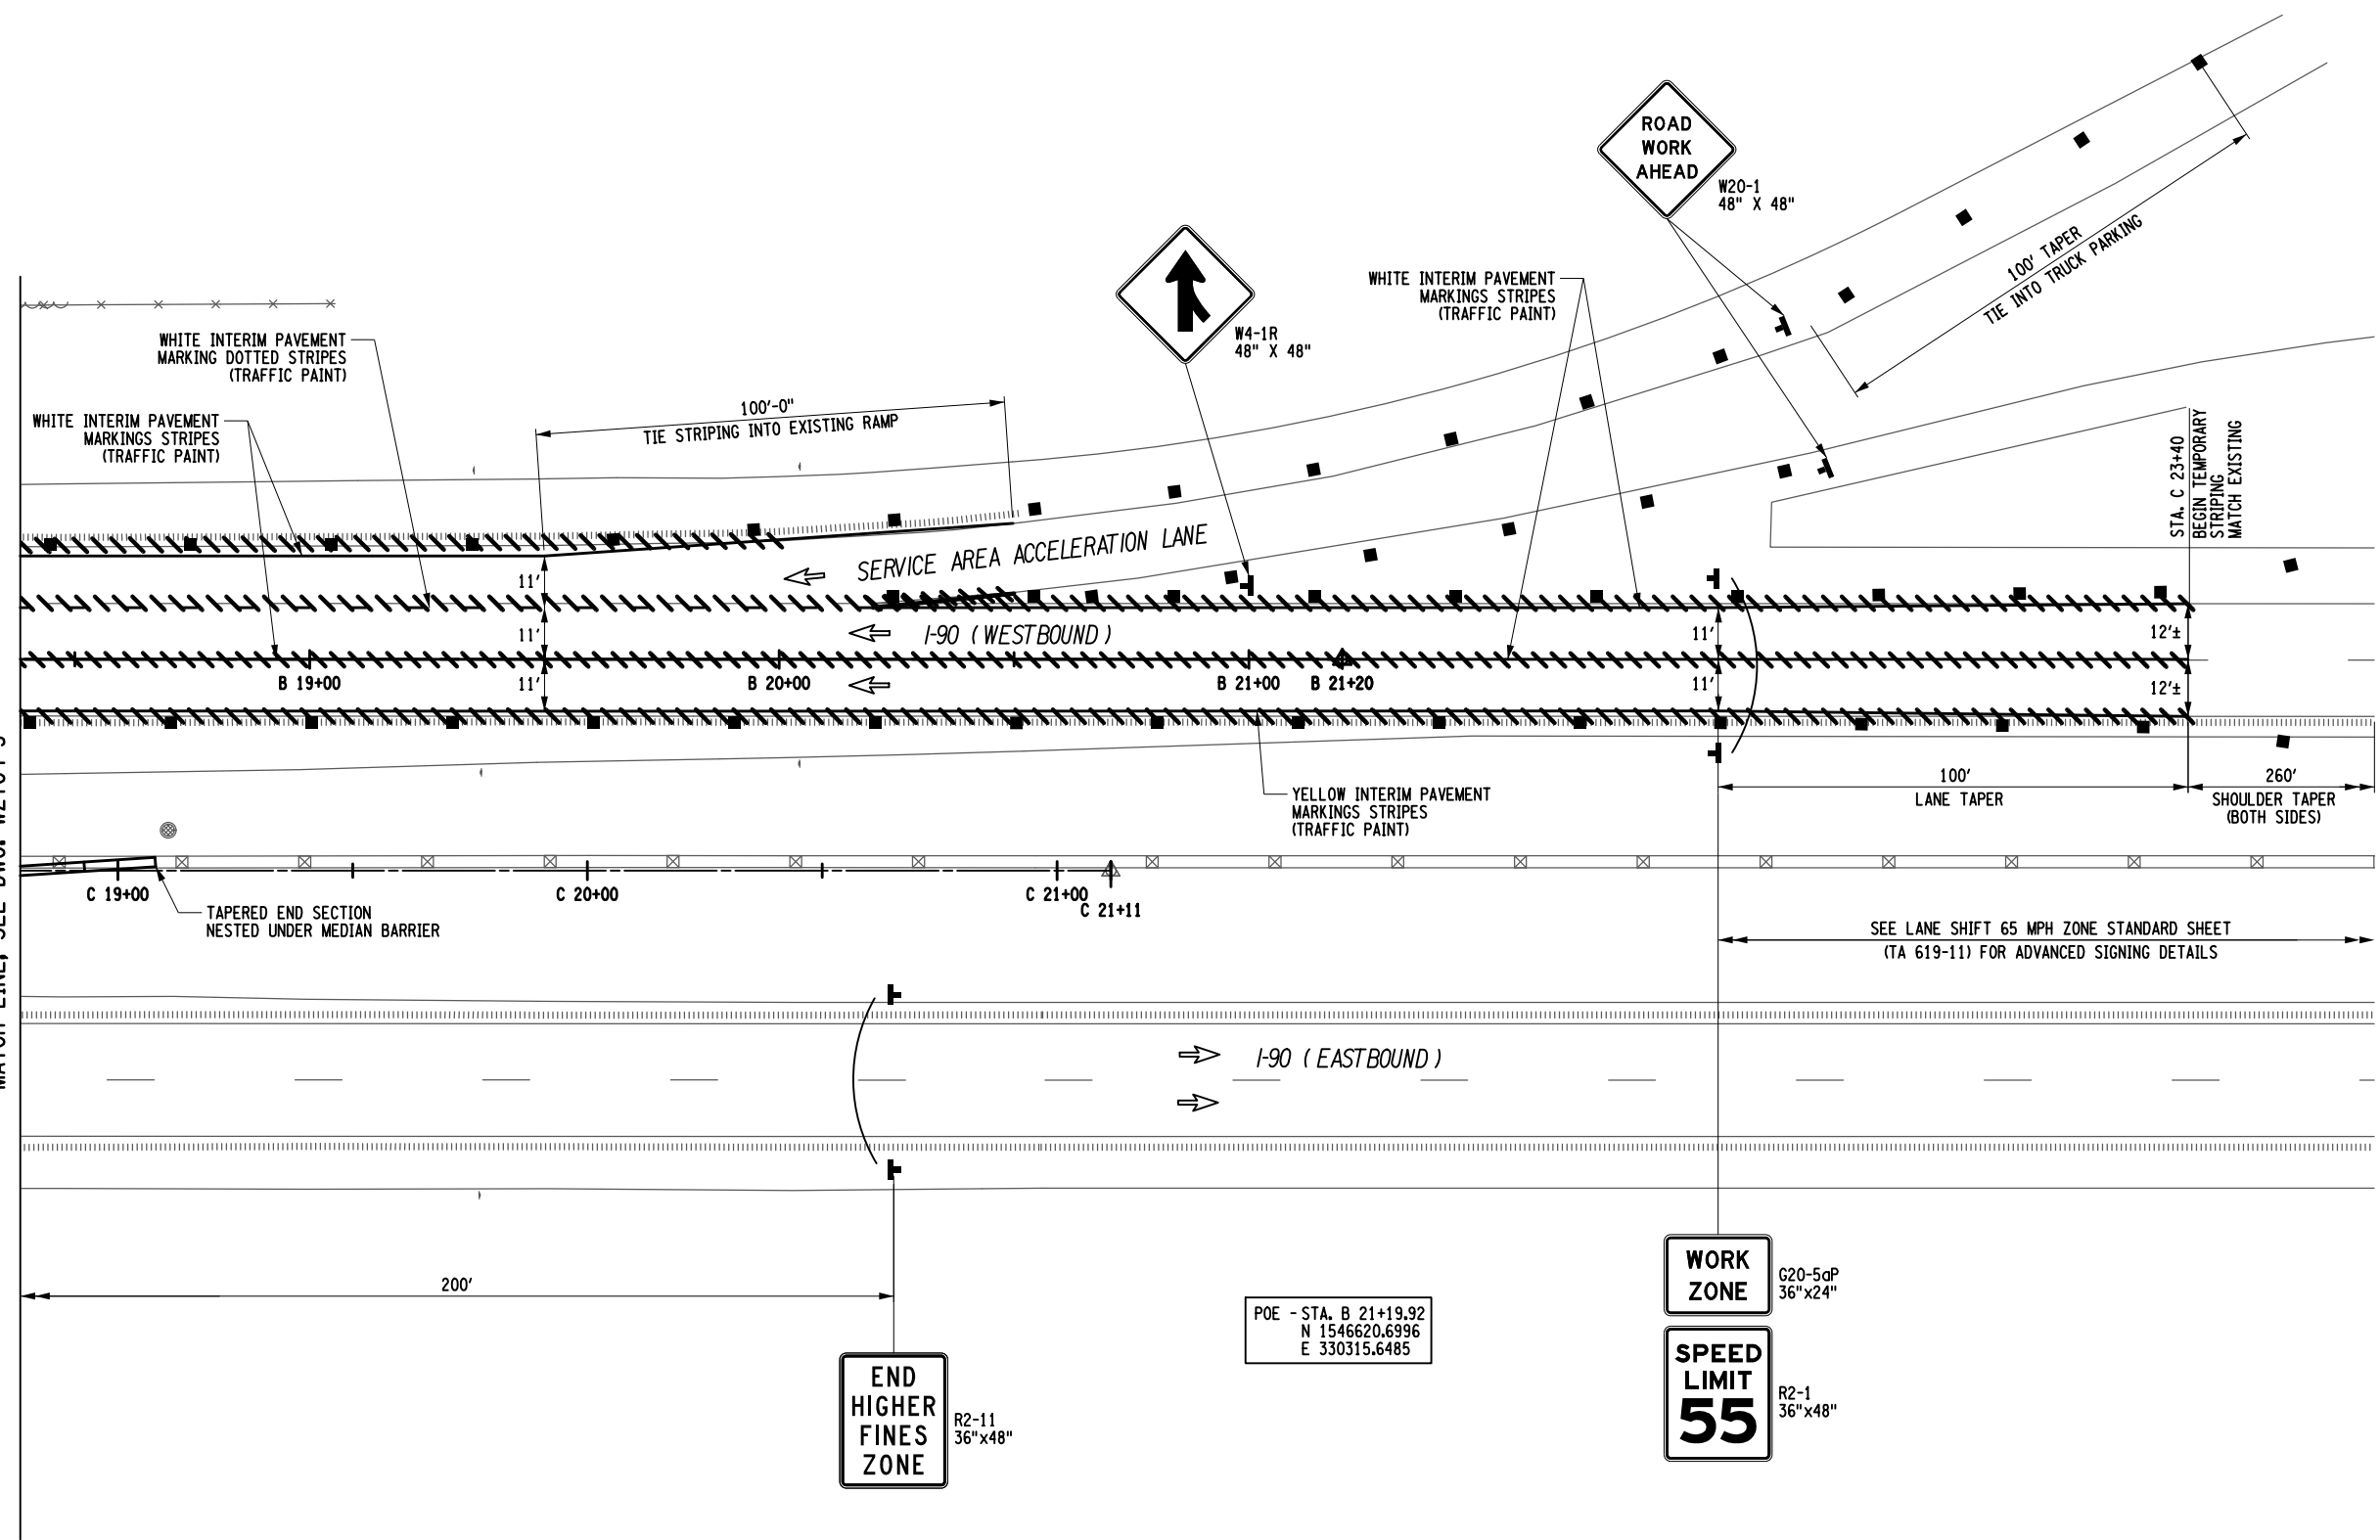

LEGEND

- SOLID 6" INTERIM PAVEMENT MARKING STRIPES (TRAFFIC PAINT), ITEM 619.10010125
- DOTTED 6" INTERIM PAVEMENT MARKING DOTTED STRIPES (TRAFFIC PAINT), ITEM 619.10010125
- CONSTRUCTION DRUM @ 40.0' O.C. (MAX.), ITEM 619.01
- TEMPORARY SIGN, ITEM 619.01
- DIRECTION OF TRAFFIC
- PHASE 4 WORK SPACE
- PAVED MEDIAN CONSTRUCTION (COMPLETED UNDER PHASE 1)
- REMOVE PAVEMENT MARKING STRIPES, ITEM 619.08010125 (6" TRAFFIC PAINT) ITEM 619.08010225 (6" EPOXY PAINT)
- TEMPORARY POSITIVE BARRIER

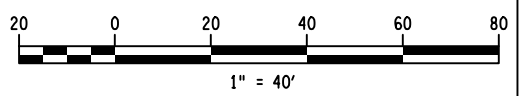

ALTERED ON: SIGNATURE: STAMP:	AFFIXED ON: 11/08/2023 SIGNATURE: STAMP:

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REVISIONS			
DATE	DESCRIPTION	BY	SYM.

Thruway Authority

Ravi Engineering & Land Surveying, P.C.

TITLE OF PROJECT STERLING CREEK BRIDGE REHABILITATION	CONTRACT NUMBER: TAS 24-5B
LOCATION OF PROJECT SYRACUSE DIVISION BIN 5516091 & 5516092 MP 227.40 & MP 227.41	DATE: Nov. 2023
TITLE OF DRAWING WORK ZONE TRAFFIC CONTROL PLAN-MAINLINE PHASE 4	DRAWING NUMBER: WZTC4-6




CHECKED BY: JMC

DRAFTED BY: GM

CHECKED BY: JMC

DESIGNED BY: GM

DESIGN SUPERVISOR: JMC

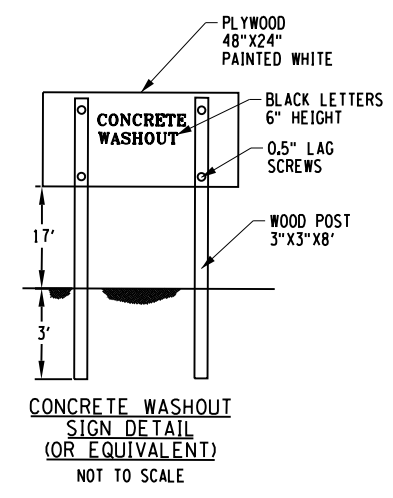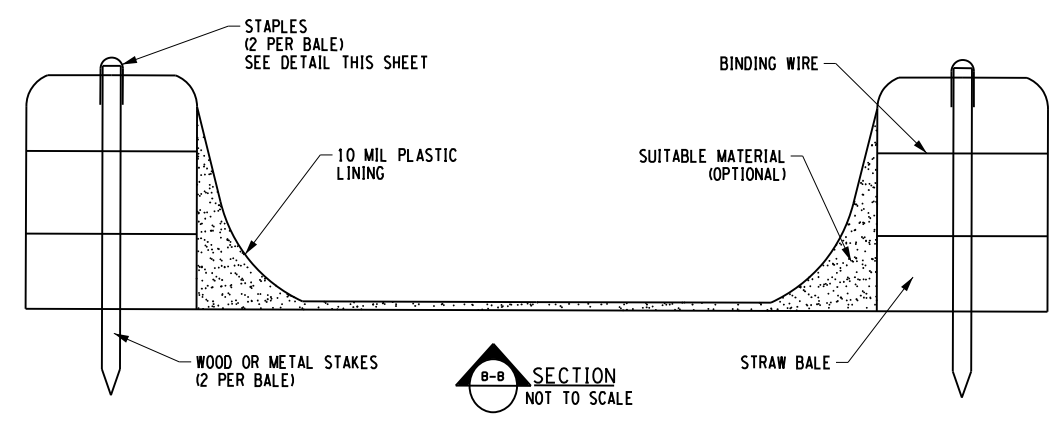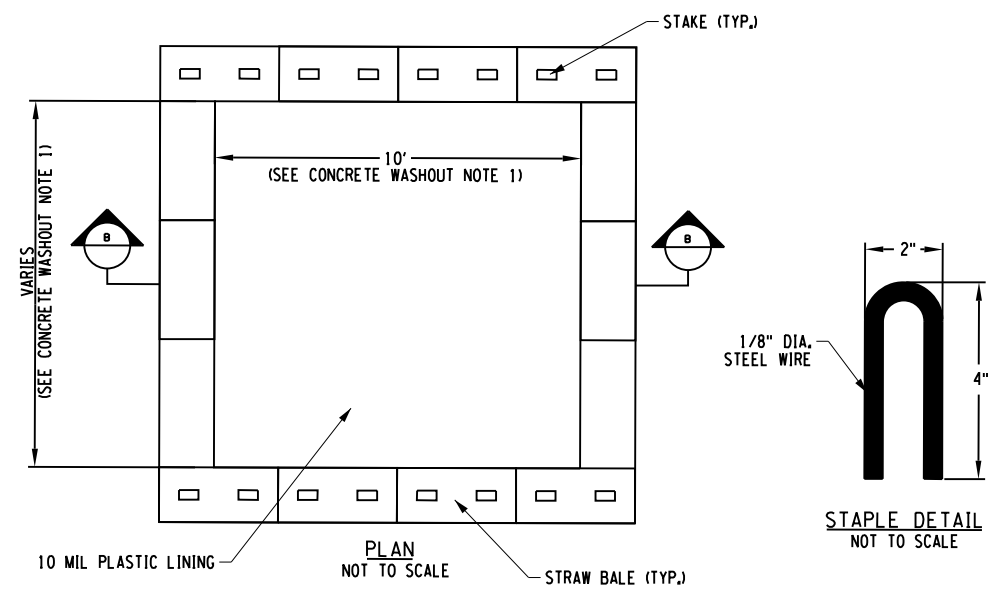


EROSION AND SEDIMENT CONTROL NOTES:

1. INSTALL SILT FENCING AS SHOWN ON THE PLANS AND AROUND THE PERIMETER OF ANY STOCKPILE AREAS AND ADD ADDITIONAL EROSION CONTROL MEASURES AS REQUIRED BY THE ENGINEER PRIOR TO PERFORMING ANY EARTH DISTURBANCE.
2. WHERE WORK IS SUSPENDED ON THE PROJECT, ALL AREAS OF SOIL DISTURBANCE SHALL BE STABILIZED PER ITEM 209.1003, TEMPORARY SEED AND MULCH, PRIOR TO SHUT DOWN.
3. ALL STOCKPILES SHALL BE ENCIrcLED WITH SILT FENCE AND COVERED WITH A TARP OR SEEDED AND MULCHED WITHIN 24 HRS OF CREATION. COST OF WORK SHALL BE INCLUDED IN VARIOUS ITEMS IN THE CONTRACT.
4. CONTRACTOR SHALL CLEAN SEDIMENT AND DEBRIS OFF ALL PAVED SURFACES AT THE END OF EACH DAY OR AS DIRECTED BY ENGINEER. COST OF CLEANING SHALL BE INCLUDED IN VARIOUS ITEMS IN THE CONTRACT.
5. CONTRACTOR SHALL NOT WASH CONCRETE OR SLURRY TRUCKS, TOOLS, OR EQUIPMENT OUT ONTO BARE GROUND OR DIRECTLY INTO STORM OR SANITARY SEWER SYSTEMS (INCLUDING SWALES, DITCHES AND WETLANDS). EXCESS CONCRETE, SLURRY AND WASH WATER SHALL BE COLLECTED IN A WASH BASIN AND DISPOSED OF PROPERLY.
6. THE CONTRACTOR SHALL SUBMIT FOR APPROVAL TO THE ENGINEER THEIR WRITTEN SCHEDULE AND PROPOSED MEASURES FOR TEMPORARY AND PERMANENT EROSION AND SEDIMENT CONTROL WORK AND SCHEDULE OF OPERATIONS AS REQUIRED BY SECTION 209 OF THE NYSOT STANDARD SPECIFICATIONS.
7. INSPECTION, PERIODIC CLEANING AND MAINTENANCE OF TEMPORARY SOIL EROSION AND POLLUTION CONTROL DEVICES SHALL BE PERFORMED ON A SCHEDULE BASIS IN ACCORDANCE WITH SECTION 209 OF THE NYSOT STANDARD SPECIFICATIONS. THE COST OF INSTALLING, CLEANING AND REMOVING TEMPORARY SOIL EROSION AND WATER POLLUTION CONTROL DEVICES SHALL BE PAID FOR UNDER THE ITEMS SHOWN.
8. ALL NECESSARY PRECAUTIONS SHALL BE TAKEN TO PREVENT CONTAMINATION OF ANY STREAM OR WATERWAY BY SILT, SEDIMENT, FUELS, SOLVENTS, LUBRICANTS, EPOXY COATINGS, CONCRETE OR SLURRY LEACHATE OR ANY OTHER POLLUTANT ASSOCIATED WITH CONSTRUCTION AND CONSTRUCTION PROCEDURES.
9. IF DEWATERING IS REQUIRED THE COST SHALL BE INCLUDED IN PRICE BID FOR THE ITEM REQUIRING THE DEWATERING. THE CONTRACTOR SHALL OBTAIN THE REQUIRED PERMITS FROM THE NEW YORK STATE DEPARTMENT OF ENVIRONMENTAL CONSERVATION IF THEY ELECT TO USE WELL POINTS. ALL WATER FROM DEWATERING OPERATIONS OR EXCAVATION ACTIVITIES SHALL PASS THROUGH A SETTLING TANK, ITEM 209.3100010, OR A GEOTEXTILE FABRIC SEDIMENT COLLECTION BAG ITEM 209.1100001 PRIOR TO BEING DISCHARGED TO A CANAL, CREEK, STREAM, OR CLOSED DRAINAGE SYSTEM DITCH.
10. ALL CONTROLS SHALL BE PLACED PRIOR TO STARTING EARTHWORK OPERATIONS AND SHALL REMAIN IN PLACE UNTIL NEW SLOPES ARE STABILIZED WITH SEEDING AND/OR SLOPE PROTECTION.
11. CONTRACTOR SHALL BE RESPONSIBLE FOR PROVIDING ANY ADDITIONAL EROSION CONTROL MEASURES THAT MAY BE REQUIRED OR AS ORDERED BY ENGINEER.
12. CONTRACTOR STAGING AREAS SHALL BE EXISTING AREAS OF NON DISTURBABLE COVER, (I.E. ASPHALT MILLING, ASPHALT OR CONCRETE PAVEMENT). IF THE CONTRACTOR CREATES A STAGING AREA ON DISTURBABLE COVER (I.E. GRASS) THEN THE ENTIRE AREA SHALL BE ENCLOSED WITH SILT FENCE.
13. CONTRACTOR SHALL ESTABLISH A STABILIZED CONSTRUCTION ENTRANCE INTO AND OUT OF EACH WORK AREA AND EACH STAGING AREA CONSTRUCTED ON DISTURBABLE COVER.
14. PROJECT DISTURBANCE IS ANTICIPATED TO BE LESS THAN ONE (1) ACRE. THE CONTRACTOR WILL BE RESPONSIBLE FOR DEVELOPING A STORMWATER POLLUTION PREVENTION PLAN (SWPPP) AND NOTICE OF INTENT (NOI) IF THE DISTURBANCE GOES OVER ONE (1) ACRE.
15. CONTRACTOR SHALL DECOMPACT ALL AREAS OF PAVEMENT OR IMPERVIOUS COVER REMOVAL THAT WILL BE MADE PERVIOUS COVER. DECOMPACTION SHALL BE ACCOMPLISHED BY DEEP RIPPING OR TILLING TO A DEPTH OF 1.5 FEET BELOW THE BOTTOM OF THE EXISTING SUBBASE LAYER IN ORDER TO REESTABLISH THE PERMEABILITY OF THE SOIL. THE COST OF DECOMPACTION SHALL BE INCLUDED IN THE COST OF PAVEMENT REMOVAL.

CONCRETE WASHOUT NOTES:

1. ACTUAL LAYOUT AND LOCATION TO BE DETERMINED IN FIELD.
2. THE CONCRETE WASHOUT SIGN SHALL BE INSTALLED WITHIN 5 FEET OF THE TEMPORARY CONCRETE WASHOUT FACILITY.
3. LOCATE WASHOUT AREA AT LEAST 50-FEET FROM STORM DRAINS, OPEN DITCHES, OR WATER BODIES. DO NOT ALLOW RUNOFF FROM THIS AREA BY CONSTRUCTING A TEMPORARY PIT OR BERMED AREA LARGE ENOUGH FOR LIQUID OR SOLID WASTE.
4. WASH OUT WASTES INTO THE TEMPORARY PIT WHERE THE CONCRETE CAN SET, BE BROKEN UP, AND THEN DISPOSED OF PROPERLY. TEMPORARY CONCRETE WASHOUT FACILITIES SHALL BE MAINTAINED TO PROVIDE ADEQUATE HOLDING CAPACITY WITH A MINIMUM FREEBOARD OF 4-INCHES.
5. TEMPORARY CONCRETE WASHOUT FACILITY (TYPE ABOVE GRADE) SHALL BE CONSTRUCTED AS SHOWN ON THE DETAILS WITH A RECOMMENDED MINIMUM LENGTH AND MINIMUM WIDTH OF 10-FEET, BUT WITH SUFFICIENT QUANTITY AND VOLUME TO CONTAIN ALL LIQUID AND CONCRETE WASTE GENERATED BY WASHOUT OPERATIONS.
6. STRAW BALES, WOOD STAKES, AND SANDBAG MATERIALS SHALL CONFORM TO THE PROVISIONS IN THE EROSION AND SEDIMENT CONTROL SPECIFICATION.
7. PLASTIC LINING MATERIAL SHALL BE A MINIMUM OF 10 MIL IN POLYETHYLENE SHEETING AND SHALL BE FREE OF HOLES, TEARS, OR OTHER DEFECTS THAT COMPROMISE THE IMPERMEABILITY OF THE MATERIAL.
8. HOLES, DEPRESSIONS, OR OTHER GROUND DISTURBANCE CAUSED BY THE REMOVAL OF THE TEMPORARY CONCRETE WASHOUT FACILITIES SHOULD BE BACKFILLED AND REPAIRED.
9. WASHOUT FACILITIES SHALL BE CLEANED, OR NEW FACILITIES SHALL BE CONSTRUCTED AND READY FOR USE ONCE THE WASHOUT IS 75% FULL.
10. THE COST FOR THE CONCRETE WASHOUTS SHALL BE INCLUDED IN THE PRICE BID FOR ALL CONCRETE ITEMS.

CONCRETE WASHOUT DETAIL
NOT TO SCALE

ALTERED ON:	AFFIXED ON: 11/08/23
SIGNATURE: STAMP:	SIGNATURE: JAMES M. CUMMINGS, PE STAMP: 

IT IS A VIOLATION OF LAW FOR ANY PERSON, UNLESS THEY ARE ACTING UNDER THE DIRECTION OF A LICENSED PROFESSIONAL ENGINEER, ARCHITECT, LANDSCAPE ARCHITECT, OR LAND SURVEYOR, TO ALTER AN ITEM IN ANY WAY. IF AN ITEM BEARING THE STAMP OF A LICENSED PROFESSIONAL IS ALTERED, THE ALTERING ENGINEER, ARCHITECT, LANDSCAPE ARCHITECT, OR LAND SURVEYOR SHALL STAMP THE DOCUMENT AND INCLUDE THE NOTATION "ALTERED BY" FOLLOWED BY THEIR SIGNATURE, THE DATE OF SUCH ALTERATION, AND A SPECIFIC DESCRIPTION OF THE ALTERATION.

REVISIONS			
DATE	DESCRIPTION	BY	SYM.

NEW YORK STATE OF OPPORTUNITY

Thruway Authority

HUNT ENGINEERS | ARCHITECTS | SURVEYORS

HORSEHEADS, NY 607-358-1000 ROCHESTER, NY 585-327-7950
TOWANDA, PA 517-265-4868 BINGHAMTON, NY 607-736-8081
ALBANY, NY 607-736-8991 WWW.HUNT-ENG.COM
NY CERTIFICATE NO. 0018220 PA CERTIFICATE NO. TSC22031464-1

TITLE OF PROJECT STERLING CREEK BRIDGE REHABILITATION	CONTRACT NUMBER: TAS 24-5B
LOCATION OF PROJECT SYRACUSE DIVISION BIN 5516091 & 5516092 MP 227.40 & 227.41	DATE: NOV. 2023
TITLE OF DRAWING EROSION AND SEDIMENT CONTROL DETAILS	DRAWING NUMBER: ECD-1


CHECKED BY: JMC

DRAFTED BY: GM

CHECKED BY: JMC

DESIGNED BY: GM

DESIGN SUPERVISOR: JMC

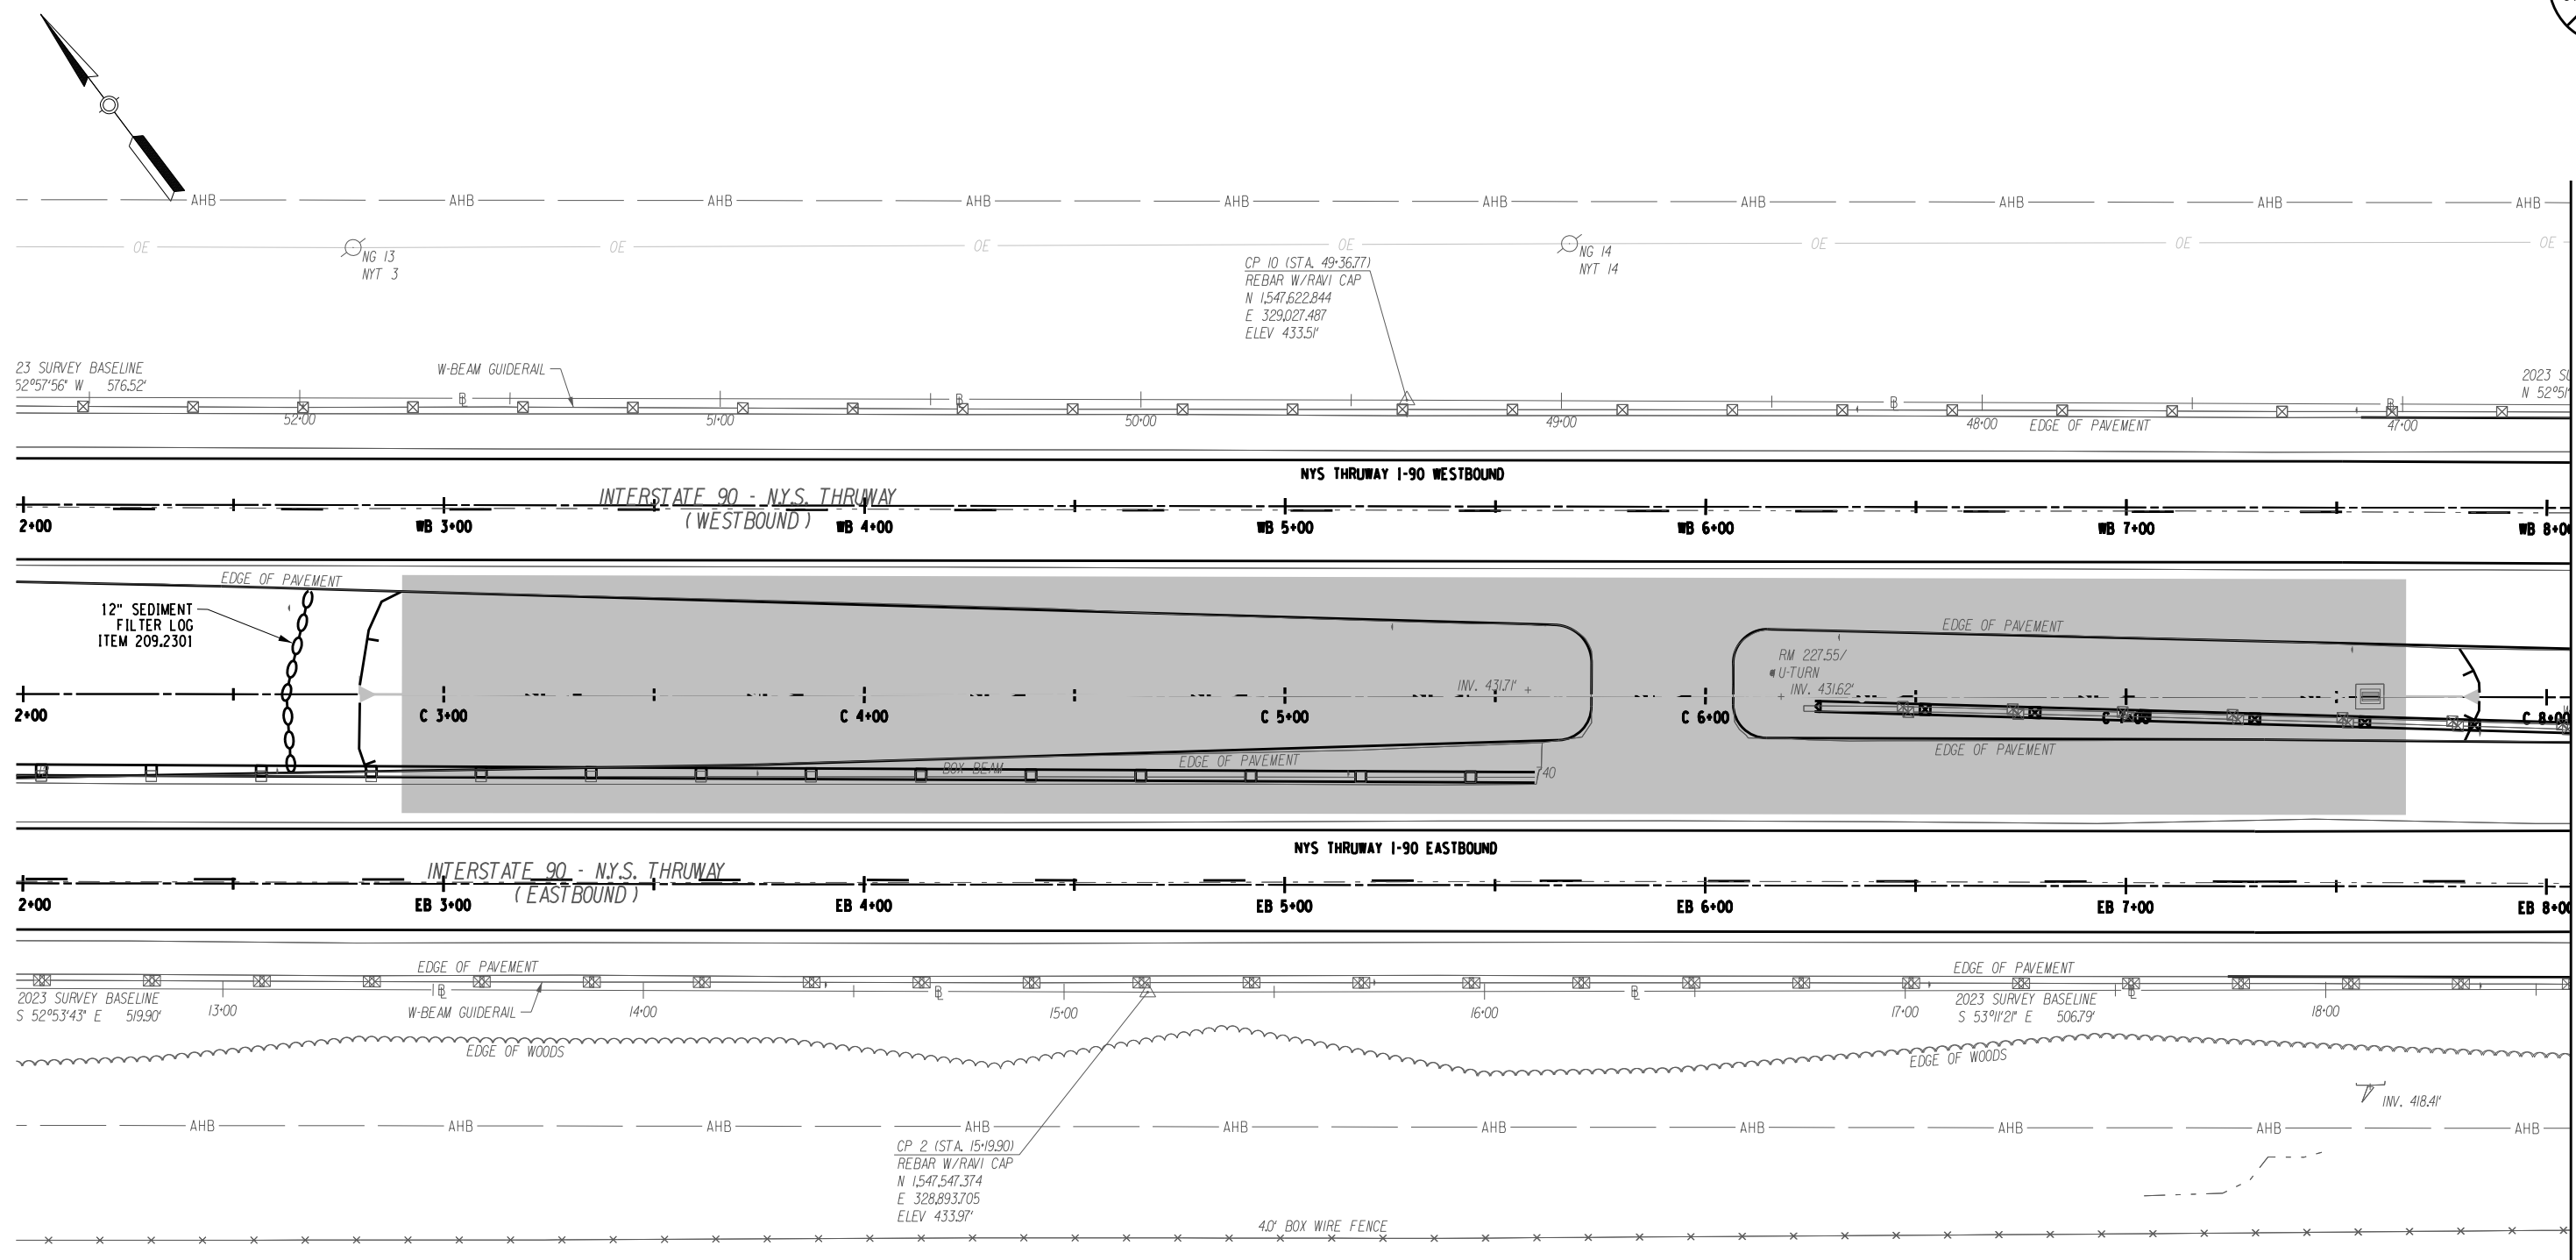

MATCHLINE - SEE DWG. NO. ECP-2

ALTERED ON:
SIGNATURE:
STAMP:

AFFIXED ON: 11/08/23
SIGNATURE: JAMES M. CUMMINGS, PE
STAMP:

LEGEND

- TEMPORARY WORK ZONE PAVING
- SEDIMENT FILTER LOG ITEM 209.2301
- TEMPORARY WATERWAY DIVERSION STRUCTURE

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REVISIONS			
DATE	DESCRIPTION	BY	SYM.


NEW YORK STATE OF OPPORTUNITY

Thruway Authority

HUNT ENGINEERS | ARCHITECTS | SURVEYORS
HORSEHEADS, NY 607-358-1000 ROCHESTER, NY 585-327-7950
 TOWANDA, PA 517-295-8888 BINGHAMTON, NY 607-736-8081
 ALBANY, NY 607-738-5991 WWW.HUNT-ENG.COM
 NY CERTIFICATE NO. 0018220 PA CERTIFICATE NO. TSC220313464-1

TITLE OF PROJECT: STERLING CREEK BRIDGE REHABILITATION
 LOCATION OF PROJECT: SYRACUSE DIVISION
 BIN 5516091 & 5516092 MP 227.40 & 227.41
 TITLE OF DRAWING: EROSION AND SEDIMENT CONTROL PLAN

CONTRACT NUMBER: TAS 24-5B
 DATE: NOV. 2023
 DRAWING NUMBER: ECP-1

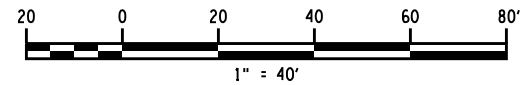


CHECKED BY: JMC

DRAFTED BY: GM

CHECKED BY: JMC

DESIGNED BY: GM

DESIGN SUPERVISOR: JMC

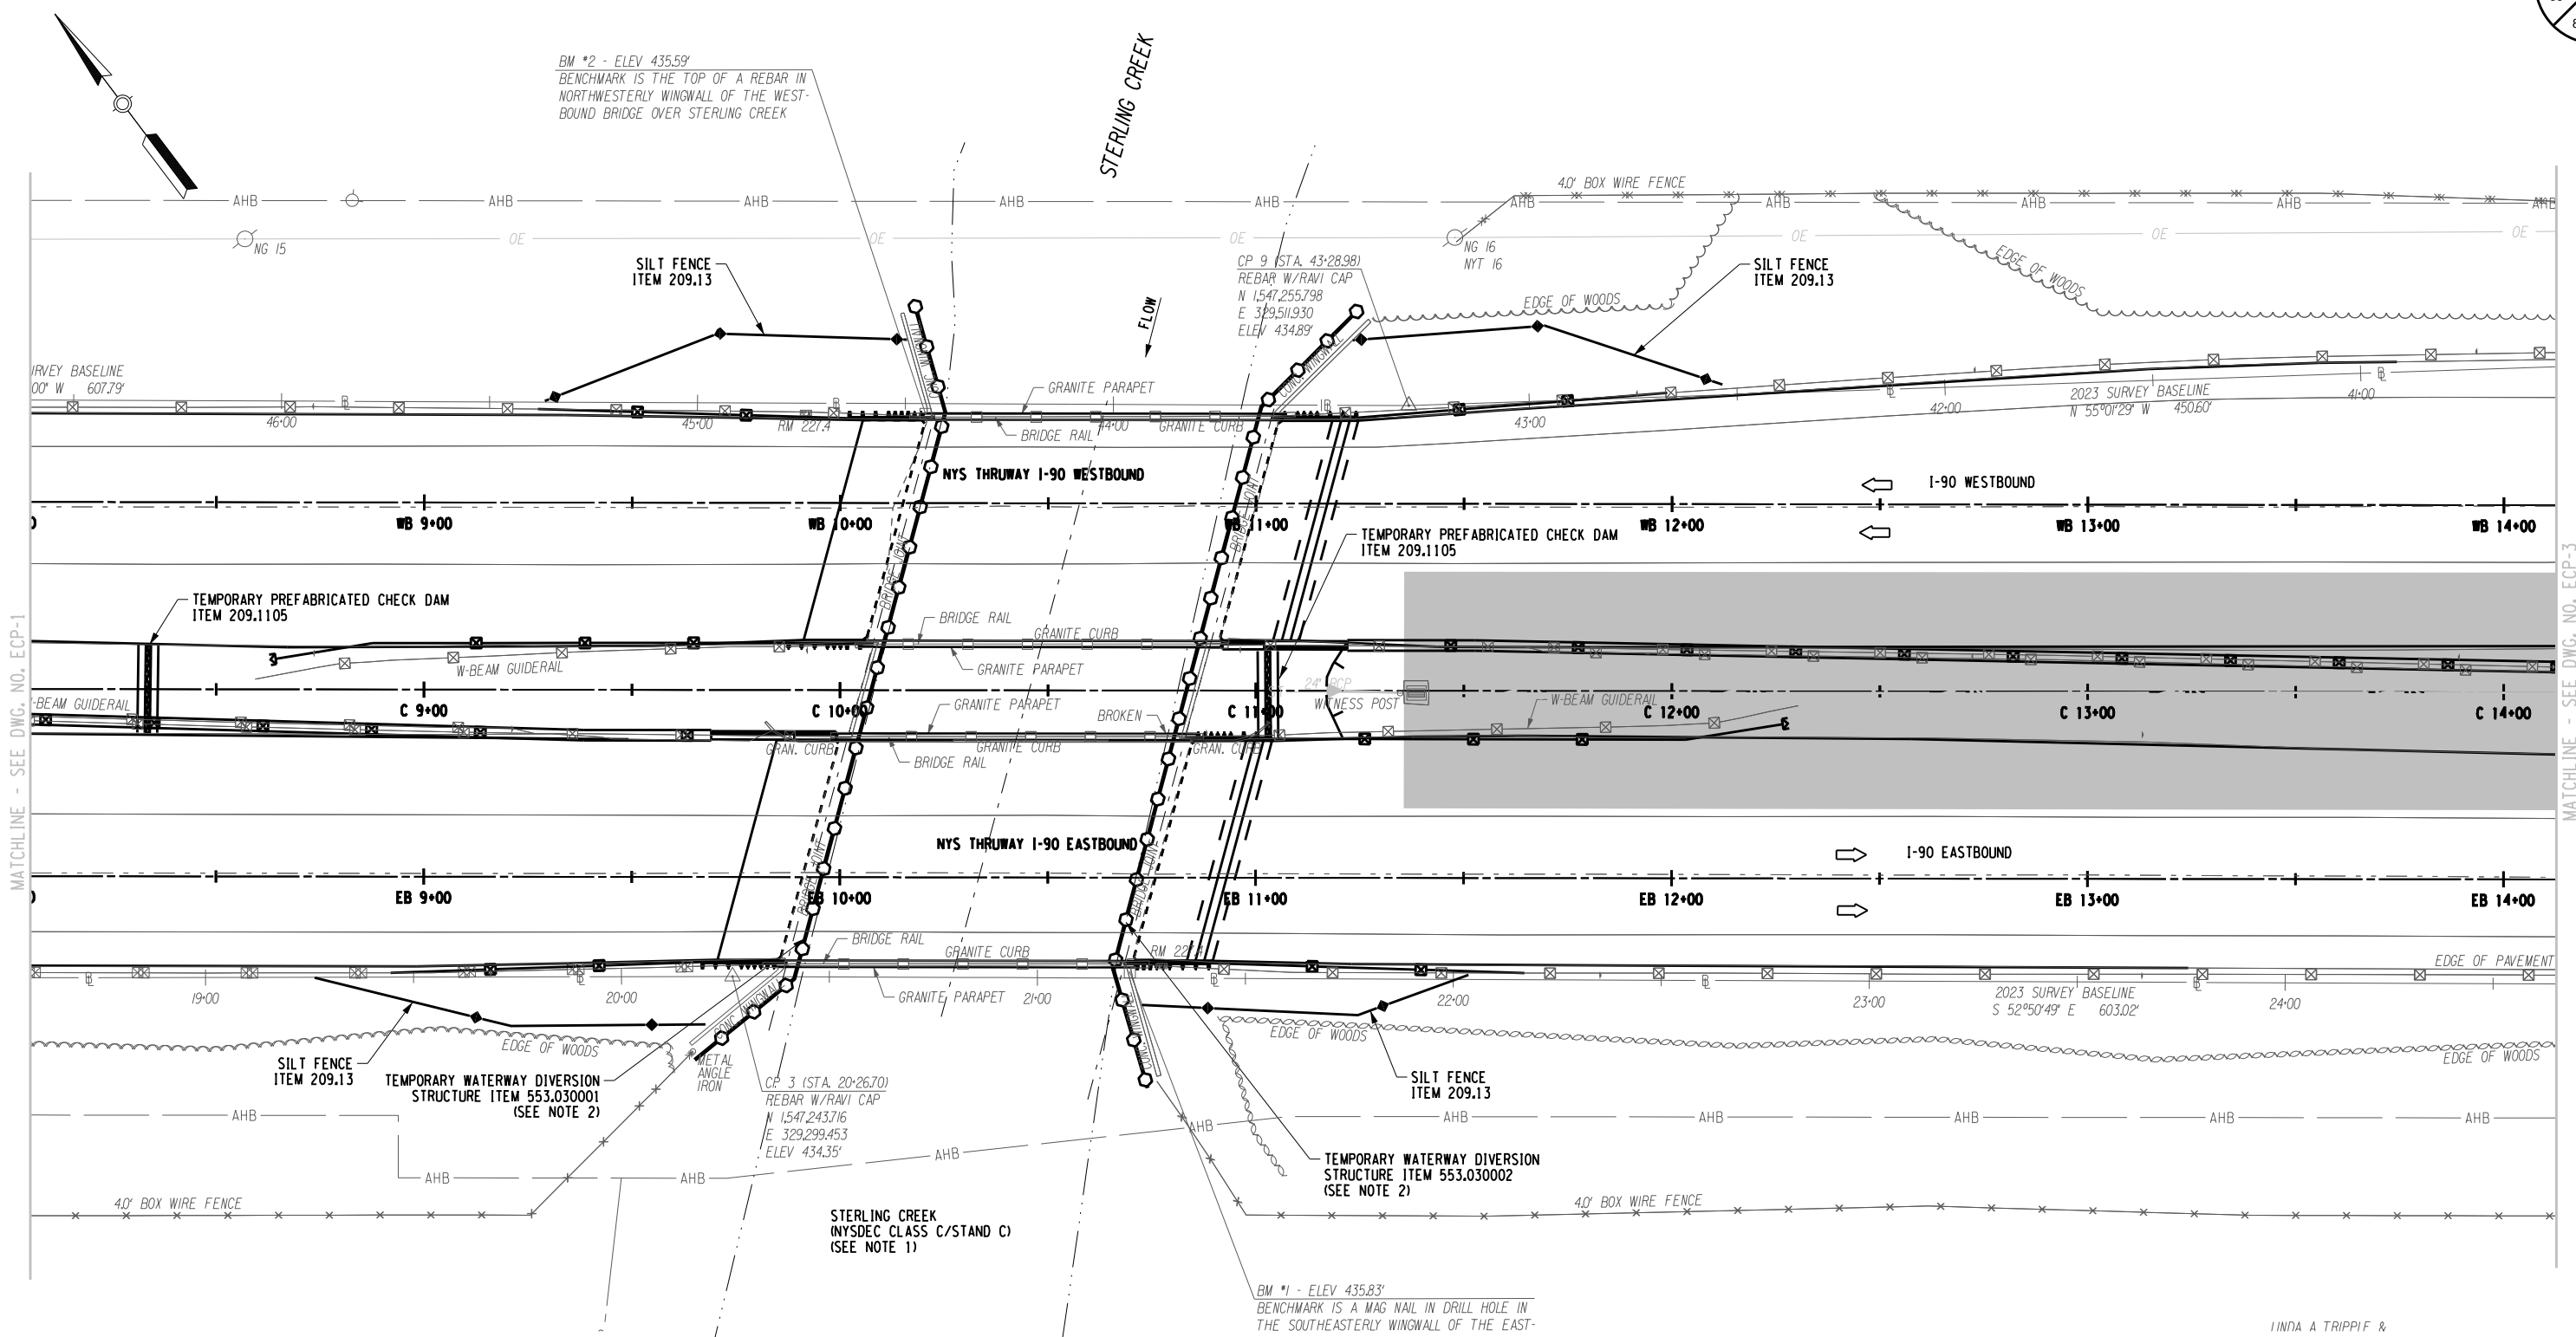

ALTERED ON:

SIGNATURE:
STAMP:

AFFIXED ON: 11/08/23

SIGNATURE: JAMES M. CUMMINGS, PE
STAMP:

LEGEND

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NOTES:

- ALL IN-STREAM ACTIVITIES SHALL COMPLY WITH USACE NATIONWIDE PERMIT #3 - MAINTENANCE
- PLACE DIVERSION STRUCTURE SO THERE IS 3' OF WORK SPACE BETWEEN DIVERSION STRUCTURE AND ABUTMENT WALL. PROVIDE PUMPING TO DEWATER BEHIND THE DIVERSION STRUCTURE AS NECESSARY. PASS ALL DEWATERING DISCHARGE THROUGH A SETTLING DEVICE BEFORE DISCHARGE TO THE STREAM. COST OF ALL DEWATERING AND DISCHARGE SETTING SHALL BE INCLUDED IN PRICE BID FOR DIVERSION STRUCTURE ITEM.

REVISIONS			
DATE	DESCRIPTION	BY	SYM.

NEW YORK STATE OF OPPORTUNITY

HUNT ENGINEERS | ARCHITECTS | SURVEYORS

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ALBANY, NY 607-738-5991 WWW.HUNT-ENG.COM
NY CERTIFICATE NO. 0018220 PA CERTIFICATE NO. TSC220313464-1

Thruway Authority

TITLE OF PROJECT
STERLING CREEK BRIDGE REHABILITATION

LOCATION OF PROJECT
SYRACUSE DIVISION
BIN 5516091 & 5516092 MP 227.40 & 227.41

TITLE OF DRAWING
EROSION AND SEDIMENT CONTROL PLAN

CONTRACT NUMBER:
TAS 24-5B

DATE:
NOV. 2023

DRAWING NUMBER:
ECP-2

1" = 40'

MATCHLINE - SEE DWG. NO. ECP-3

IINDA A TRIPPIFF &


CHECKED BY: JMC

DRAFTED BY: GM

CHECKED BY: JMC

DESIGNED BY: GM

DESIGN SUPERVISOR: JMC

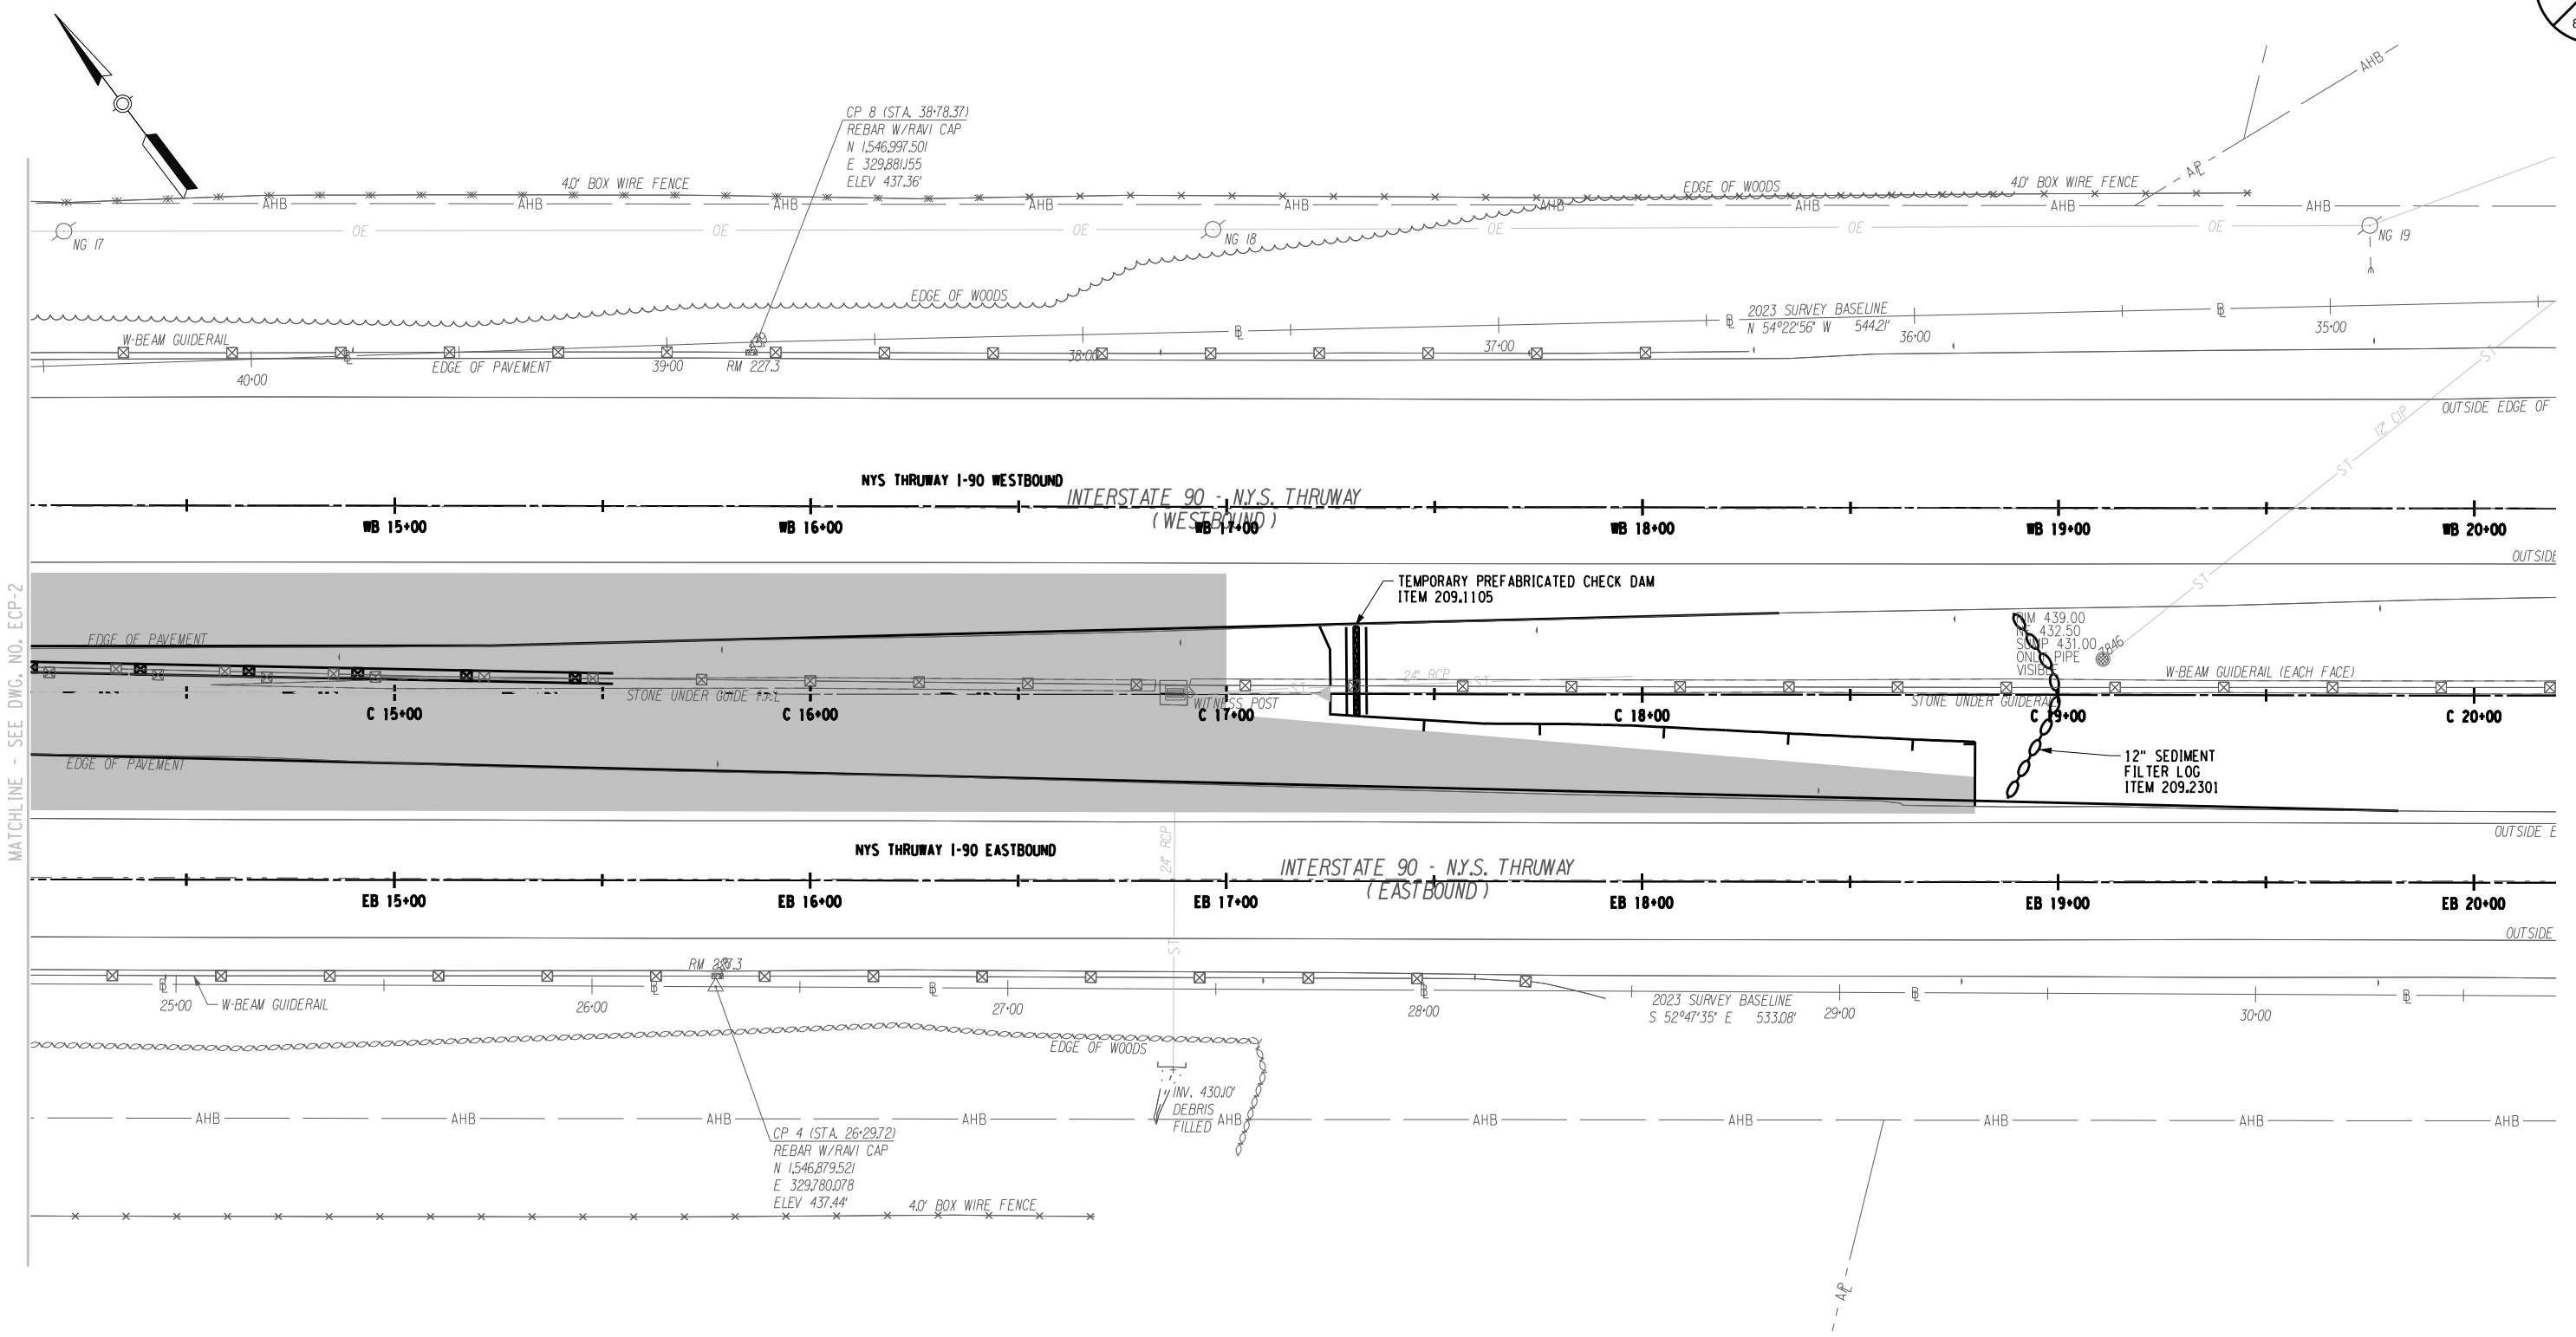

ALTERED ON:
SIGNATURE:
STAMP:

AFFIXED ON: 11/08/23
SIGNATURE: JAMES M. CUMMINGS, PE
STAMP:

LEGEND

- TEMPORARY WORK ZONE PAVING
- SEDIMENT FILTER LOG ITEM 209.2301
- TEMPORARY WATERWAY DIVERSION STRUCTURE

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REVISIONS			
DATE	DESCRIPTION	BY	SYM.


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 TOWANDA, PA 517-205-4888 BINGHAMTON, NY 607-736-8081
 ALBANY, NY 607-738-5931 WWW.HUNT-ENG.COM
 NY CERTIFICATE NO. 0018220 PA CERTIFICATE NO. TSC2203131464-1





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 LOCATION OF PROJECT: SYRACUSE DIVISION BIN 5516091 & 5516092 MP 227.40 & 227.41
 TITLE OF DRAWING: EROSION AND SEDIMENT CONTROL PLAN

CONTRACT NUMBER: TAS 24-5B
 DATE: NOV. 2023
 DRAWING NUMBER: ECP-3



CHECKED BY: N. BARNHARD
 DRAFTED BY: T. LINDO
 CHECKED BY: N. BARNHARD
 DESIGNED BY: C. SICHAK
 DESIGN SUPERVISOR: C. SICHAK



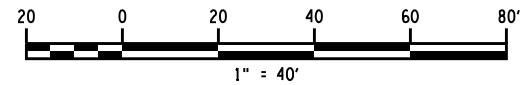
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ALTERED ON:		AFFIXED ON: 12/04/2023							
SIGNATURE: STAMP:		SIGNATURE: STAMP:							
		ITEM	DESCRIPTION	UNIT	ITEM	DESCRIPTION	UNIT	NOTES:	
		203.02	UNCLASSIFIED EXCAVATION AND DISPOSAL	CY	606.2701	HPBO (MOD.) CORRUGATED BEAM GUIDE RAILING	LF	1. ASPHALT JOINT ADHESIVE, ITEM 418.7603, SHALL BE USED ON VERTICAL FACES FOR ALL THE JOINTS ON THE SURFACE COURSE SUCH AS LONGITUDINAL, TRANSVERSE, OR OTHER JOINTS ABUTTING THE NEW ASPHALT PAVEMENT. 2. SEE GUIDE RAIL TABLE ON DWG. MT-1 FOR LOCATION OF WORK. 3. SEE NYS DOT STANDARD SHEET 609-03 FOR CONCRETE CURB TYPE VF150 DETAILS.	
304.12	SUBBASE COURSE, TYPE 2	CY	606.8903	TRANSITION: HPBO (MOD.) CORRUGATED BEAM GUIDE RAILING	EA				
404.097201	9.5 F2 TOP COURSE ASPHALT, 70 SERIES COMPACTION	TON		TO SINGLE SLOPE CONCRETE HALF SECTION BARRIER	TON				
404.197901	19 F9 BINDER COURSE ASPHALT, 70 SERIES COMPACTION	TON	608.020102	ASPHALT SIDEWALKS, DRIVEWAYS AND BICYCLE PATHS, AND VEGETATION CONTROL STRIPS					
404.377901	37.5 F9 BASE COURSE ASPHALT, 70 SERIES COMPACTION	TON		TOPSOIL - ROADSIDE	CY				
407.0103	STRAIGHT TACK COAT	GAL	610.1402	TURF ESTABLISHMENT - ROADSIDE	SY				
418.7603	ASPHALT PAVEMENT JOINT ADHESIVE	LF	610.1601	MILLED-IN AUDIBLE ROADWAY DELINEATORS (MIARDS)	LF				
557.2002	STRUCTURAL APPROACH SLAB WITH INTEGRAL WEARING SURFACE - TYPE 2 FRICTION	SY	649.01						
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		DATE	DESCRIPTION	BY	SYM.			LOCATION OF PROJECT: SYRACUSE DIVISION BIN 5516091 & 5516092, MP 227.40 & MP 227.41 DATE: NOV. 2023	
						TITLE OF DRAWING: PROPOSED SECTIONS DRAWING NUMBER: TYP-1			
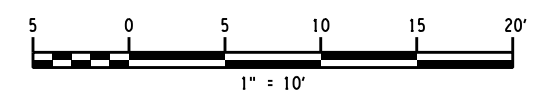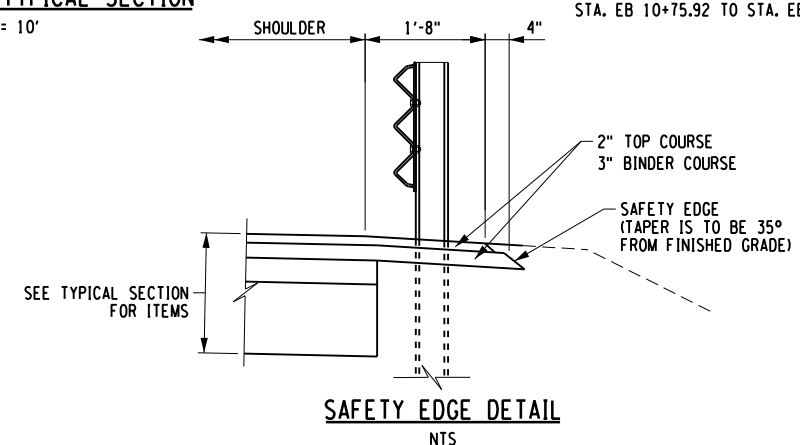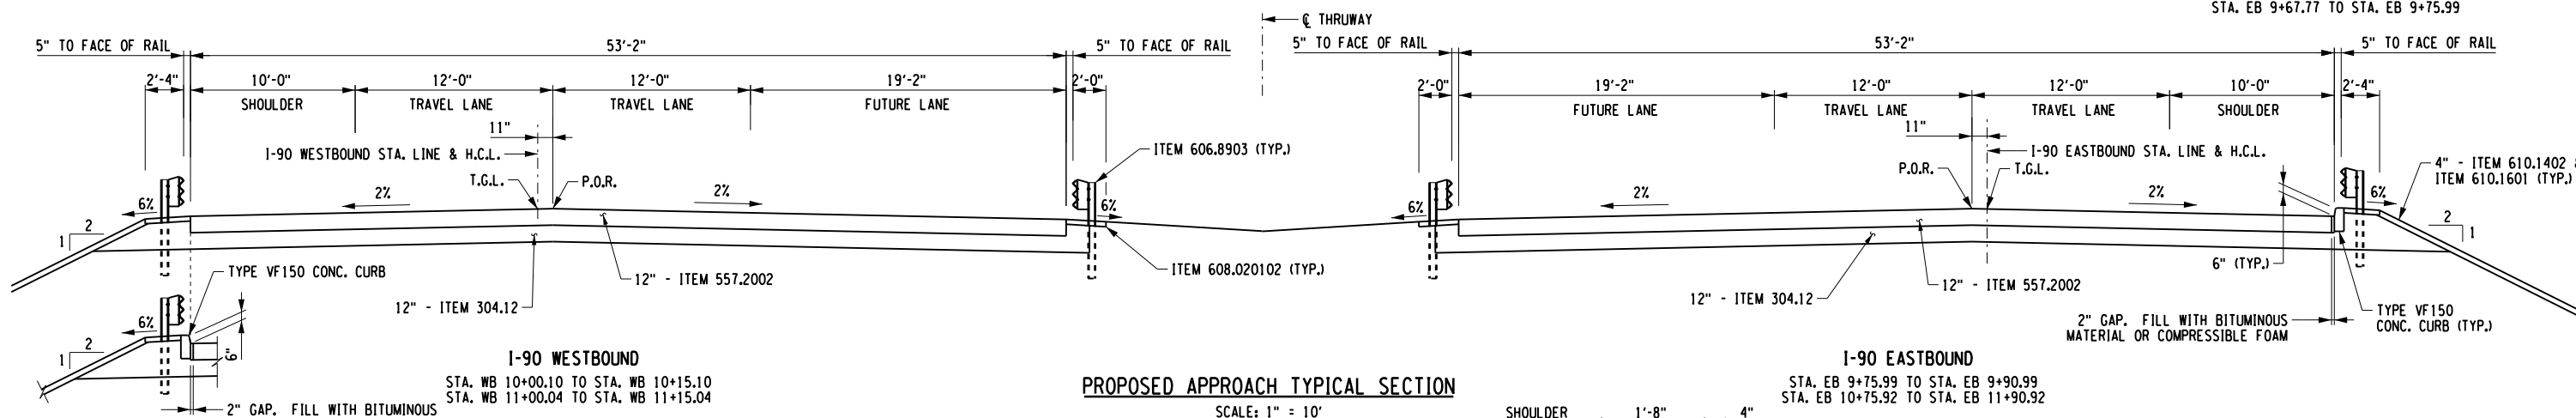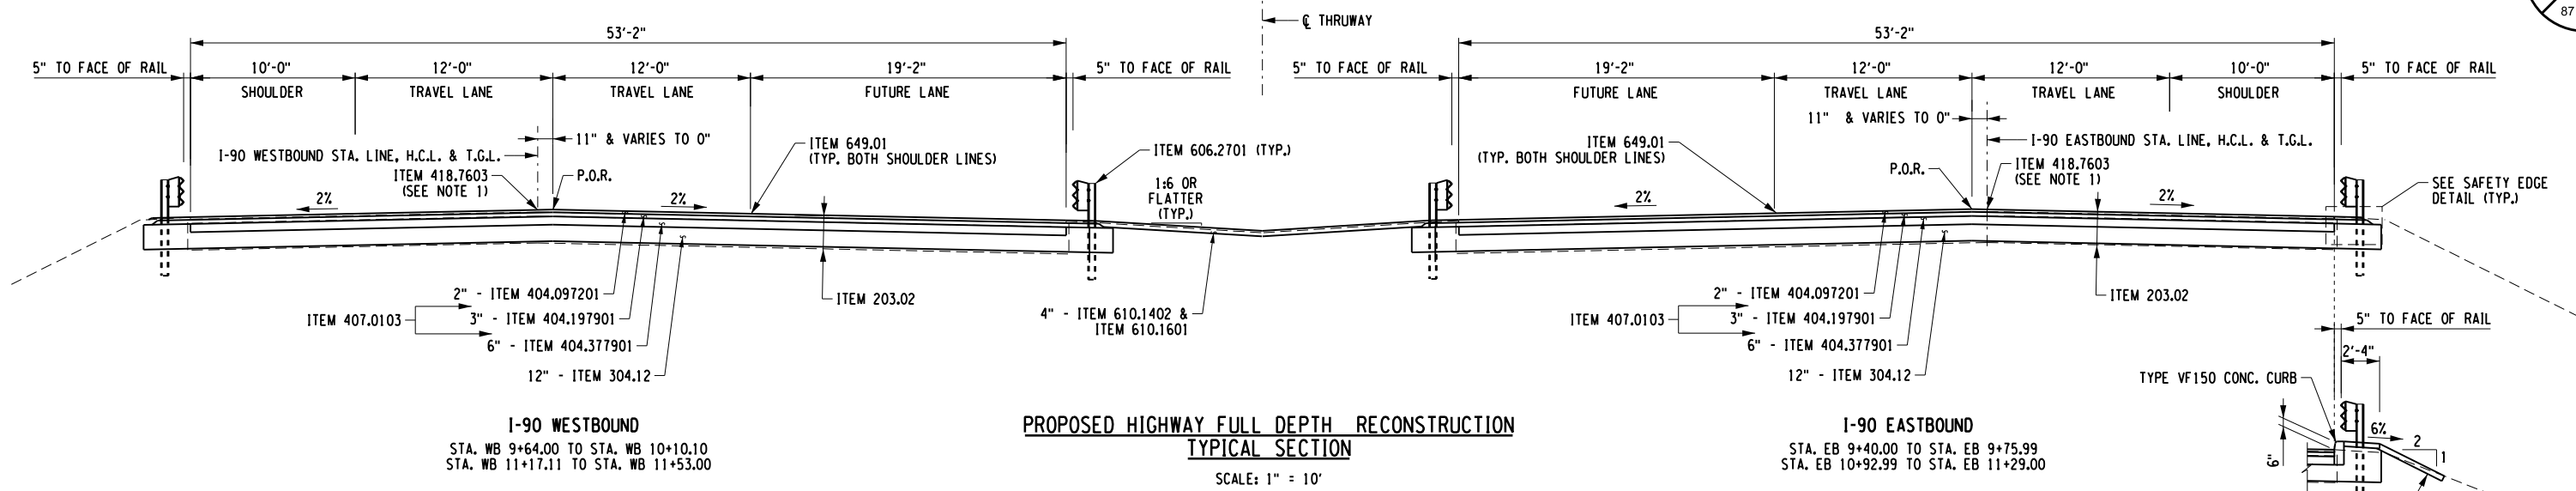
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 DATE/TIME = 12/4/2023 3:19:55 PM
 USER = L.LINDO

DESIGNED BY: C. SICHAK
 CHECKED BY: N. BARNHARD
 DRAFTED BY: T. LINDO
 CHECKED BY: N. BARNHARD



ALTERED ON:	AFFIXED ON:	ITEM	DESCRIPTION	UNIT	ITEM	DESCRIPTION	UNIT	NOTES:	
	12/04/2023	203.02	UNCLASSIFIED EXCAVATION AND DISPOSAL	CY	606.2701	HPBO (MOD.) CORRUGATED BEAM GUIDE RAILING	LF	1. ASPHALT JOINT ADHESIVE, ITEM 418.7603, SHALL BE USED ON VERTICAL FACES FOR ALL THE JOINTS ON THE SURFACE COURSE SUCH AS LONGITUDINAL, TRANSVERSE, OR OTHER JOINTS ABUTTING THE NEW ASPHALT PAVEMENT. 2. SEE GUIDE RAIL TABLE ON DWG. MT-1 FOR LOCATION OF WORK.	
SIGNATURE: STAMP:		304.12	SUBBASE COURSE, TYPE 2	CY	606.8903	TRANSITION: HPBO (MOD.) CORRUGATED BEAM GUIDE RAILING TO SINGLE SLOPE CONCRETE HALF SECTION BARRIER	EA		
		404.097201	9.5 F2 TOP COURSE ASPHALT, 70 SERIES COMPACTION	TON	608.020102	ASPHALT SIDEWALKS, DRIVEWAYS AND BICYCLE PATHS, AND VEGETATION CONTROL STRIPS	TON		
		404.197901	19 F9 BINDER COURSE ASPHALT, 70 SERIES COMPACTION	TON	610.1402	TOPSOIL - ROADSIDE	CY		
		404.377901	37.5 F9 BASE COURSE ASPHALT, 70 SERIES COMPACTION	TON	610.1601	TURF ESTABLISHMENT - ROADSIDE	SY		
		407.0103	STRAIGHT TACK COAT	GAL	649.01	MILLED-IN AUDIBLE ROADWAY DELINEATORS (MIARDS)	LF		
		418.7603	ASPHALT PAVEMENT JOINT ADHESIVE	LF					
		557.2002	STRUCTURAL APPROACH SLAB WITH INTEGRAL WEARING SURFACE - TYPE 2 FRICTION	SY					
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BEGIN STATION	OFFSET (FT)	END STATION	OFFSET (FT)	SIDE	GUIDE RAIL TABLE																
					ITEM 606.1403 (EA)	ITEM 606.2701 (FT)	ITEM 606.2703 (EA)	ITEM 606.28 (EA)	ITEM 606.5248 (FT)	ITEM 606.5448 (FT)	ITEM 606.581001 (FT)	ITEM 606.7101 (FT)	ITEM 606.7201 (FT)	ITEM 606.7910 (EA)	ITEM 606.8903 (EA)	ITEM 606.8906 (EA)	ITEM 606.9004 (EA)				
EB 1+54	26.1	EB 5+56	24.6	LT						402											
EB 5+09	24.6				1																
EB 8+13.5	38.3	EB 9+26.3	34.5	LT								112.5									
EB 9+26.3	34.5	EB 9+51.3	34.5	LT							25.0										
EB 6+25.8	41.0	EB 6+50.8	41.0	LT				1													
EB 6+50.8	41.0	EB 9+38.5	34.1	LT						287.5											
EB 9+38.5	34.1	EB 9+89.1	33.1	LT														1			
EB 9+89.1	33.1	EB 9+99.1	33.1	LT																	1
EB 8+92.1	23.1	EB 9+67.0	20.4	RT				75.0													
EB 9+67.0	20.4			RT														1			
EB 11+08.6	22.7	EB 11+65.7	22.9	RT								62.5									
EB 10+88.8	20.5	EB 10+88.8	20.5	RT																	
EB 10+88.8	20.5	EB 11+65.7	22.9	RT				75.0											1		
EB 11+17.3	34.9	EB 12+09.0	37.3	LT								87.5									
EB 12+09.0	37.3	EB 12+30.4	41.5	LT																	
EB 11+03.4	33.4	EB 11+03.4	33.4	LT																	
EB 12+03.4	33.4	EB 12+03.4	33.4	LT				100.0													
EB 12+03.4	33.4	EB 12+28.0	37.3	LT																	
WB 8+59.4	42.6	WB 8+83.2	38.6	RT																	
WB 8+83.2	38.6	WB 9+73.3	34.6	RT								87.5									
WB 8+63.0	37.9	WB 8+87.6	33.9	RT																	
WB 8+87.6	33.9	WB 9+87.6	33.6	RT				100.0													
WB 9+87.6	33.6			RT																	
WB 9+27.3	22.5	WB 9+92.6	21.9	LT								62.5									
WB 9+27.3	22.5	WB 10+02.2	20.4	LT																	
WB 10+02.2	20.4			LT																	
WB 11+30.6	34.2	WB 11+64.9	34.4	RT								37.5									
WB 10+92.0	33.1	WB 11+02.0	33.1	RT																	
WB 11+02.0	33.1	WB 11+52.6	33.1	RT																	
WB 11+52.6	33.1	WB 14+90.1	36.1	RT																	
WB 14+90.1	36.1	WB 18+52.6	41.5	RT																	
WB 11+26.5	22.1	WB 11+98.8	26.7	LT																	
WB 11+24.0	20.7	WB 11+24.0	20.7	LT																	
WB 11+24.0	20.7	WB 11+98.8	26.7	LT				75.0													
TOTAL					1	500.0	2	1	362.5	402.0	625.0	437.5	112.5	2	6	2	2				

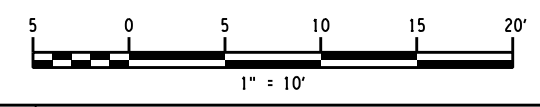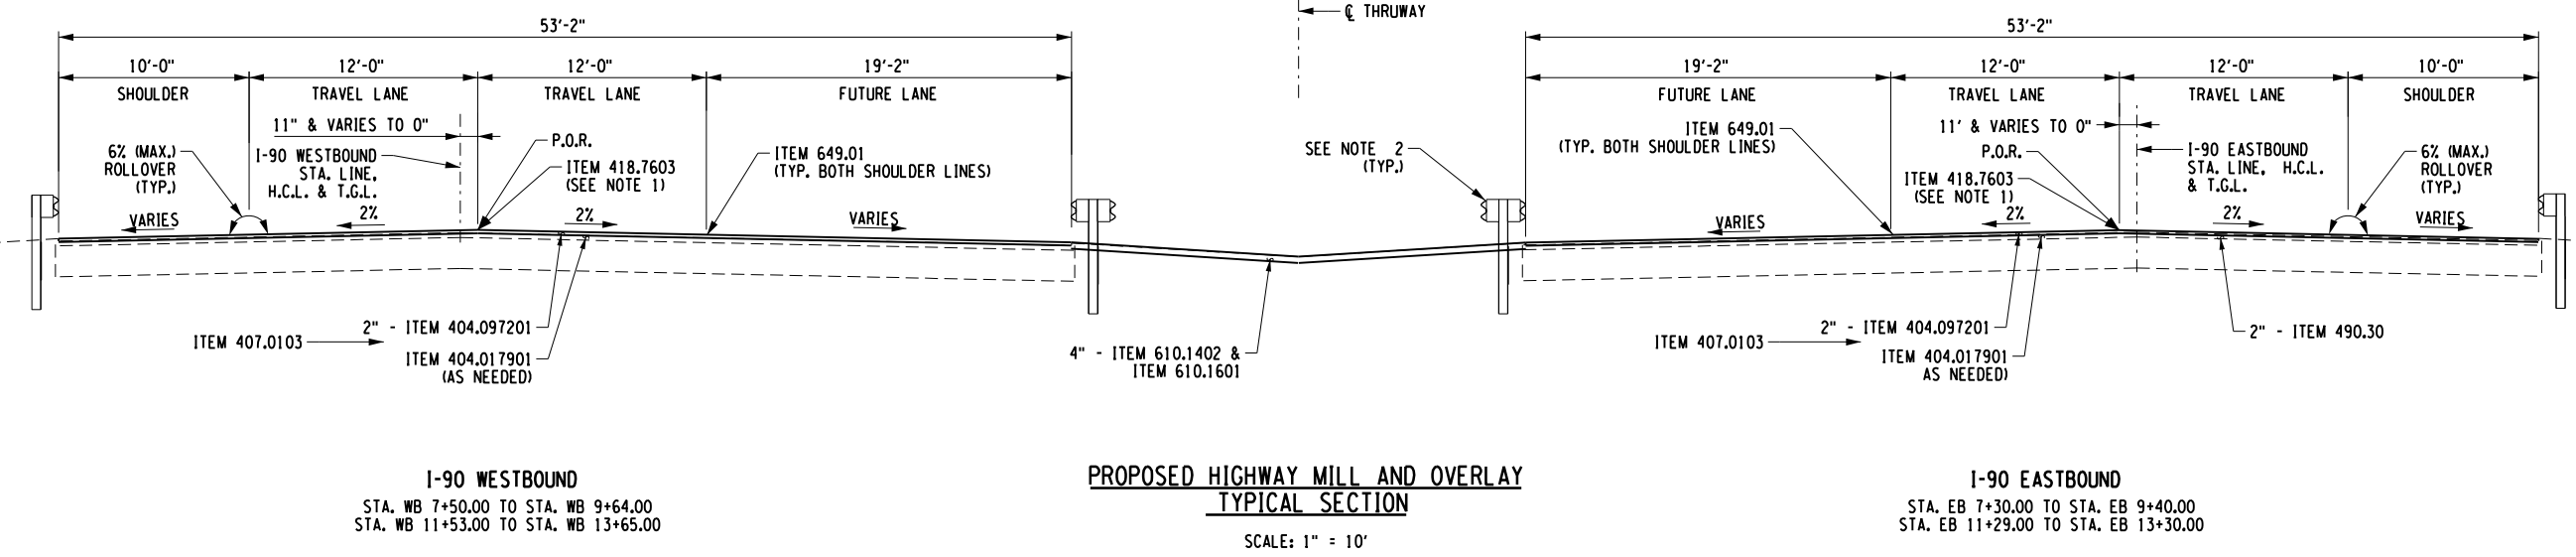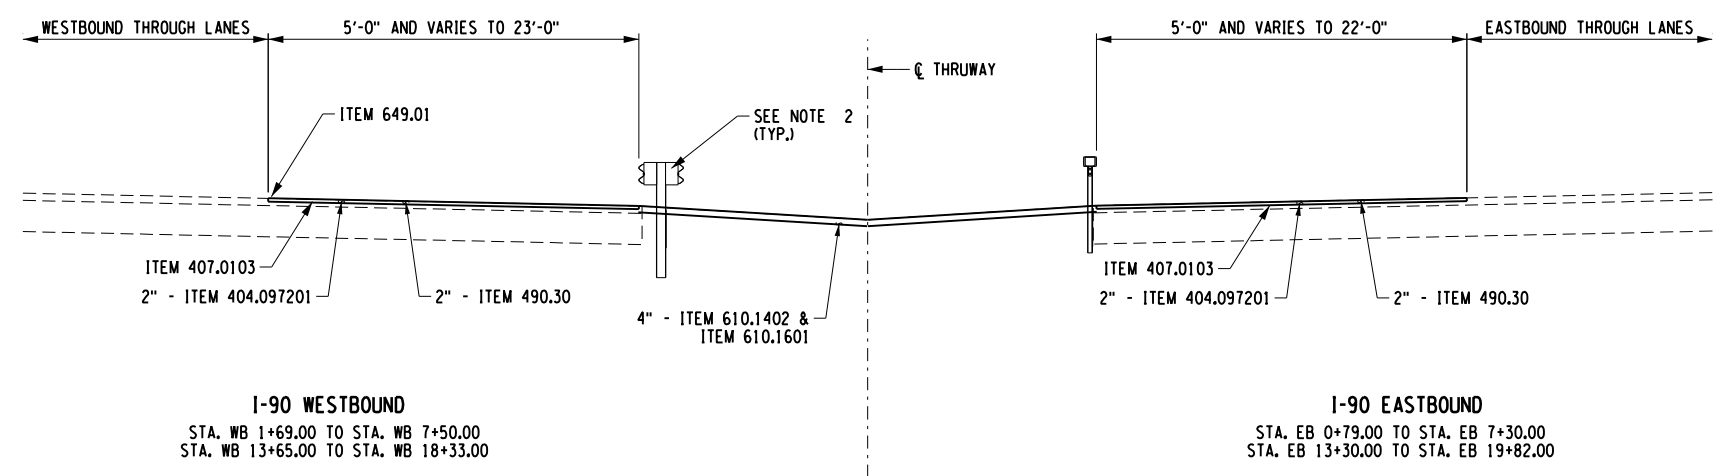PAY ITEM DESCRIPTION:
 ITEM 606.1403 - BOX BEAM MEDIAN BARRIER END ASSEMBLY, TYPE C
 ITEM 606.2701 - HPBO (MOD.) CORRUGATED BEAM GUIDE RAILING
 ITEM 606.2703 - ANCHORAGE UNITS FOR HPBO (MOD.) CORRUGATED BEAM GUIDE RAILING
 ITEM 606.28 - HPBO (MOD.) CORRUGATED BEAM MEDIAN BARRIER END TERMINAL (ENERGY-ABSORBING)
 ITEM 606.5248 - RESETTING CORRUGATED BEAM MEDIAN BARRIER (NEW POSTS)
 ITEM 606.5448 - RESETTING BOX BEAM MEDIAN BARRIER (NEW POSTS)
 ITEM 606.581001 - RESETTING HPBO (MOD.) CORRUGATED BEAM MEDIAN BARRIER (NEW POSTS)
 ITEM 606.7101 - REMOVING AND DISPOSING HPBO (MOD.) CORRUGATED BEAM GUIDE RAILING
 ITEM 606.7201 - REMOVING AND DISPOSING HPBO (MOD.) CORRUGATED BEAM MEDIAN BARRIER
 ITEM 606.7910 - REMOVING AND DISPOSING ANCHORAGE UNITS FOR CORRUGATED BEAM GUIDE RAILING AND MEDIAN BARRIER
 ITEM 606.8903 - TRANSITION: HPBO (MOD.) CORRUGATED BEAM GUIDE RAILING TO SINGLE SLOPE CONCRETE HALF SECTION BARRIER
 ITEM 606.8906 - TRANSITION: HPBO (MOD.) CORRUGATED BEAM MEDIAN BARRIER TO SINGLE SLOPE CONCRETE MEDIAN BARRIER
 ITEM 606.9004 - TRANSITION BETWEEN HALF-SECTION AND FULL-SECTION SINGLE SLOPE CONCRETE BARRIER (RIGHT POCKET)

REFERENCE MARKER TABLE EASTBOUND							
STATION	OFFSET (FT)	SIDE	ITEM 646.06030025		ITEM 646.08010025 (EA)	ITEM 646.08020025 (EA)	ITEM 647.83001002 (EA)
			QUANTITY	COLOR			
EB 1+29.4	25	LT			1		1
EB 2+60.2	26	LT	1	YELLOW			1
EB 3+74.5	29	LT			1		1
EB 5+15.2	28	LT	1	DOUBLE YELLOW	1		1
EB 7+84.6	34	LT	1	YELLOW		1	1
EB 9+15.7	24	RT	1	WHITE			1
EB 9+21.2	36	LT	1	YELLOW			1
EB 10+77.2	23	RT	1	RM 227.4			1
EB 10+87.8	34	LT			1		1
EB 12+04.0	34	LT			1		
EB 13+13.1	33	LT	1	YELLOW			1
EB 15+77.3	26	LT	1	YELLOW			1
EB 18+42.2	21	LT	1	YELLOW			
TOTAL			9		5	1	11

PAY ITEM DESCRIPTION:
 ITEM 646.06030025 - INSTALL DELINEATOR OR TENGTH MILE MARKER ON POST
 ITEM 646.08010025 - INSTALL SNOWPLOW MARKER, SINGLE UNIT
 ITEM 646.08020025 - INSTALL SNOWPLOW MARKER, DOUBLE UNIT
 ITEM 647.83001002 - REMOVAL AND DISPOSAL OF DELINEATORS AND/OR REFERENCE MARKERS WITH OR WITHOUT POSTS

REFERENCE MARKER TABLE WESTBOUND							
STATION	OFFSET (FT)	SIDE	ITEM 646.06030025		ITEM 646.08010025 (EA)	ITEM 646.08020025 (EA)	ITEM 647.83001002 (EA)
			QUANTITY	COLOR			
WB 2+63.6	24	RT	1	YELLOW			1
WB 5+25.2	28	RT	1	YELLOW			1
WB 6+32.1	30	RT	1	DOUBLE YELLOW			1
WB 7+54.1	33	RT	1	YELLOW			1
WB 8+73.8	35	RT					1
WB 8+87.2	35	RT				1	
WB 9+92.0	23	LT	1	RM 227.4			1
WB 9+92.2	34	RT	1	YELLOW			1
WB 10+96.5	34	RT					1
WB 11+22.8	35	RT	1	YELLOW			
WB 11+91.9	28	LT	1	WHITE			1
WB 13+73.0	37	RT	1	YELLOW			1
WB 13+89.4	41	RT				1	1
WB 15+79.0	34	RT	1	YELLOW			1
WB 16+89.3	32	RT					1
WB 17+75.5	29	RT	1	YELLOW			1
TOTAL			11		2	0	14

PAY ITEM DESCRIPTION:
 ITEM 646.06030025 - INSTALL DELINEATOR OR TENGTH MILE MARKER ON POST
 ITEM 646.08010025 - INSTALL SNOWPLOW MARKER, SINGLE UNIT
 ITEM 646.08020025 - INSTALL SNOWPLOW MARKER, DOUBLE UNIT
 ITEM 647.83001002 - REMOVAL AND DISPOSAL OF DELINEATORS AND/OR REFERENCE MARKERS WITH OR WITHOUT POSTS

SIGN TEXT DATA							
TEXT NUMBER	LOCATION NUMBER	ITEM NUMBER	PAYMENT FACTOR	TOTAL QUANTITY	TEXT	MUTCD NUMBER	MOUNT
1	1-1	645.5102	26.0 SF	26.0 SF		R3-4 36" x 36"	GR MTD
		645.81	2 EA	2 EA		W16-11P (MOD)	
		645.81090003	2 EA	4 EA		30" x 18"	

(BACK TO BACK)

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 USER = LINDO
 DESIGN SUPERVISOR: P. PRESUTTI
 DESIGNED BY: B. HYDE
 CHECKED BY: P. PRESUTTI
 DRAFTED BY: S. BEAMAN
 CHECKED BY: B. HYDE

ALTERED ON: _____ AFFIXED ON: 12/04/2023

SIGNATURE: _____ SIGNATURE: _____
 STAMP: _____ STAMP: _____

IT IS A VIOLATION OF LAW FOR ANY PERSON, UNLESS THEY ARE ACTING UNDER THE DIRECTION OF A LICENSED PROFESSIONAL ENGINEER, ARCHITECT, LANDSCAPE ARCHITECT, OR LAND SURVEYOR, TO ALTER AN ITEM IN ANY WAY. IF AN ITEM BEARING THE STAMP OF A LICENSED PROFESSIONAL IS ALTERED, THE ALTERING ENGINEER, ARCHITECT, LANDSCAPE ARCHITECT, OR LAND SURVEYOR SHALL STAMP THE DOCUMENT AND INCLUDE THE NOTATION "ALTERED BY" FOLLOWED BY THEIR SIGNATURE. THE DATE OF SUCH ALTERATION, AND A SPECIFIC DESCRIPTION OF THE ALTERATION.

REVISIONS			
DATE	DESCRIPTION	BY	SYM.

ERDMAN ANTHONY

TITLE OF PROJECT STERLING CREEK BRIDGE REHABILITATION	CONTRACT NUMBER: TAS 24-5B
LOCATION OF PROJECT SYRACUSE DIVISION BIN 5516091 & 5516092 MP 227.40 & MP 227.41	DATE: NOV. 2023
TITLE OF DRAWING MISCELLANEOUS TABLES	DRAWING NUMBER: MT-1


CHECKED BY: N. BARNHARD

DRAFTED BY: T. LINDO


CHECKED BY: C. SICHAK

DESIGNED BY: B. HYDE


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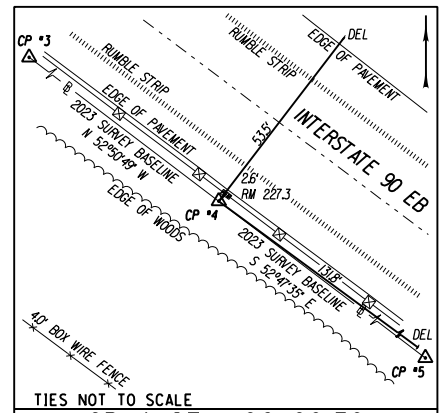
TIES NOT TO SCALE
CP 1 STA. 10+00.00
 CP 1 IS A REBAR W/RAVI CAP SET ON THE TOP OF BANK OF THE EASTBOUND RIGHT SHOULDER (BEHIND GUIDERAIL), LOCATED APPROX. 1,126 FEET NORTHWESTERLY FROM THE WESTERLY BRIDGE JOINT OF BRIDGE OVER STERLING CREEK.
 NYSPCS NAD 83(2011) EASTERN ZONE
 NAVD 88
 NORTHING 1,547,861.018
 EASTING 328,479.064
 ELEV 436.69'

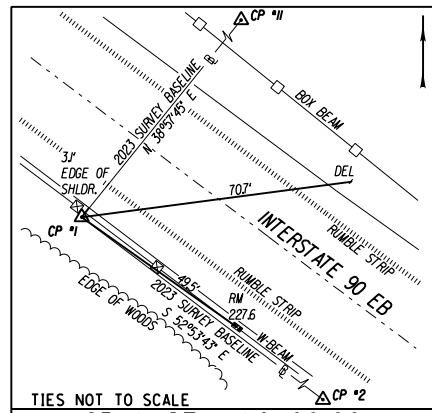


TIES NOT TO SCALE
CP 2 STA. 15+19.90
 CP 2 IS A REBAR W/RAVI CAP SET ON THE TOP OF BANK OF THE EASTBOUND RIGHT SHOULDER (BEHIND GUIDERAIL), LOCATED APPROX. 677 FEET NORTHWESTERLY FROM THE WESTERLY BRIDGE JOINT OF BRIDGE OVER STERLING CREEK.
 NYSPCS NAD 83(2011) EASTERN ZONE
 NAVD 88
 NORTHING 1,547,547.374
 EASTING 328,893.705
 ELEV 433.97'

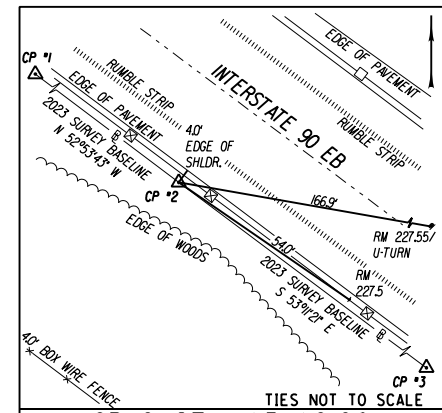


TIES NOT TO SCALE
CP 3 STA. 20+26.70
 CP 3 IS A REBAR W/RAVI CAP SET AT THE SOUTHWESTERLY WINGWALL OF BRIDGE (BEHIND GUIDERAIL), LOCATED APPROX. 13 FEET NORTHWESTERLY FROM THE WESTERLY BRIDGE JOINT OF BRIDGE OVER STERLING CREEK.
 NYSPCS NAD 83(2011) EASTERN ZONE
 NAVD 88
 NORTHING 1,547,243.716
 EASTING 329,299.453
 ELEV 434.35'

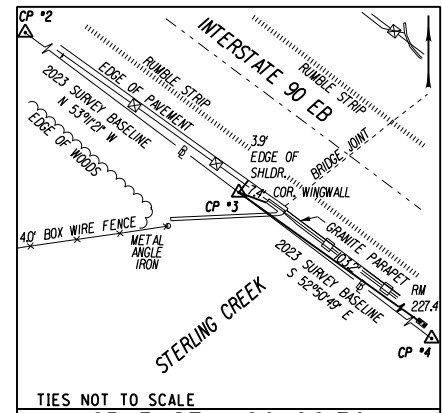


TIES NOT TO SCALE
CP 4 STA. 26+29.72
 CP 4 IS A REBAR W/RAVI CAP SET AT MILEPOST 227.3 EASTBOUND (BEHIND GUIDERAIL), LOCATED APPROX. 506 FEET SOUTHEASTERLY FROM THE EASTERLY BRIDGE JOINT OF BRIDGE OVER STERLING CREEK.
 NYSPCS NAD 83(2011) EASTERN ZONE
 NAVD 88
 NORTHING 1,546,879.521
 EASTING 329,780.078
 ELEV 437.44'

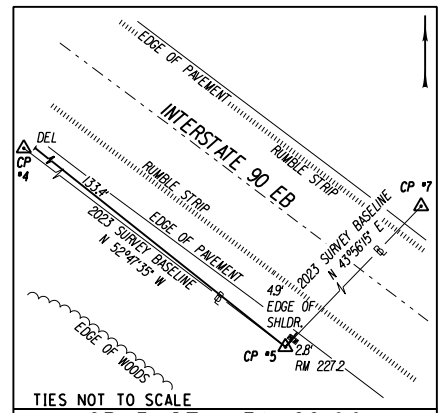


TIES NOT TO SCALE
CP 5 STA. 31+62.80
 CP 5 IS A REBAR W/RAVI CAP SET AT MILEPOST 227.2 EASTBOUND (BEHIND GUIDERAIL), LOCATED APPROX. 1,040 FEET SOUTHEASTERLY FROM THE EASTERLY BRIDGE JOINT OF BRIDGE OVER STERLING CREEK.
 NYSPCS NAD 83(2011) EASTERN ZONE
 NAVD 88
 NORTHING 1,546,557.170
 EASTING 330,204.653
 ELEV 441.02'

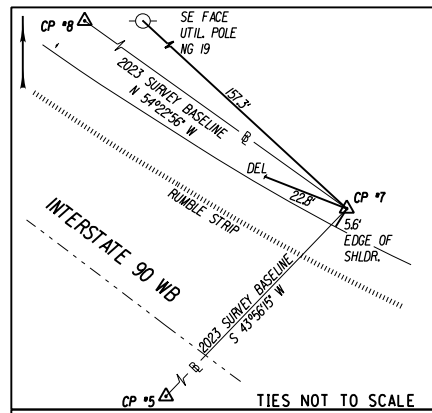


TIES NOT TO SCALE
CP 7 STA. 33+34.16
 CP 7 IS A REBAR W/RAVI CAP SET ON THE TOP OF BANK OF THE WESTBOUND RIGHT SHOULDER (BEHIND GUIDERAIL), LOCATED APPROX. 181 FEET SOUTHWESTERLY FROM THE SOUTHWESTERLY FENCE CORNER OF THE REST AREA TREATMENT PLANT.
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 NAVD 88
 NORTHING 1,546,680.566
 EASTING 330,323.555
 ELEV 441.08'

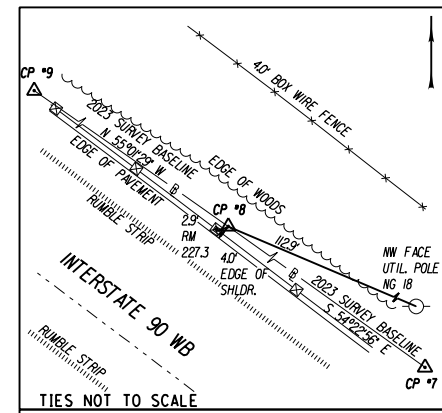


TIES NOT TO SCALE
CP 8 STA. 38+78.37
 CP 8 IS A REBAR W/RAVI CAP SET AT MILEPOST 227.3 WESTBOUND (BEHIND GUIDERAIL), LOCATED APPROX. 482 FEET SOUTHEASTERLY FROM THE EASTERLY BRIDGE JOINT OF BRIDGE OVER STERLING CREEK.
 NYSPCS NAD 83(2011) EASTERN ZONE
 NAVD 88
 NORTHING 1,546,997.501
 EASTING 329,881.155
 ELEV 437.36'

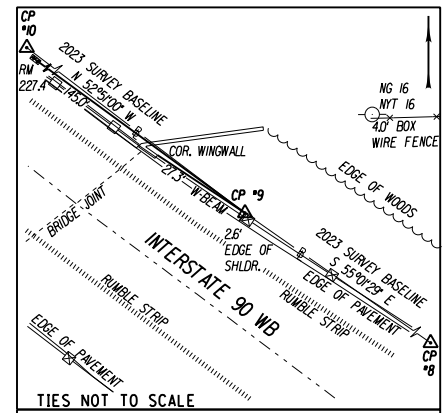

TIES NOT TO SCALE
CP 9 STA. 43+28.98
 CP 9 IS A REBAR W/RAVI CAP SET ON THE TOP OF BANK OF THE WESTBOUND RIGHT SHOULDER (BEHIND GUIDERAIL), LOCATED APPROX. 31 FEET SOUTHEASTERLY FROM THE EASTERLY BRIDGE JOINT OF BRIDGE OVER STERLING CREEK.
 NYSPCS NAD 83(2011) EASTERN ZONE
 NAVD 88
 NORTHING 1,547,255.798
 EASTING 329,511.930
 ELEV 434.89'

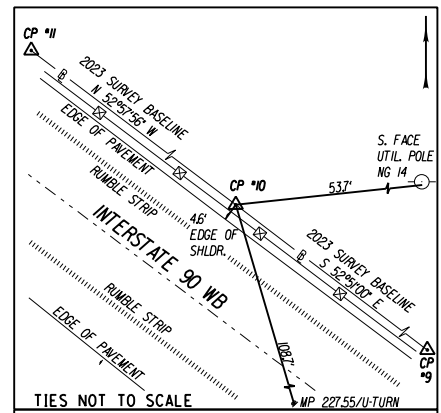

TIES NOT TO SCALE
CP 10 STA. 49+36.77
 CP 10 IS A REBAR W/RAVI CAP SET AT MILEPOST 227.5 WESTBOUND (BEHIND GUIDERAIL), LOCATED APPROX. 492 FEET NORTHWESTERLY FROM THE WESTERLY BRIDGE JOINT OF BRIDGE OVER STERLING CREEK.
 NYSPCS NAD 83(2011) EASTERN ZONE
 NAVD 88
 NORTHING 1,547,622.844
 EASTING 329,027.487
 ELEV 433.51'

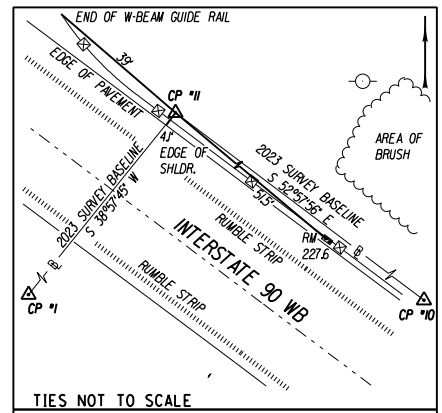

TIES NOT TO SCALE
CP 11 STA. 55+13.29
 CP 11 IS A REBAR W/RAVI CAP SET ON THE TOP OF BANK OF THE WESTBOUND RIGHT SHOULDER (BEHIND GUIDERAIL), LOCATED APPROX. 1,068 FEET NORTHWESTERLY FROM THE WESTERLY BRIDGE JOINT OF BRIDGE OVER STERLING CREEK.
 NYSPCS NAD 83(2011) EASTERN ZONE
 NAVD 88
 NORTHING 1,547,970.082
 EASTING 328,567.265
 ELEV 436.83'

MAINLINE HORIZONTAL ALIGNMENT COORDINATES			
POINT	STATION	NORTH	EAST
I-90 EASTBOUND			
P.O.B.	EB 0+00.00	1547849.70	328536.53
P.O.E.	EB 21+11.00	1546579.28	330222.73
I-90 WESTBOUND			
P.O.B.	WB 0+00.00	1547920.30	328589.06
P.O.E.	WB 21+12.00	1546649.56	330275.68

ALTERED ON: _____ AFFIXED ON: 12/04/2023

SIGNATURE: _____ SIGNATURE: _____
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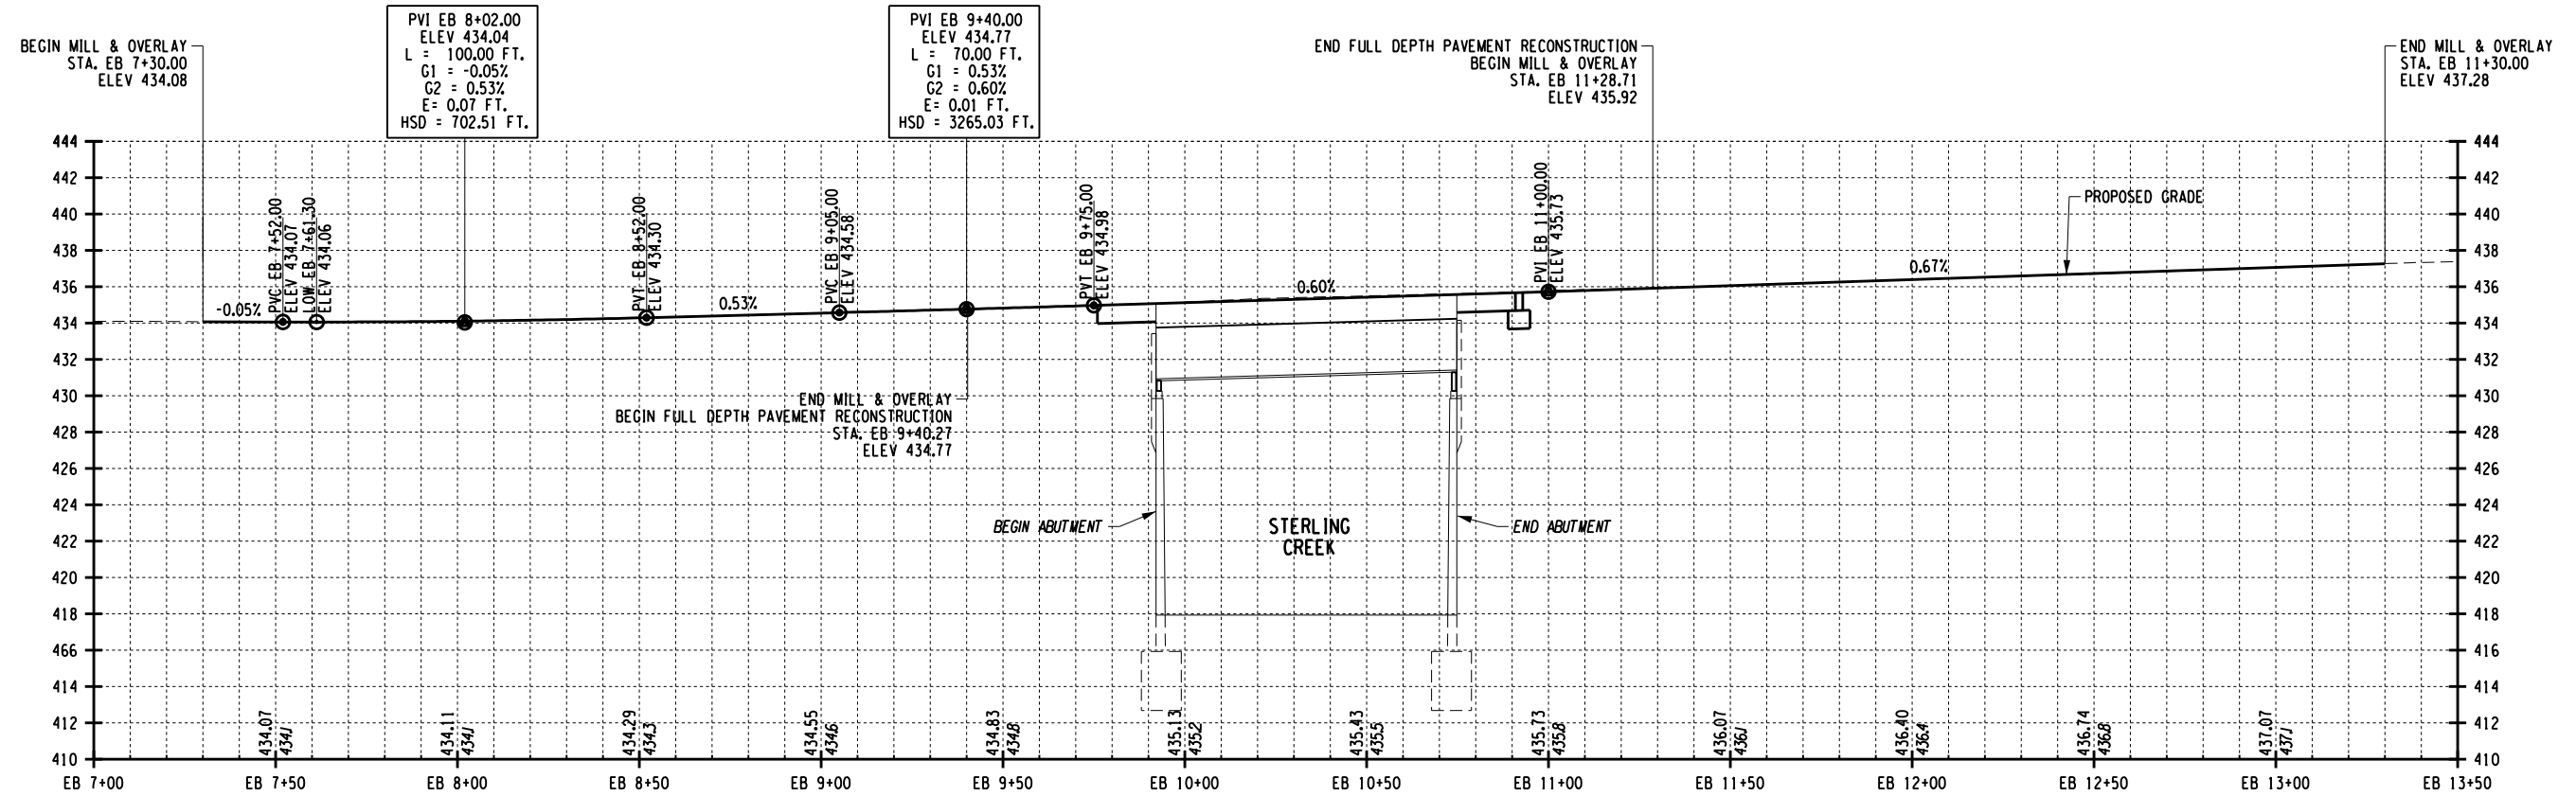
IT IS A VIOLATION OF LAW FOR ANY PERSON, UNLESS THEY ARE ACTING UNDER THE DIRECTION OF A LICENSED PROFESSIONAL ENGINEER, ARCHITECT, LANDSCAPE ARCHITECT, OR LAND SURVEYOR, TO ALTER AN ITEM IN ANY WAY. IF AN ITEM BEARING THE STAMP OF A LICENSED PROFESSIONAL IS ALTERED, THE ALTERING ENGINEER, ARCHITECT, LANDSCAPE ARCHITECT, OR LAND SURVEYOR SHALL STAMP THE DOCUMENT AND INCLUDE THE NOTATION "ALTERED BY" FOLLOWED BY THEIR SIGNATURE. THE DATE OF SUCH ALTERATION, AND A SPECIFIC DESCRIPTION OF THE ALTERATION.

REVISIONS			
DATE	DESCRIPTION	BY	SYM.

Thruway Authority

TITLE OF PROJECT: STERLING CREEK BRIDGE REHABILITATION
 LOCATION OF PROJECT: SYRACUSE DIVISION
 BIN 5516091 & 5516092 MP 227.40 & MP 227.41
 TITLE OF DRAWING: HORIZONTAL AND VERTICAL CONTROL

CONTRACT NUMBER: TAS 24-5B
 DATE: NOV. 2023
 DRAWING NUMBER: HVC-1



PROFILE - 190 EASTBOUND

CHECKED BY: N. BARNHARD


DRAFTED BY: T. LINDO

CHECKED BY:

DESIGNED BY: B. HYDE

DESIGN SUPERVISOR: C. SICHAK

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USER = LINDO

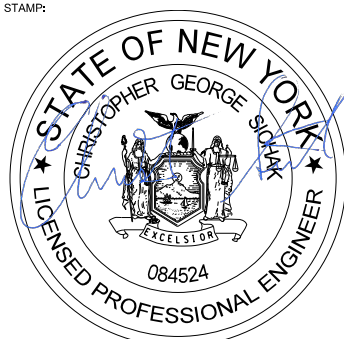ALTERED ON:	AFFIXED ON: 12/04/2023
SIGNATURE: STAMP:	SIGNATURE: STAMP: 

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REVISIONS			
DATE	DESCRIPTION	BY	SYM.




TITLE OF PROJECT: STERLING CREEK BRIDGE REHABILITATION
 LOCATION OF PROJECT: SYRACUSE DIVISION
 BIN 5516091 & 5516092 MP 227.40 & MP 227.41
 TITLE OF DRAWING: PROPOSED PROFILE (EASTBOUND)

CONTRACT NUMBER: TAS 24-5B
 DATE: NOV. 2023
 DRAWING NUMBER: PR-1

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 USER = L.LINDO

DESIGN SUPERVISOR: C. SICHAK
 DESIGNED BY: B. HYDE
 CHECKED BY: T. LINDO
 DRAFTED BY: N. BARNHARD

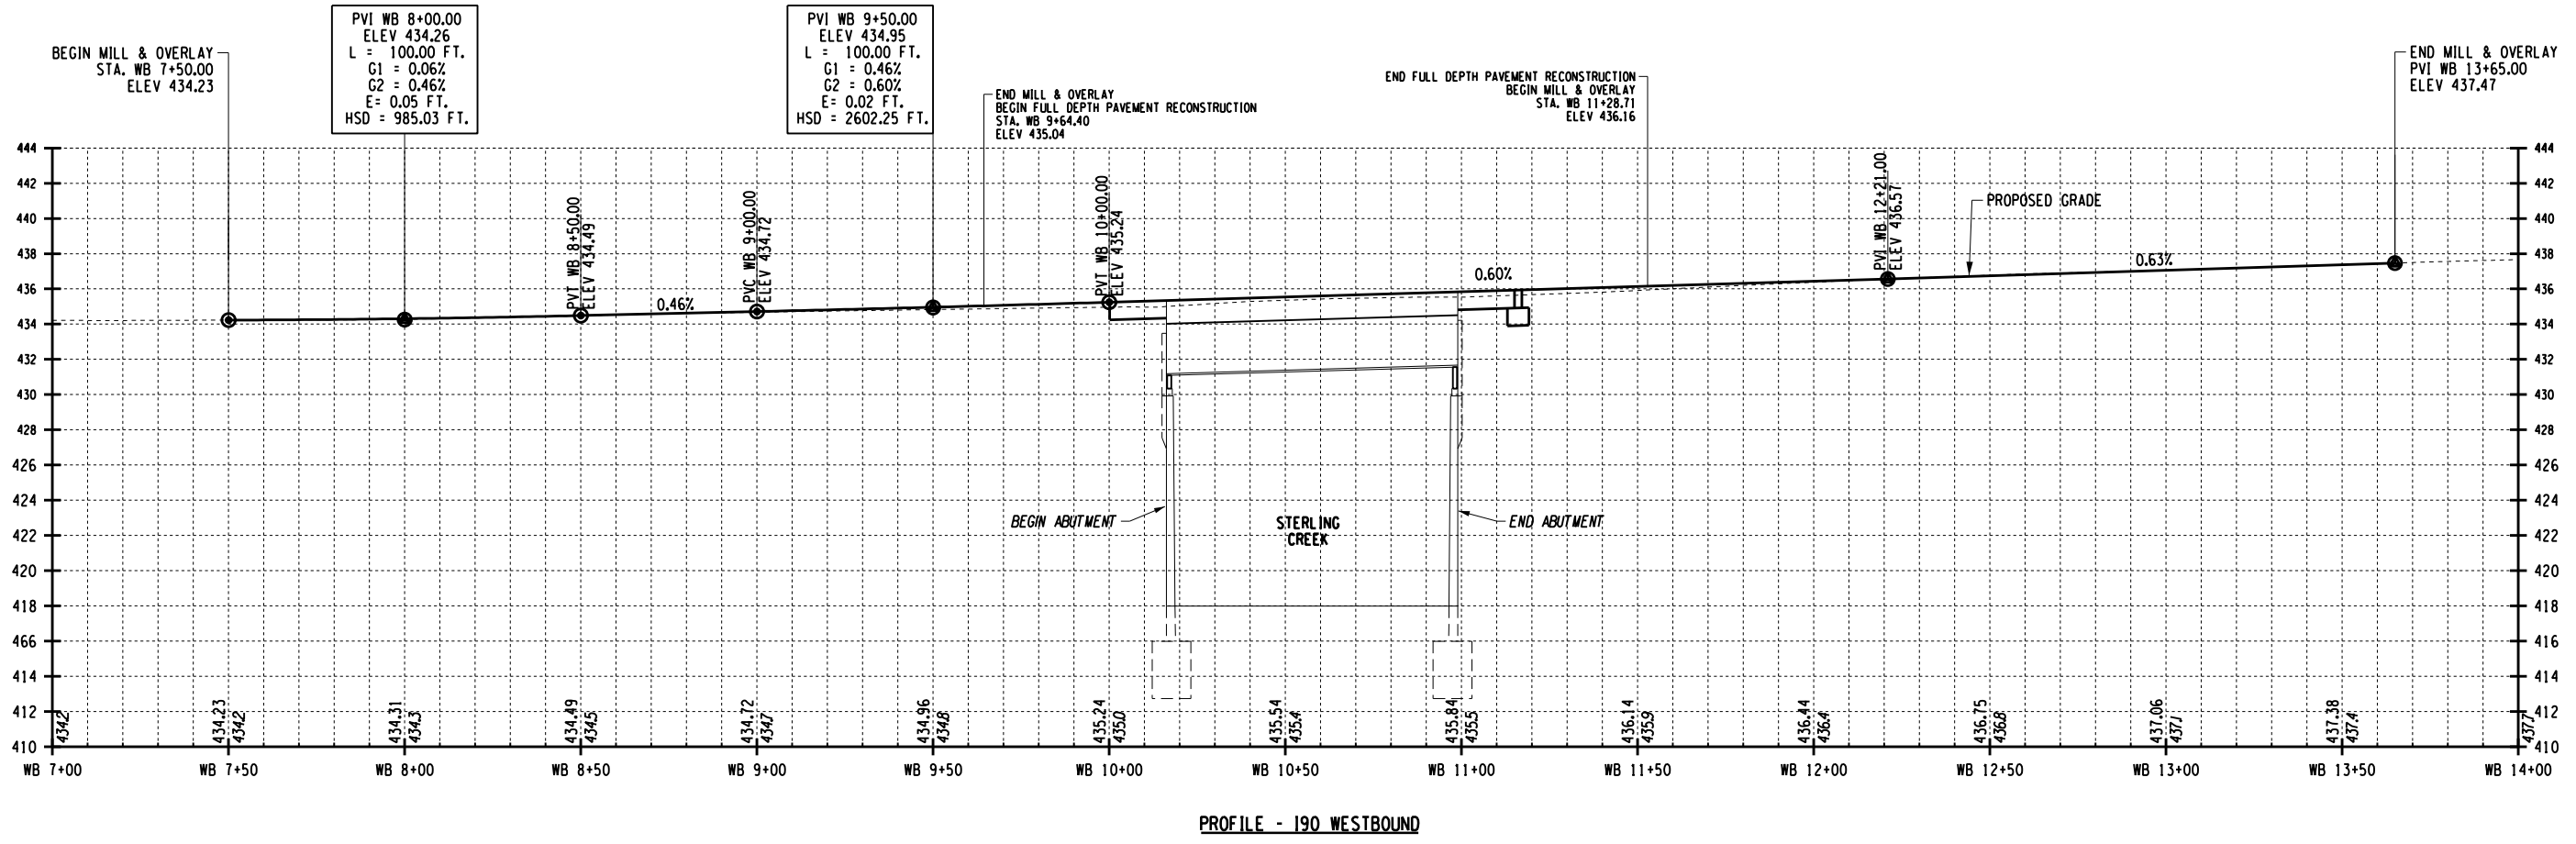

ALTERED ON:	AFFIXED ON: 12/04/2023
SIGNATURE: STAMP:	SIGNATURE: STAMP:

CHRISTOPHER GEORGE SORACK
 LICENSED PROFESSIONAL ENGINEER
 084524



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REVISIONS			
DATE	DESCRIPTION	BY	SYM.

 	TITLE OF PROJECT STERLING CREEK BRIDGE REHABILITATION	CONTRACT NUMBER: TAS 24-5B
	LOCATION OF PROJECT SYRACUSE DIVISION BIN 5516091 & 5516092 MP 227.40 & MP 227.41	DATE: NOV. 2023
	TITLE OF DRAWING PROPOSED PROFILE (WESTBOUND)	DRAWING NUMBER: PR-2

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 USER = L.lindo

DESIGNED BY: C. SICHAK
 CHECKED BY: B. HYDE
 DRAFTED BY: T. LINDO
 CHECKED BY: B. HYDE

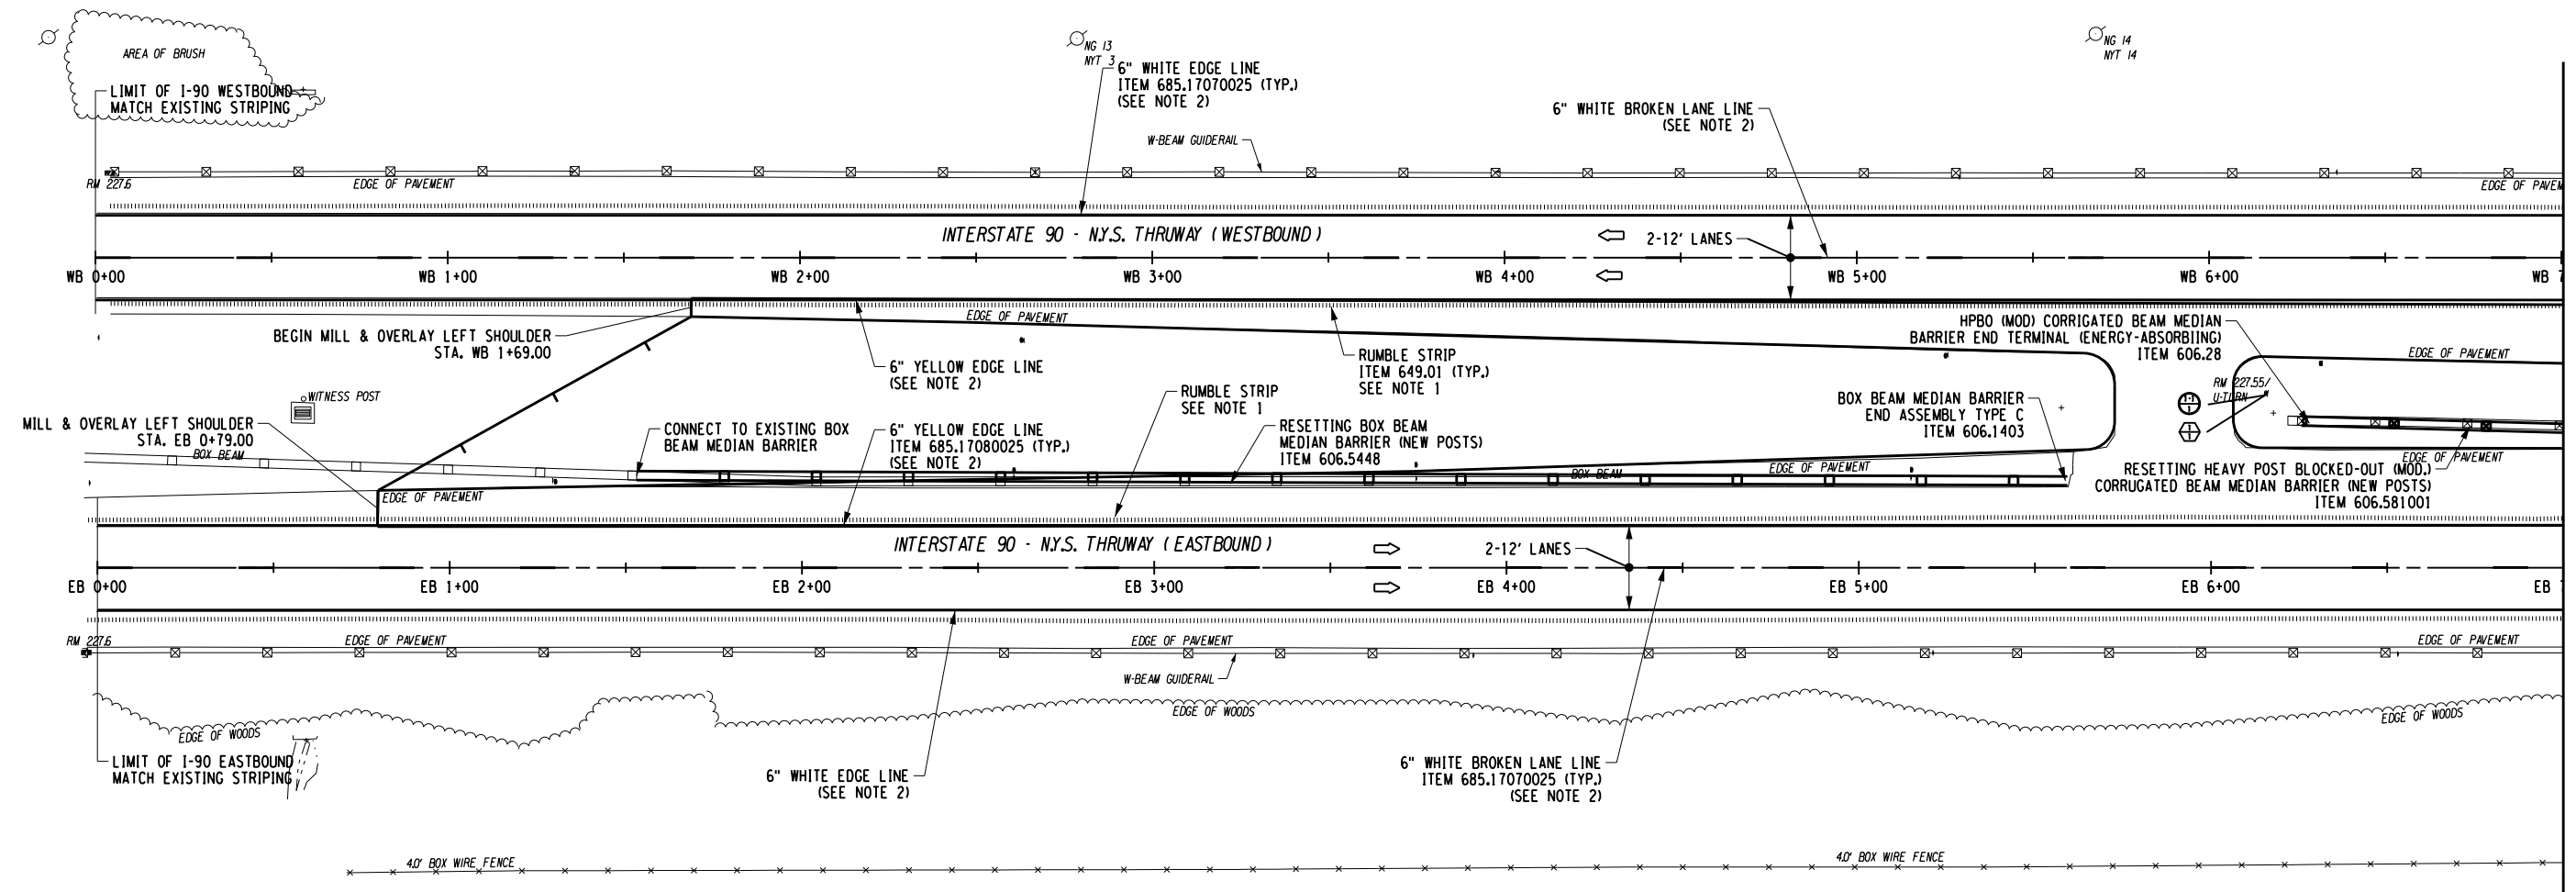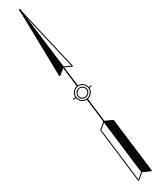

SIGN LEGEND	
SYMBOL	DESCRIPTION
	NEW SIGN: X - SHEET NO., Y - SIGN NO., Z - TEXT NO.
	SIGN REMOVAL
	RELOCATE TO POSITION SHOWN
	TO REMAIN
	EXISTING SIGN
	PROPOSED SIGN

NOTE: REFER TO DWG. NO. 1 FOR SIGN TEXT DATA

NOTES:

- REFER TO NYSDOT STANDARD SHEET 649-02 FOR DETAILS OF MILLED IN AUDIBLE ROADWAY DELINEARS (MIARDS).
- UNLESS OTHERWISE NOTED, ALL MAINLINE PAVEMENT MARKINGS SHALL BE HIGHLY REFLECTORIZED TRIPLE DROP EPOXY PAVEMENT STRIPES, INCLUDING RIGHT AND LEFT EDGE LINES & BROKEN LANE LINES.
- SEE DWG. NO. MT-1 FOR GUIDERAIL TABLE & REFERENCE MARKER TABLE

ALTERED ON:	AFFIXED ON: 12/04/2023
SIGNATURE: STAMP:	SIGNATURE: STAMP:

CHRISTOPHER GEORGE SICHAK
 LICENSED PROFESSIONAL ENGINEER
 084524

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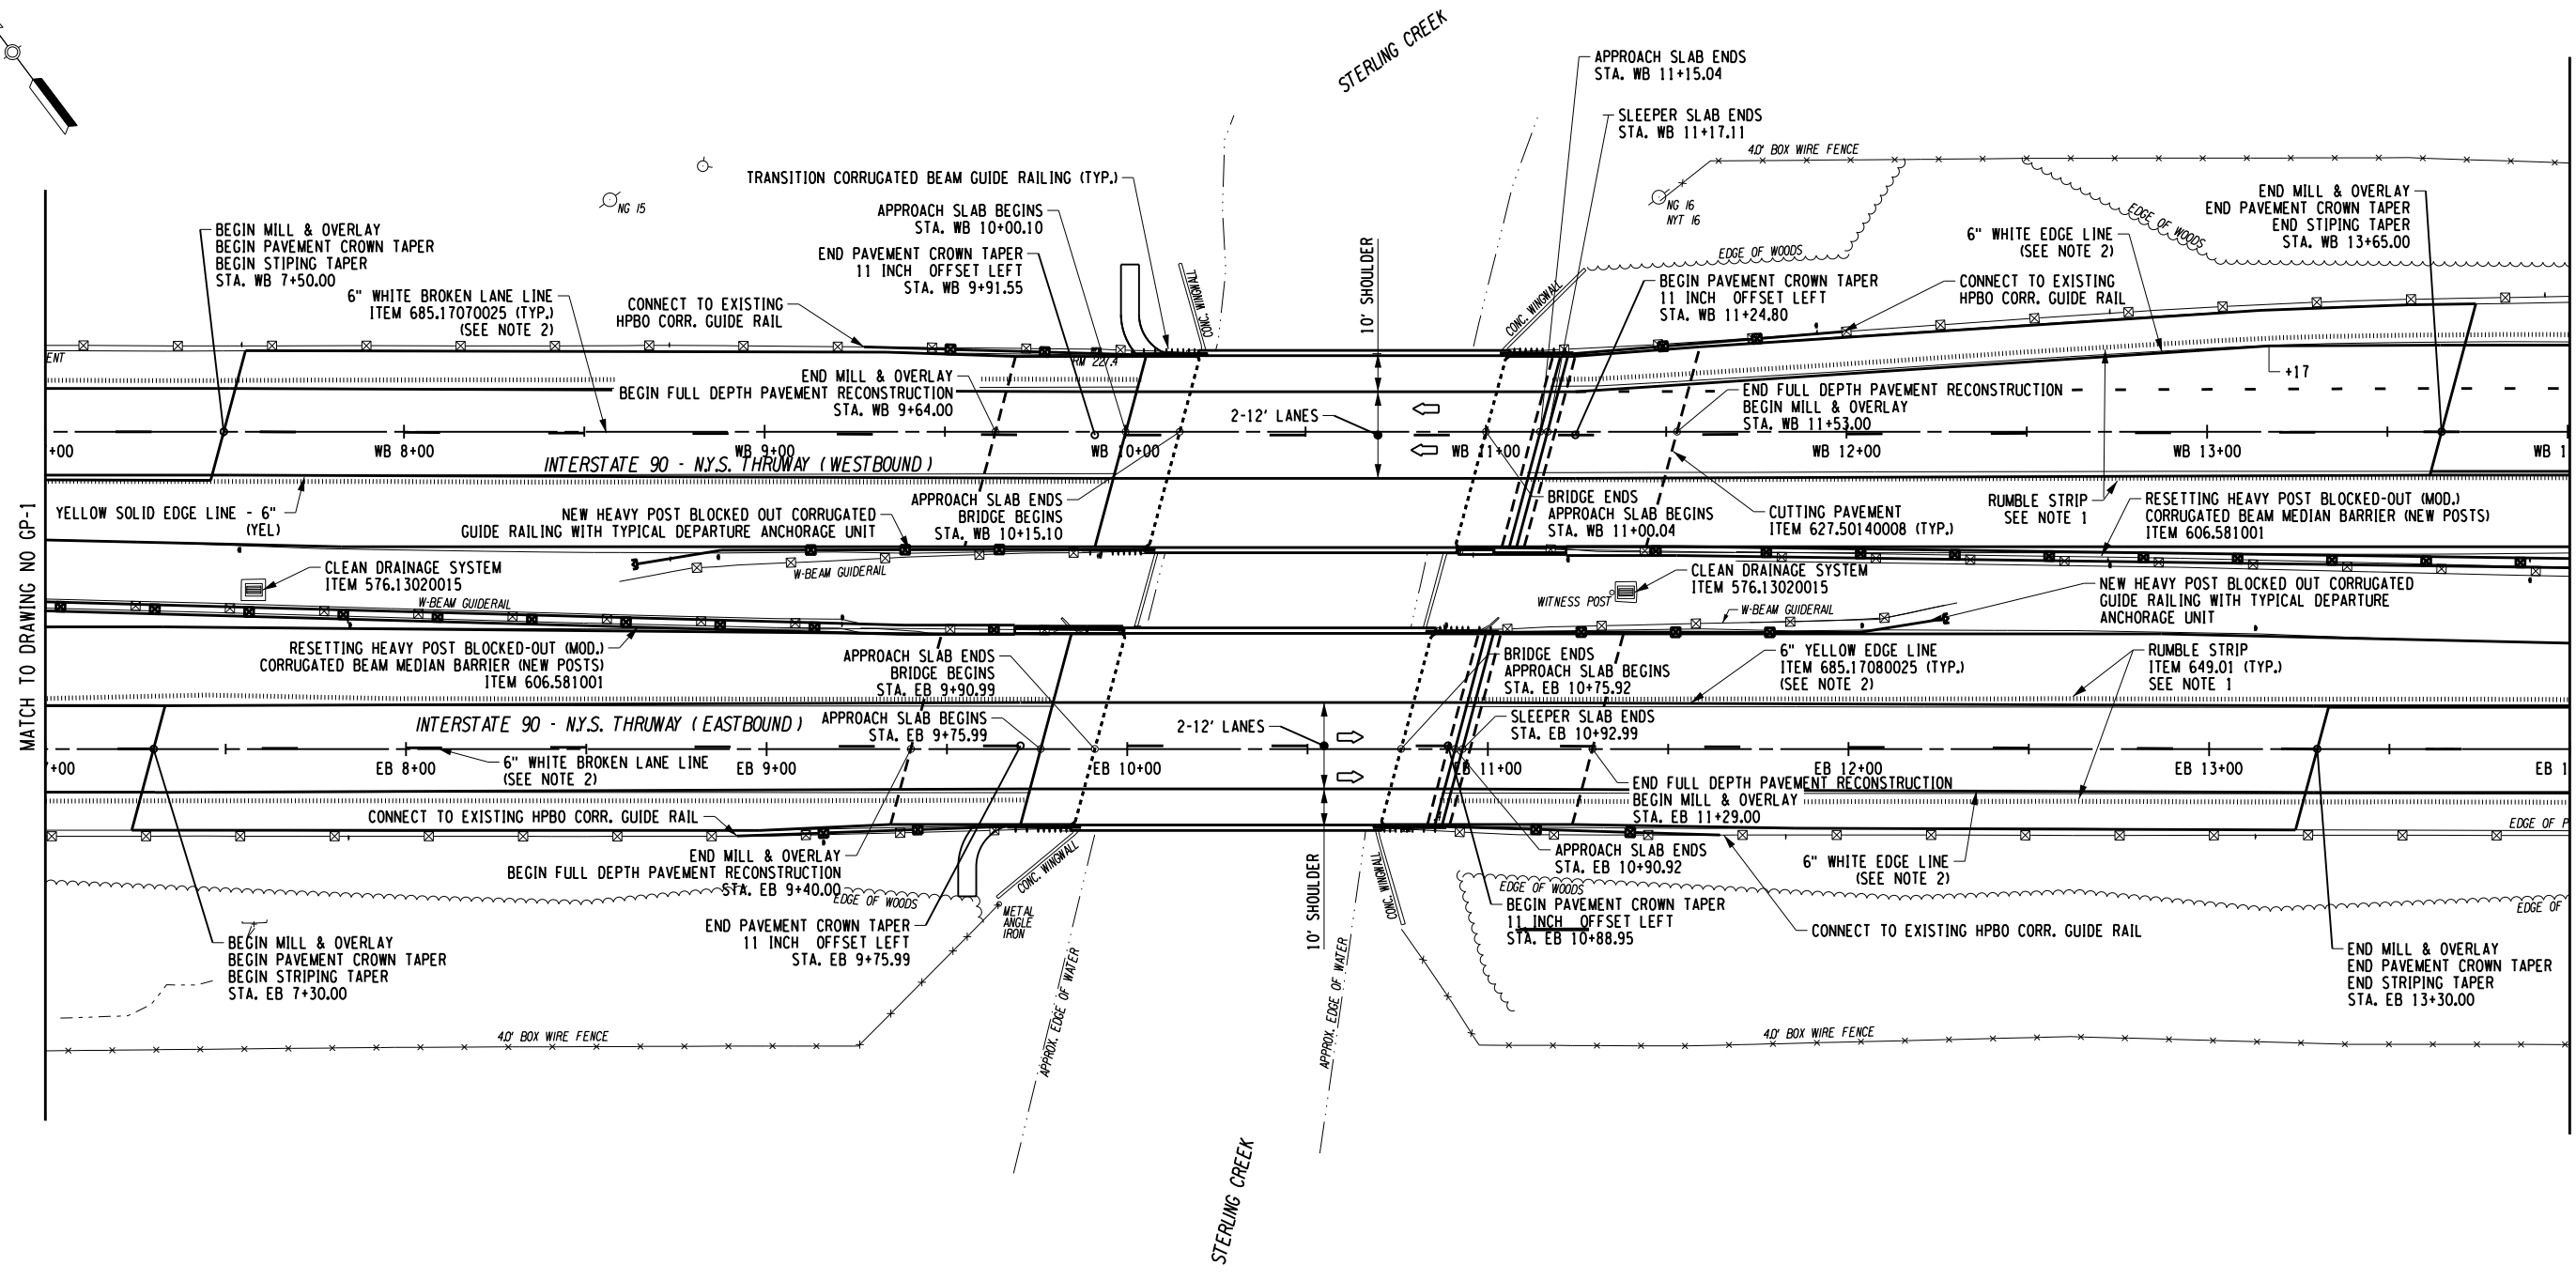
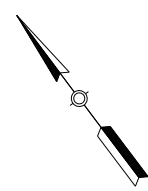
REVISIONS			
DATE	DESCRIPTION	BY	SYM.

	TITLE OF PROJECT STERLING CREEK BRIDGE REHABILITATION	CONTRACT NUMBER: TAS 24-5B
	LOCATION OF PROJECT SYRACUSE DIVISION BIN 5516091 & 5516092 MP 227.40 & MP 227.41	DATE: NOV. 2023
	TITLE OF DRAWING GENERAL PLAN	DRAWING NUMBER: GP-1

MATCH TO DRAWING NO GP-2

FILE NAME = N:\19710-05-Sterling\Drawings\SgnP\m\k\g\lan\p\lans\B222\l_cph_pmp.dgn
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 USER = L.lindo

CHECKED BY: B. HYDE
 DRAFTED BY: T. LINDO
 CHECKED BY: B. HYDE
 DESIGNED BY: B. HYDE
 DESIGN SUPERVISOR: C. SICHAK



NOTES:

1. REFER TO NYSDOT STANDARD SHEET 649-02 FOR DETAILS OF MILLED IN AUDIBLE ROADWAY DELINEARS (MIARDS).
2. UNLESS OTHERWISE NOTED, ALL MAINLINE PAVEMENT MARKINGS SHALL BE HIGHLY REFLECTORIZED TRIPLE DROP EPOXY PAVEMENT STRIPES, INCLUDING RIGHT AND LEFT EDGE LINES & BROKEN LANE LINES.
3. WHITE BROKEN LANE LINE SHALL FOLLOW CROWN TAPER AND 11" OFFSET.
4. SEE DWG. NO MT-1 FOR GUIDERAIL TABLE & REFERENCE MARKER TABLE

ALTERED ON:	AFFIXED ON: 12/04/2023
SIGNATURE: STAMP:	SIGNATURE: STAMP:



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REVISIONS			
DATE	DESCRIPTION	BY	SYM.

 Thruway Authority 	TITLE OF PROJECT STERLING CREEK BRIDGE REHABILITATION	CONTRACT NUMBER: TAS 24-5B
	LOCATION OF PROJECT SYRACUSE DIVISION BIN 5516091 & 5516092 MP 227.40 & MP 227.41	DATE: NOV. 2023
	TITLE OF DRAWING GENERAL PLAN	DRAWING NUMBER: GP-2

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 USER = L.LINDO

DESIGN SUPERVISOR: C. SICHAK
 DRAFTED BY: T. LINDO
 CHECKED BY: B. HYDE

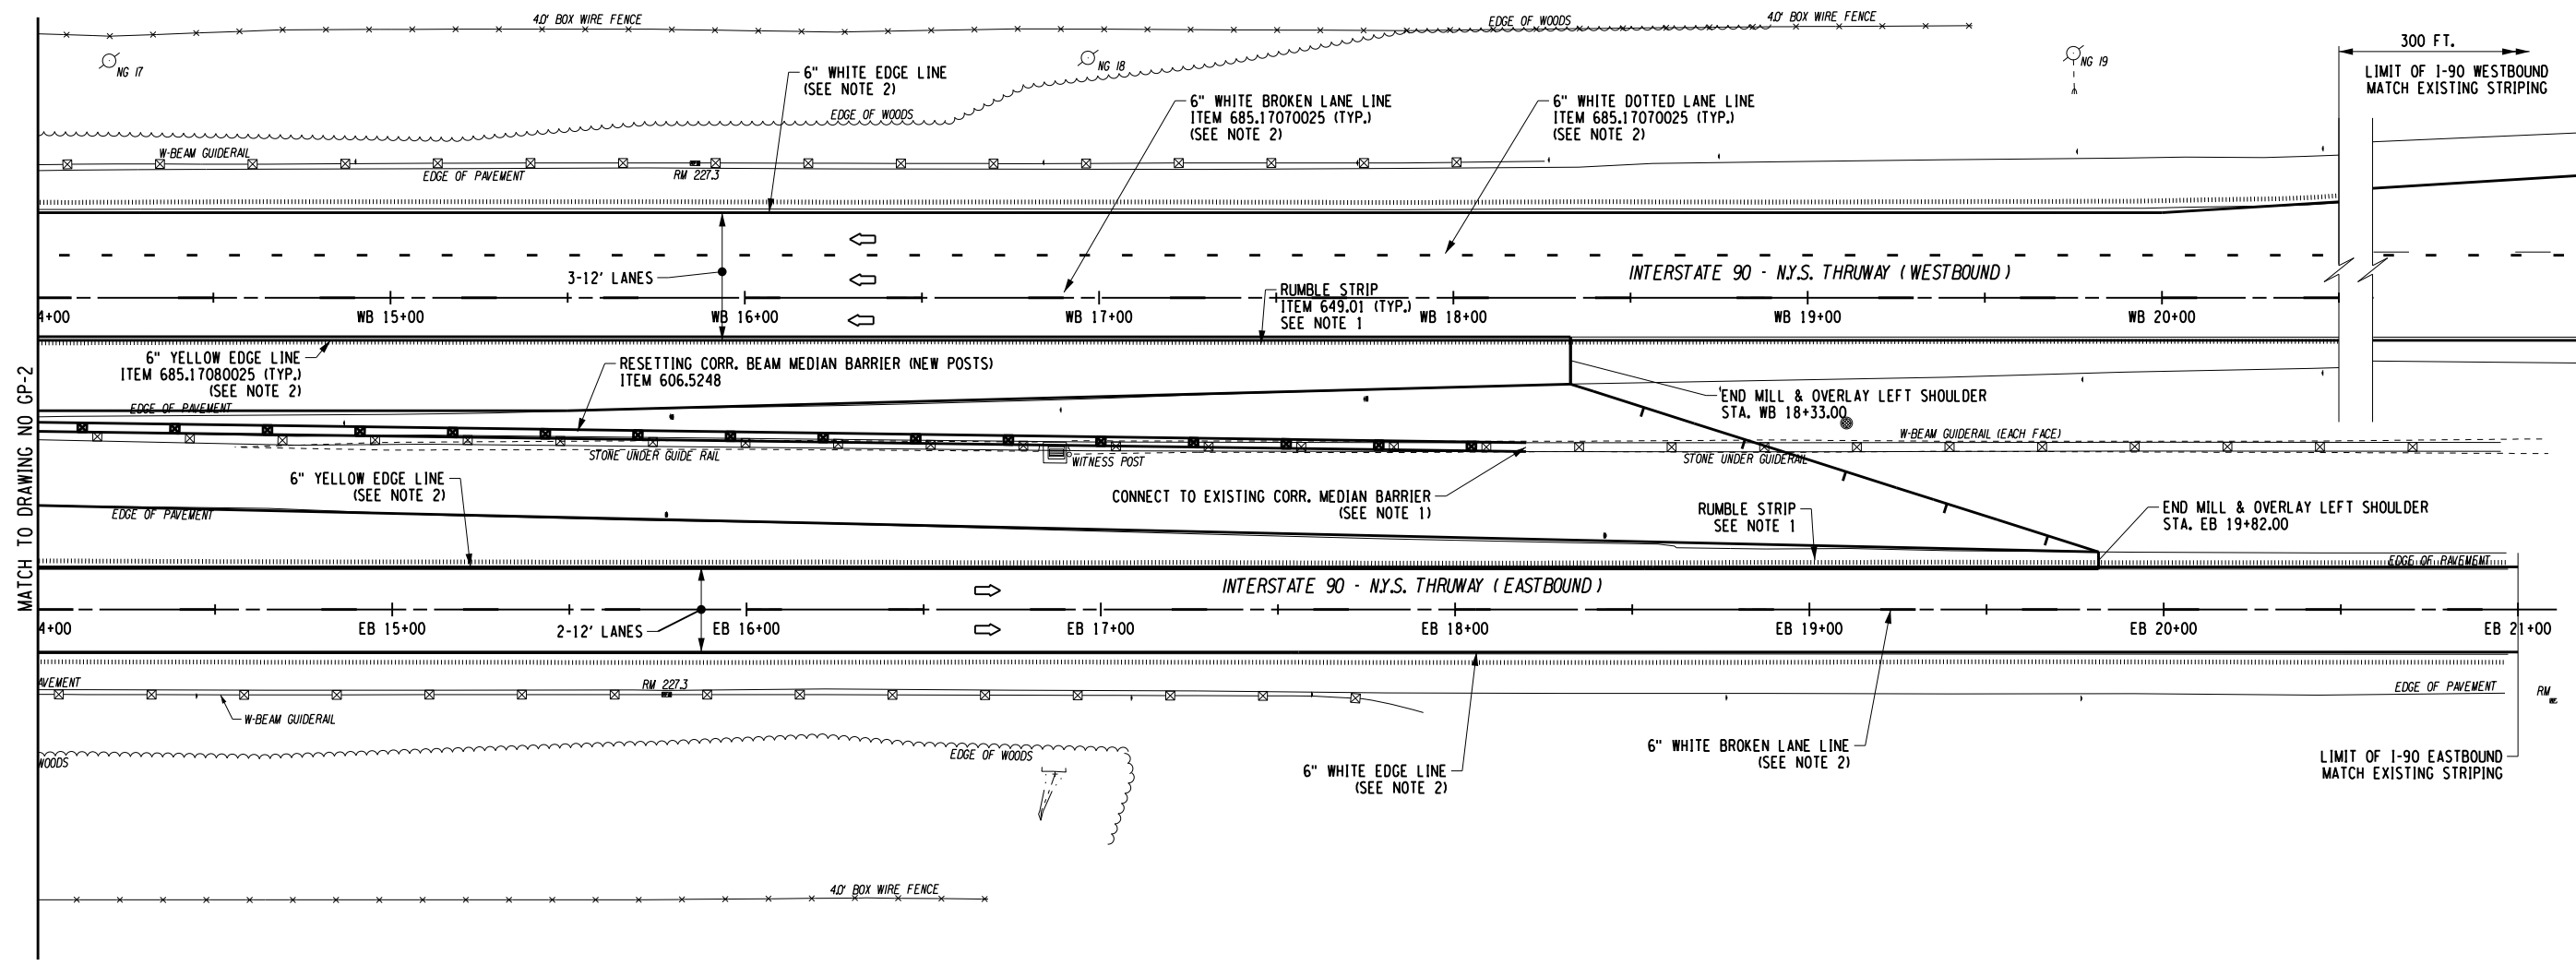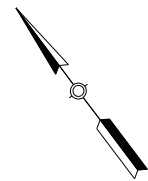

NOTES:

- REFER TO NYS DOT STANDARD SHEET 649-02 FOR DETAILS OF MILLED IN AUDIBLE ROADWAY DELINEARS (MIARDS).
- UNLESS OTHERWISE NOTED, ALL MAINLINE PAVEMENT MARKINGS SHALL BE HIGHLY REFLECTORIZED TRIPLE DROP EPOXY PAVEMENT STRIPES, INCLUDING RIGHT AND LEFT EDGE LINES & BROKEN LANE LINES.
- SEE DWG. NO. MT-1 FOR GUIDERAIL TABLE & REFERENCE MARKER TABLE

ALTERED ON:	AFFIXED ON: 12/04/2023
SIGNATURE: STAMP:	SIGNATURE: STAMP:

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REVISIONS			
DATE	DESCRIPTION	BY	SYM.

TITLE OF PROJECT STERLING CREEK BRIDGE REHABILITATION	CONTRACT NUMBER: TAS 24-5B
LOCATION OF PROJECT SYRACUSE DIVISION BIN 5516091 & 5516092 MP 227.40 & MP 227.41	DATE: NOV. 2023
TITLE OF DRAWING GENERAL PLAN	DRAWING NUMBER: GP-3

GENERAL NOTES:

- 1. MATERIAL AND CONSTRUCTION SPECIFICATIONS: NEW YORK STATE DEPARTMENT OF TRANSPORTATION STANDARD SPECIFICATIONS (U.S. CUSTOMARY) DATED AS SHOWN ON THE FRONT COVER OF THE PROPOSAL EXCEPT AS MODIFIED IN THESE PLANS AND THE PROPOSAL.
- 2. UNLESS OTHERWISE NOTED ALL ITEM NUMBERS FOR SPECIFIC WORK TASKS RELATE TO THE NEW YORK STATE STANDARD SPECIFICATIONS.
- 3. THE CONTRACTOR SHALL EXAMINE AND VERIFY IN THE FIELD ALL EXISTING AND GIVEN CONDITIONS, ELEVATIONS AND DIMENSIONS SHOWN ON THE PLANS. IF FIELD CONDITIONS AND DIMENSIONS DIFFER FROM THOSE SHOWN ON THE PLANS, THE CONTRACTOR SHALL MAKE APPROPRIATE CHANGES TO THOSE SHOWN ON THE PLANS, AS APPROVED BY THE ENGINEER. ALL FIELD CONDITIONS AND DIMENSIONS SHALL BE NOTED ON THE AS-BUILT DRAWINGS SUBMITTED FOR APPROVAL.
- 4. THERE SHALL BE NO CLAIM MADE BY THE CONTRACTOR FOR WORK PERTAINING TO SUCH MODIFICATIONS AS MAY BE REQUIRED DUE TO DIFFERENCES BETWEEN ACTUAL FIELD CONDITIONS AND THOSE SHOWN BY THE DETAILS AND DIMENSIONS ON THE PLANS.
- 5. THE CONTRACTOR SHOULD NOTE THAT ADDITIONAL WORK, NOT SHOWN OR NOTED ON THE PLANS, MAY BE REQUIRED AS THE CONTRACT PROGRESSES. THIS WORK SHALL BE PERFORMED BY THE CONTRACTOR AS ORDERED BY THE ENGINEER AND PAYMENT WILL BE BY THE UNIT PRICE BID FOR THE APPROPRIATE ITEM.
- 6. NO ADDITIONAL PAYMENT SHALL BE MADE FOR WORK CALLED FOR BY NOTES ON THE PLAN, IN THE SPECIFICATIONS, OR UNDER THE HEADING "GENERAL NOTES" UNLESS PAYMENT IS SPECIFICALLY INDICATED BY ITEM NUMBER. THE COST OF WORK FOR WHICH NO PAYMENT IS INDICATED SHALL BE INCLUDED IN THE LUMP UNIT BID PRICE FOR THE VARIOUS ITEMS IN THE CONTRACT.
- 7. THE CONTRACTOR SHALL PERFORM ALL WORK WITH CARE SO THAT ANY MATERIALS WHICH ARE TO REMAIN THE PROPERTY OF THE AUTHORITY WILL NOT BE DAMAGED. IF THE CONTRACTOR DAMAGES ANY MATERIALS WHICH ARE TO REMAIN THE PROPERTY OF THE SAID AGENCIES, THE DAMAGED MATERIALS SHALL BE REPAIRED OR REPLACED AT THE EXPENSE OF THE CONTRACTOR IN A MANNER SATISFACTORY TO THE ENGINEER.
- 8. THE CONTRACTOR IS ADVISED THAT ADDITIONAL NOTES WILL BE FOUND ON SUBSEQUENT SHEETS OF THE PLANS AND SUCH NOTES, WHILE PERTAINING TO THE SPECIFIC DRAWINGS THEY ARE PLACED ON, ALSO SUPPLEMENT THE GENERAL NOTES LISTED HEREIN.
- 9. WHENEVER ITEMS IN THE CONTRACT REQUIRE MATERIALS TO BE REMOVED AND DISPOSED OF, THE COST OF SUPPLYING THE DISPOSAL AREA AND OF TRANSPORTATION TO THAT AREA SHALL BE INCLUDED IN THE BID PRICE FOR THESE ITEMS.
- 10. THE CONTRACTOR SHALL PROVIDE ALL TEMPORARY SUPPORTS, BRACING OR OTHER DEVICES THAT MAY BE REQUIRED, OR THAT MAY BE DIRECTED BY THE ENGINEER, TO PROTECT THE SAFETY OF ADJACENT STRUCTURES, ROADWAYS OR UTILITIES. THE COST OF THIS WORK SHALL BE INCLUDED IN THE UNIT BID PRICE FOR THE VARIOUS ITEMS IN THE CONTRACT AND NO SEPARATE PAYMENT SHALL BE MADE.
- 11. THE METHOD OF REMOVAL OF EXISTING ROADWAY OR SHOULDER PAVEMENT IN THE IMMEDIATE VICINITY OF ANY UNDERGROUND UTILITIES, INCLUDING CROSS-CULVERTS, SHALL BE REVIEWED WITH THE ENGINEER PRIOR TO COMMENCEMENT OF WORK.
- 12. THE CONTRACTOR SHALL BE RESPONSIBLE FOR GUARDING AND PROTECTING ALL OPEN EXCAVATIONS IN ACCORDANCE WITH THE PROVISION OF SECTION 107-05 (SAFETY AND HEALTH REQUIREMENTS) OF THE NYS DOT STANDARD SPECIFICATIONS.
- 13. IF THE ENGINEER NOTIFIES THE CONTRACTOR OF ANY HAZARDOUS CONSTRUCTION PRACTICES, ALL OPERATIONS IN THE AFFECTED AREA SHALL BE DISCONTINUED AND IMMEDIATE ACTION SHALL BE TAKEN TO CORRECT THE SITUATION TO THE SATISFACTION OF THE ENGINEER BEFORE WORK IS RESUMED.
- 14. ALL EXISTING SIGNS SHALL BECOME THE PROPERTY OF THE NYSTA.
- 15. TWO WEEKS PRIOR TO COMMENCEMENT OF ANY WORK, THE CONTRACTOR SHALL SUBMIT A PROPOSED CONSTRUCTION SEQUENCE TO THE ENGINEER FOR APPROVAL.
- 16. FIELD CONDITIONS MAY REQUIRE ADDITIONAL FULL DEPTH REPLACEMENT AREAS NOT SHOWN ON PLANS. THIS WORK WILL BE A.O.B.E. AND WILL BE PAID FOR UNDER THE APPROPRIATE UNIT BID PRICE ITEMS IN THE CONTRACT.
- 17. ALL WORK SHALL BE DONE IN STRICT COMPLIANCE WITH ALL APPLICABLE NATIONAL, STATE, AND LOCAL CODES, STANDARDS, ORDINANCES, RULES, AND REGULATIONS.
- 18. THE CONTRACTOR SHALL MAINTAIN THE INTEGRITY OF EXISTING EDGE OF PAVEMENT ALONG ALL RIGHTS-OF-WAY.

GENERAL NOTES CONT.:

- 19. ALL CONSTRUCTION WORK SHALL BE PERFORMED IN ACCORDANCE WITH ALL APPLICABLE SAFETY CODES. THE CONTRACTOR SHALL HAVE A COMPETENT PERSON TRAINED IN SAFETY ON SITE DURING THE PROGRESSION OF ALL CONSTRUCTION ACTIVITIES. APPLICABLE SAFETY CODES MEAN THE LATEST EDITION INCLUDING ANY AND ALL AMENDMENTS, REVISIONS, AND ADDITIONS THERE TO, TO THE FEDERAL DEPARTMENT OF LABOR, OCCUPATIONAL SAFETY AND HEALTH ADMINISTRATION'S OCCUPATIONAL SAFETY AND HEALTH STANDARDS (OSHA); AND APPLICABLE SAFETY, HEALTH REGULATIONS AND BUILDING CODES FOR CONSTRUCTION IN THE STATE OF NEW YORK. SHEET PILING SHALL BE DESIGNED AND SEALED BY A NEW YORK STATE PROFESSIONAL ENGINEER.
- 20. SUBMITTALS, CATALOG CUTS, SAMPLES, AND SHOP DRAWINGS MUST BE RECEIVED, REVIEWED AND APPROVED BY THE ENGINEER PRIOR TO ORDERING OR FABRICATION OF MATERIALS AND PRIOR TO INSTALLATION OF MATERIALS. FAILURE TO DO SO MAY RESULT IN TIME DELAYS. THE CONTRACTOR WILL NOT BE ENTITLED TO COMPENSATION FOR SAID TIME DELAYS, REMOVALS, OR REPLACEMENTS.
- 21. THE CONTRACTOR'S ATTENTION IS DIRECTED TO THE FACT THAT, DUE TO THE NATURE OF RECONSTRUCTION PROJECTS, THE EXACT EXTENT OF CONSTRUCTION WORK CANNOT ALWAYS BE ACCURATELY DETERMINED PRIOR TO THE COMMENCEMENT OF WORK. THESE CONTRACT DOCUMENTS HAVE BEEN PREPARED BASED ON FIELD INSPECTION AND OTHER INFORMATION AVAILABLE AT THE TIME. ACTUAL FIELD CONDITIONS MAY REQUIRE MODIFICATIONS TO CONSTRUCTION DETAILS AND WORK QUANTITIES. THE CONTRACTOR SHALL PERFORM WORK IN ACCORDANCE WITH FIELD CONDITIONS.
- 22. THE CONTRACTOR SHALL PROVIDE AN ACI CERTIFIED CONCRETE FLAT WORK FINISHER TO SUPERVISE ALL HAND FINISHING PER THE STANDARD SPECIFICATION. CERTIFICATION SHALL BE PROVIDED TO THE ENGINEER.
- 23. DESIGN SPECIFICATIONS: NYS DOT LRFD BRIDGE DESIGN SPECIFICATIONS WITH ALL PROVISIONS IN EFFECT AS OF SEPTEMBER 2023 (FOR DESIGN PURPOSES, COMPRESSIVE STRENGTH OF CONCRETE FOR SUBSTRUCTURES AND DECK SLABS AT 28 DAYS: $f'c = 3,000 \text{ psi}$)
- 24. DESIGN LIVE LOAD: HS 20
- 25. CONCRETE DATA: THE MINIMUM CONCRETE COMPRESSIVE STRENGTH SHALL BE 3,000 PSI AT 28 DAYS.
- 26. REINFORCING DATA: ALL NEW AND REPLACEMENT BAR REINFORCEMENT SHALL BE ASTM A 615 GRADE 60. BARS SHALL BE GALVANIZED AND FABRICATED IN ACCORDANCE WITH ASTM A 767, AND MEET THE REQUIREMENTS OF NYS DOT MATERIAL SPECIFICATIONS.
- 27. RECORD PLANS: RECORD PLANS COVERING PREVIOUS WORK WILL BE AVAILABLE AS SUPPLEMENTAL FOR REVIEW BY ALL PROSPECTIVE BIDDERS AT THE AUTHORITY'S WEBSITE PRIOR TO THE LETTING DATE; REFER TO CONTRACT M.T. 52-7, TAS87-16BP, TAS92-74B, TAS06-42, TAS08-33BP, TAS16-11, TAS-13B, TAS17-25B.
- 28. THE CONTRACTOR'S ATTENTION IS DIRECTED TO THE FACT THAT NO SPOIL AREA FOR SURPLUS MATERIAL IS AVAILABLE FOR THIS CONTRACT WITHIN THE AUTHORITY'S RIGHT-OF-WAY. THEREFORE, ALL MATERIAL TO BE REMOVED FROM THE JOB SITE SHALL BE DISPOSED OF BY THE CONTRACTOR OFF THE AUTHORITY'S PROPERTY IN ACCORDANCE WITH ALL STATE, FEDERAL, AND LOCAL LAWS. ALL COSTS ASSOCIATED WITH THE SPOIL AREA AND REMOVAL OF SPOIL MATERIAL SHALL BE INCLUDED IN THE VARIOUS ITEMS OF THE CONTRACT.
- 29. DETAILS ON THE DRAWINGS LABELED AS "NOT TO SCALE" ARE INTENTIONALLY DRAWN NOT TO SCALE FOR VISUAL CLARITY. ALL OTHER DETAILS FOR WHICH NO SCALE IS SHOWN ARE DRAWN PROPORTIONALLY AND ARE FULLY DIMENSIONED.
- 30. ALL SHOP DRAWINGS FOR THIS PROJECT SHALL BE PREPARED IN U.S. CUSTOMARY UNITS.
- 31. THE COST OF WATER USED FOR COMPACTION OF THE SELECT STRUCTURAL FILL SHALL BE INCLUDED IN THE UNIT PRICE BID FOR ITEM 203.21 - SELECT STRUCTURE FILL.
- 32. THE COST OF ALL MATERIALS AT EACH CONSTRUCTION JOINT, CONTRACTION JOINT AND CONCRETE EXPANSION JOINT SHALL BE INCLUDED IN THE UNIT PRICES BID FOR THE VARIOUS ITEMS OF THE CONTRACT, UNLESS OTHERWISE SPECIFIED ON THE PLANS.
- 33. THE LOAD RATINGS ARE IN ACCORDANCE WITH THE AASHTO MANUAL FOR BRIDGE EVALUATION.
- 34. THIS BRIDGE SHALL BE MAINTAINED IN ACCORDANCE WITH THE GUIDELINES CONTAINED IN THE CURRENT VERSION OF THE AASHTO MAINTENANCE MANUAL FOR ROADWAYS AND BRIDGES.
- 35. THE CONTRACTOR SHALL HAVE AN ENGINEER LICENSED IN THE STATE OF NEW YORK PREPARE AND STAMP A SET OF PLANS AND ALL CALCULATIONS FOR THE FOLLOWING WORK:
 - DEMOLITION AND REMOVAL OF STRUCTURES
 - SUPERSTRUCTURE SUPPORT AND BEARING PLACEMENT
 - LATERAL STABILITY AND LATERAL, VERTICAL, AND TORSIONAL STRENGTH OF GIRDERS AND TEMPORARY SUPPORTS AT ANY CANTILEVERED SLABS DURING ANY STAGE OF CONSTRUCTION.

GENERAL NOTES CONT.:

- 38. WHEN JOINING FRESH CONCRETE TO NEW CONCRETE WHICH HAS ALREADY SET, OR TO EXISTING CONCRETE, THE CONCRETE IN PLACE SHALL HAVE ITS SURFACE SCAURED OR ABRADED WITH A SUITABLE TOOL TO REMOVE ALL LOOSE AND FOREIGN MATERIALS. THIS SURFACE SHALL BE SCRUBBED WITH WIRE BROOMS. AFTER THE SURFACE PREPARATION HAS BEEN ACCEPTED, THIS SURFACE SHALL BE THOROUGHLY WET AND KEPT SO FOR A PERIOD OF 12 HOURS IMMEDIATELY PRIOR TO PLACING THE NEW CONCRETE. THIS MAY BE ACCOMPLISHED BY CONTINUOUS WETTING WITH SOAKER HOSES OR THE USE OR BURLAP/BURLENE/ETC. SO THAT MOISTURE CAN BE MAINTAINED. IF, IN THE OPINION OF THE ENGINEER, CONDITIONS OR THE SITUATION PROHIBITS THIS, THEN THE SURFACES SHALL BE WETTED FOR AS LONG AS POSSIBLE AT THE DISCRETION OF THE ENGINEER. THE CONTRACTOR SHALL REMOVE ANY PUDDLES OR FREE STANDING WATER WITH OIL-FREE COMPRESSED AIR, AND PROTECT THE SURFACES FROM DRYING, SO THAT THE EXISTING CONCRETE REMAINS IN A CLEAN, SATURATED, SURFACE DRY CONDITION UNTIL PLACEMENT OF THE NEW CONCRETE. IMMEDIATELY BEFORE PLACING THE NEW CONCRETE, THE FORMS SHALL BE DRAWN TIGHT AGAINST THE CONCRETE ALREADY IN PLACE.
- 39. ALL METAL REINFORCING BAR CHAIRS AND SUPPORTS SHALL HAVE PLASTIC SHOES.
- 40. WHEN "PULL-OUT-TESTING" IS REQUIRED FOR ANCHOR BOLTS OR REINFORCING STEEL BARS DRILLED AND GROUTED INTO NEW OR EXISTING CONCRETE, THE BOLTS/BARS SHALL BE REQUIRED TO WITHSTAND A TENSILE FORCE OF NOT LESS THAN 150% OF THE DESIGN TENSILE LOAD WITHOUT DAMAGE TO THE CONCRETE.

SUBSTRUCTURE NOTES:

- 1. ALL EXPOSED EDGES OF CONCRETE ARE TO BE CHAMFERED 1 INCH UNLESS OTHERWISE NOTED.
- 2. ALL PLACEMENTS OF SELECT STRUCTURAL FILL, ITEM 203.21, SHALL BE COMPACTED TO 95 PERCENT OF STANDARD PROCTOR MAXIMUM DENSITY.
- 3. PROTECTIVE SEALING OF NEW STRUCTURAL CONCRETE, ITEM 559.02, (A CLEAR PENETRATING SEALER) SHALL BE APPLIED TO ALL NEW EXPOSED CONCRETE SURFACES OF THE SUBSTRUCTURES. PROTECTIVE SEALING OF EXISTING STRUCTURAL CONCRETE AND EXISTING BRIDGE DECK, ITEM 559.03, (A CLEAR PENETRATING SEALER) SHALL BE APPLIED TO ALL OTHER EXPOSED CONCRETE SURFACES OF THE SUBSTRUCTURES.
- 4. THE CONTRACTOR, WITH THE PERMISSION OF THE NYSTA, MAY ELECT TO INTRODUCE CONSTRUCTION JOINTS IN THE ABUTMENTS AT LOCATIONS NOT SHOWN ON THE PLANS. THESE CONSTRUCTION JOINTS SHALL BE PROVIDED WITH SHEAR KEYS AND WATERSTOPS. VERTICAL CONSTRUCTION JOINTS INTRODUCED IN THE BACKWALL SHOULD PREFERABLY BE PLACED MIDWAY BETWEEN THE PEDESTALS.

SUPERSTRUCTURE NOTES:

- 1. WELDING: ALL WELDING SHALL CONFORM TO THE LATEST VERSION OF THE NEW YORK STATE STEEL CONSTRUCTION MANUAL UNLESS OTHERWISE NOTED.
- 2. ALL DECK FORMS USED SHALL BE EITHER REMOVABLE FORMS OR STAY-IN-PLACE (SIP) FORMS. SIP FORMS AND SUPPORTS SHALL CONFORM TO ASTM A653, GRADE A THRU E. COATING DESIGNATION G235. FABRICATION SHALL BE IN CONFORMANCE WITH ASTM A924.
- 3. ALL LONGITUDINAL AND TRANSVERSE TOP MAT DECK REINFORCING STEEL SHALL BE STAGGERED 1/2 SPACE ABOVE BOTTOM MAT STEEL, UNLESS NOTED OTHERWISE ON THE DETAILS.
- 4. IT WILL BE THE CONTRACTOR'S RESPONSIBILITY TO DETERMINE AND ADVISE THE AUTHORITY OF THE TYPE, SIZE, AND WEIGHT OF ALL VEHICLES THEY INTEND TO USE ON THE STRUCTURE DURING CONSTRUCTION BASED ON THE CONDITION OF THE EXISTING STRUCTURE. THIS DETERMINATION SHALL BE MADE BY A PROFESSIONAL ENGINEER LICENSED IN THE STATE OF NEW YORK EMPLOYED AND PAID BY THE CONTRACTOR.

THE DETERMINATION BY THIS PROFESSIONAL ENGINEER IS TO BE SUBMITTED TO THE AUTHORITY 14 DAYS PRIOR TO THE USE OF ANY VEHICLES ON THE STRUCTURE WITH ALL RESTRICTIONS ENUMERATED BEING STRICTLY ADHERED TO.

IN THE EVENT THAT THE CONTRACTOR/SUBCONTRACTOR FAILS TO COMPLY WITH THE INSTRUCTIONS OF THE PROFESSIONAL ENGINEER FOR THE USE OF ANY VEHICLE, THE WORK WILL BE IMMEDIATELY SUSPENDED UNTIL CORRECTIVE PROCEDURES SATISFACTORY TO THE PROFESSIONAL ENGINEER AND THE AUTHORITY ARE EMPLOYED.
- 5. PROTECTIVE SEALING OF STRUCTURAL CONCRETE ON NEW BRIDGE DECKS, ITEM 559.01, SHALL BE APPLIED TO ALL EXPOSED CONCRETE SURFACES OF THE STRUCTURAL DECK AND BARRIER. ONLY PENETRATING TYPE SEALER AS INDICATED IN THE SPECIFICATION SHALL BE USED.

SHEET NUMBER	DESCRIPTION	DRAWING NUMBER
46	GENERAL NOTES & INDEX(1 OF 2)	ST-1
47	GENERAL NOTES (2 OF 2)	ST-2
48	EXISTING PLAN AND ELEVATION	ST-3
49	PROPOSED PLAN AND ELEVATION	ST-4
50	EXISTING AND PROPOSED TRANSVERSE SECTIONS	ST-5
51	PROPOSED PROFILE (EASTBOUND)	ST-6
52	PROPOSED PROFILE (WESTBOUND)	ST-7
53	EXCAVATION PLAN AND SECTION	ST-8
54	BEGIN ABUTMENT DEMOLITION PLAN AND ELEVATION (EASTBOUND)	ST-9
55	BEGIN ABUTMENT DEMOLITION PLAN AND ELEVATION (WESTBOUND)	ST-10
56	BEGIN ABUTMENT PROPOSED PLAN AND ELEVATION (EASTBOUND)	ST-11
57	BEGIN ABUTMENT PROPOSED PLAN AND ELEVATION (WESTBOUND)	ST-12
58	BEGIN ABUTMENT DETAILS	ST-13
59	END ABUTMENT DEMOLITION PLAN AND ELEVATION (EASTBOUND)	ST-14
60	END ABUTMENT DEMOLITION PLAN AND ELEVATION (WESTBOUND)	ST-15
61	END ABUTMENT PROPOSED PLAN AND ELEVATION (EASTBOUND)	ST-16
62	END ABUTMENT PROPOSED PLAN AND ELEVATION (WESTBOUND)	ST-17
63	END ABUTMENT DETAILS	ST-18
64	ABUTMENT REPAIR DETAILS	ST-19
65	DECK SLAB PLAN (EASTBOUND)	ST-20
66	APPROACH SLAB PLAN (EASTBOUND)	ST-21
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68	APPROACH SLAB PLAN (WESTBOUND)	ST-23
69	DECK SLAB DETAILS	ST-24
70	SLEEPER SLAB DETAILS	ST-25
71	BEARING DETAILS - FIXED	ST-26
72	BEARING DETAILS - EXPANSION	ST-27
73	BEARING DETAILS - MISCELLANEOUS	ST-28
74	PROPOSED TRANSVERSE SECTION	ST-29
75	STEEL DETAILS	ST-30
76	HAUNCH TABLE (EASTBOUND)	ST-31
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78	MOMENT AND SHEAR & DESIGN LOAD TABLES	ST-33
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80	RAILING DETAILS (1 OF 2)	ST-35
81	RAILING DETAILS (2 OF 2)	ST-36
82	APPROACH DRAINAGE BEGIN ABUTMENT (EASTBOUND)	ST-37
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84	APPROACH DRAINAGE AND CURB LAYOUT TYPICAL DETAILS	ST-39
85	BAR BENDING DIAGRAM	ST-40
86	BAR LIST (1 OF 2)	ST-41
87	BAR LIST (2 OF 2)	ST-42

ACCESS AND NOTIFICATION NOTES:


- 1. THE CONTRACTOR SHALL PROVIDE SAFE AND ADEQUATE ACCESS INTO OR THROUGH THE WORK SITE BY EMERGENCY VEHICLES AT ALL TIMES.
- 2. THE CONTRACTOR SHALL MAINTAIN ALL TRAFFIC IN ACCORDANCE WITH THE MANUAL ON UNIFORM TRAFFIC CONTROL DEVICES AND THE NYS SUPPLEMENT, AND EFFORTS SHALL BE COORDINATED WITH THE ENGINEER, AND/OR THE NEW YORK STATE THRUWAY AUTHORITY. TEMPORARY PAVEMENT SHALL BE PLACED WITHIN 48 HOURS OF COMPLETION OF EXCAVATION AND BACKFILL OPERATIONS WITHIN THE PAVEMENT LIMITS.

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DESIGNED BY: C. SICHAK
DESIGN SUPERVISOR: C. SICHAK

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IT IS A VIOLATION OF LAW FOR ANY PERSON, UNLESS THEY ARE ACTING UNDER THE DIRECTION OF A LICENSED PROFESSIONAL ENGINEER, ARCHITECT, LANDSCAPE ARCHITECT, OR LAND SURVEYOR, TO ALTER AN ITEM IN ANY WAY. IF AN ITEM BEARING THE STAMP OF A LICENSED PROFESSIONAL IS ALTERED, THE ALTERING ENGINEER, ARCHITECT, LANDSCAPE ARCHITECT, OR LAND SURVEYOR SHALL STAMP THE DOCUMENT AND INCLUDE THE NOTATION "ALTERED BY" FOLLOWED BY THEIR SIGNATURE. THE DATE OF SUCH ALTERATION, AND A SPECIFIC DESCRIPTION OF THE ALTERATION.

REVISIONS				
DATE	DESCRIPTION	BY	SYMBOL	



NEW YORK STATE OF OPPORTUNITY | Thruway Authority



ERDBMAN ANTHONY

TITLE OF PROJECT STERLING CREEK BRIDGE REHABILITATION	CONTRACT NUMBER: TAS 24-5B
LOCATION OF PROJECT SYRACUSE DIVISION BIN 5516091 & 5516092 MP 227.40 & MP 227.41	DATE: NOV. 2023
TITLE OF DRAWING GENERAL NOTES & INDEX (1 OF 2)	DRAWING NUMBER: ST-1

UTILITY NOTES:

1. LOCATION OF UTILITIES, PUBLIC AND/OR PRIVATE, INDICATED ON THE PLANS AS EXISTING AND/OR TO BE CONSTRUCTED ARE APPROXIMATE ONLY. THEIR EXACT LOCATION SHALL BE DETERMINED IN THE FIELD. ADDITIONAL UTILITY LINES, WHETHER ABANDONED OR IN SERVICE, MAY EXIST AND IT SHALL BE THE CONTRACTOR'S RESPONSIBILITY TO CONDUCT THEIR OPERATIONS, AND TAKE NECESSARY PRECAUTIONS SUCH THAT INTERFERENCE WITH OR DAMAGE TO THESE OR OTHER FACILITIES DURING THE COURSE OF CONSTRUCTION IS PREVENTED.
2. PRIOR TO CONSTRUCTION, THE CONTRACTOR SHALL CALL "UDIG NY" (1-800-962-7962) TO HAVE UNDERGROUND UTILITIES LOCATED.
3. IN THE EVENT THE CONTRACTOR DAMAGES AN EXISTING UTILITY SERVICE CAUSING AN INTERRUPTION IN SAID SERVICE, THEY SHALL IMMEDIATELY CONTACT SAID UTILITY AND IF NECESSARY, COMMENCE WORK TO RESTORE THAT SERVICE AT THEIR OWN EXPENSE. THEY MAY NOT CEASE THEIR WORK OPERATION UNTIL THAT SERVICE IS RESTORED. PLEASE NOTE THAT SOME UTILITIES REQUIRE DAMAGE REPAIRED BY THEIR OWN CREWS. THE CONTRACTOR SHALL THEN PROVIDE ANY PROVISIONS NECESSARY TO AID IN THIS RESTORATION.
4. THE QUALITY LEVEL OF THE UNDERGROUND UTILITY INFORMATION ON THE PLANS IS QUALITY LEVEL "C". FOUR SEPARATE QUALITY LEVELS OF SUBSURFACE UTILITY FACILITY INFORMATION ARE GENERALLY RECOGNIZED AND ARE AS FOLLOWS:
 - QUALITY LEVEL A (QLA): QUALITY LEVEL A IS THE HIGHEST DEGREE OF ACCURACY. THE INFORMATION SHOWN ON THE PLANS HAS BEEN OBTAINED BY THE ACTUAL EXPOSURE (OR VERIFICATION OF PREVIOUSLY EXPOSED AND SURVEYED UTILITY FACILITIES) OF SUBSURFACE UTILITIES, USING (TYPICALLY) MINIMALLY INTRUSIVE EXCAVATION EQUIPMENT TO DETERMINE THEIR PRECISE HORIZONTAL AND VERTICAL POSITIONS, AS WELL AS THEIR OTHER UTILITY FACILITY ATTRIBUTES. (SHOWN AS QLA)
 - QUALITY LEVEL B (QLB): QUALITY LEVEL B IS THE SECOND HIGHEST DEGREE OF ACCURACY. THE INFORMATION SHOWN ON THE PLANS HAS BEEN OBTAINED THROUGH THE APPLICATION OF APPROPRIATE SURFACE GEOPHYSICAL METHODS (I.E. UNDERGROUND CAMERAS, RADAR, SONAR, TONE QUITS, ETC.) TO IDENTIFY THE EXISTENCE AND APPROPRIATE HORIZONTAL POSITION OF SUBSURFACE UTILITY FACILITIES. QUALITY LEVEL B DATA ARE REPRODUCIBLE BY SURFACE GEOPHYSICS AT ANY POINT OF THEIR DESCRIPTION. THE INFORMATION WAS SURVEYED TO APPLICABLE TOLERANCES AND REDUCED ONTO THE PLANS. NO EXCAVATIONS WERE PERFORMED. (SHOWN AS QLB)
 - QUALITY LEVEL C (QLC): QUALITY LEVEL C IS THE THIRD HIGHEST DEGREE OF ACCURACY. THE INFORMATION SHOWN ON THE PLANS HAS BEEN OBTAINED BY SURVEYING AND PLOTTING VISIBLE ABOVE-GROUND UTILITY FEATURES AND BY USING PROFESSIONAL JUDGMENT IN CORRELATING THIS INFORMATION TO QUALITY LEVEL D INFORMATION. (SHOWN AS QLC)
 - QUALITY LEVEL D (QLD): QUALITY LEVEL D IS THE LOWEST DEGREE OF ACCURACY. THE INFORMATION SHOWN ON THE PLANS WAS DERIVED SOLELY FROM EXISTING NYS DOT AND/OR UTILITY COMPANY RECORDS OR RECOLLECTIONS. (SHOWN AS QLD)

REMOVAL, EXCAVATION, AND BACKFILL NOTES:

1. DURING REMOVAL OPERATIONS, THE CONTRACTOR SHALL NOT DROP WASTE CONCRETE, DEBRIS OR OTHER MATERIAL TO RAILROAD RIGHT-OF-WAY, RIVERS, AND ROADWAYS BELOW THE BRIDGE EXCEPT WHERE THE PLANS OR SPECIFICATIONS SPECIFICALLY PERMIT THE DROPPING OF MATERIAL. PLATFORMS, NETS, SCREENS, OR OTHER PROTECTIVE DEVICES SHALL BE USED TO CATCH THE MATERIAL. IF THE ENGINEER DETERMINES THAT ADEQUATE PROTECTIVE DEVICES ARE NOT BEING EMPLOYED, THE WORK SHALL BE SUSPENDED UNTIL ADEQUATE PROTECTION IS PROVIDED. IF MATERIAL FALLS ON THE AREA BELOW AND ADJACENT TO THE BRIDGE, IT SHALL BE REMOVED AND DISPOSED OF BY THE CONTRACTOR ON A DAILY BASIS.
2. THE COST OF FURNISHING, INSTALLING, MAINTAINING, REMOVING AND DISPOSING OF ALL PLATFORMS, NETS, SCREENS OR OTHER PROTECTIVE DEVICES SHALL BE INCLUDED IN THE UNIT BID PRICES OF THE APPROPRIATE ITEMS IN THE CONTRACT.
3. DEWATERING MAY BE REQUIRED FOR THE INSTALLATION OF NEW DRAINAGE FACILITIES AND THE CLEANING OF EXISTING DRAINAGE FACILITIES. THE COST OF DEWATERING IS TO BE INCLUDED IN THE VARIOUS DRAINAGE ITEMS. THE CONTRACTOR MUST OBTAIN THE REQUIRED PERMITS FROM THE NEW YORK STATE DEPARTMENT OF ENVIRONMENTAL CONSERVATION IF THE CONTRACTOR ELECTS TO USE WELL POINTS.
4. EXISTING SUBSTRUCTURE SHALL BE REMOVED WITHIN THE LIMITS SHOWN ON THE PLANS UNDER ITEM 580.01 IN THE BRIDGE ESTIMATE.
5. EXISTING DECK SHALL BE REMOVED UNDER ITEM 202.2201 IN THE BRIDGE ESTIMATE.
6. THE CONTRACTOR'S ATTENTION IS DIRECTED TO THE REQUIREMENTS OF SUBSECTION 202-3.01 GENERAL AND SAFETY REQUIREMENTS. A REMOVAL PLAN, SIGNED BY A REGISTERED PROFESSIONAL ENGINEER IN THE STATE OF NEW YORK, SHALL BE SUBMITTED TO THE ENGINEER THIRTY (30) DAYS PRIOR TO BEGINNING THE DEMOLITION.
7. REFER TO SUBSECTION 107-05 OF THE STANDARD SPECIFICATIONS FOR SAFETY AND HEALTH REQUIREMENTS.

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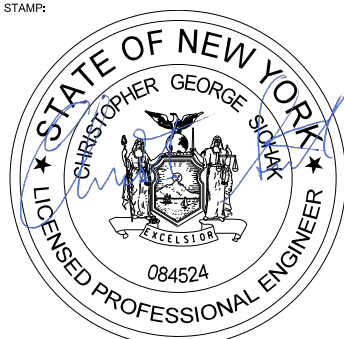
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DESIGNED BY: N. BARNHARD

DESIGN SUPERVISOR: C. SICHAK

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REVISIONS			
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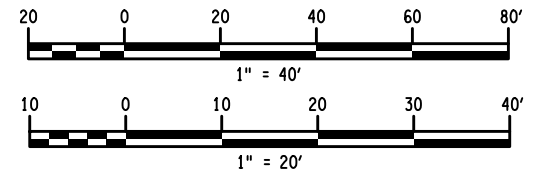
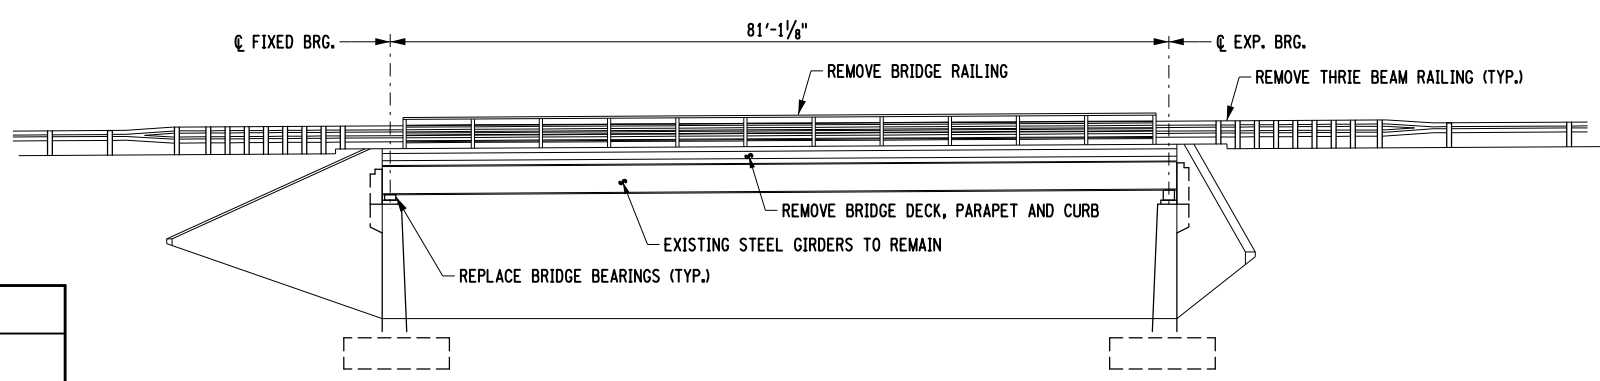
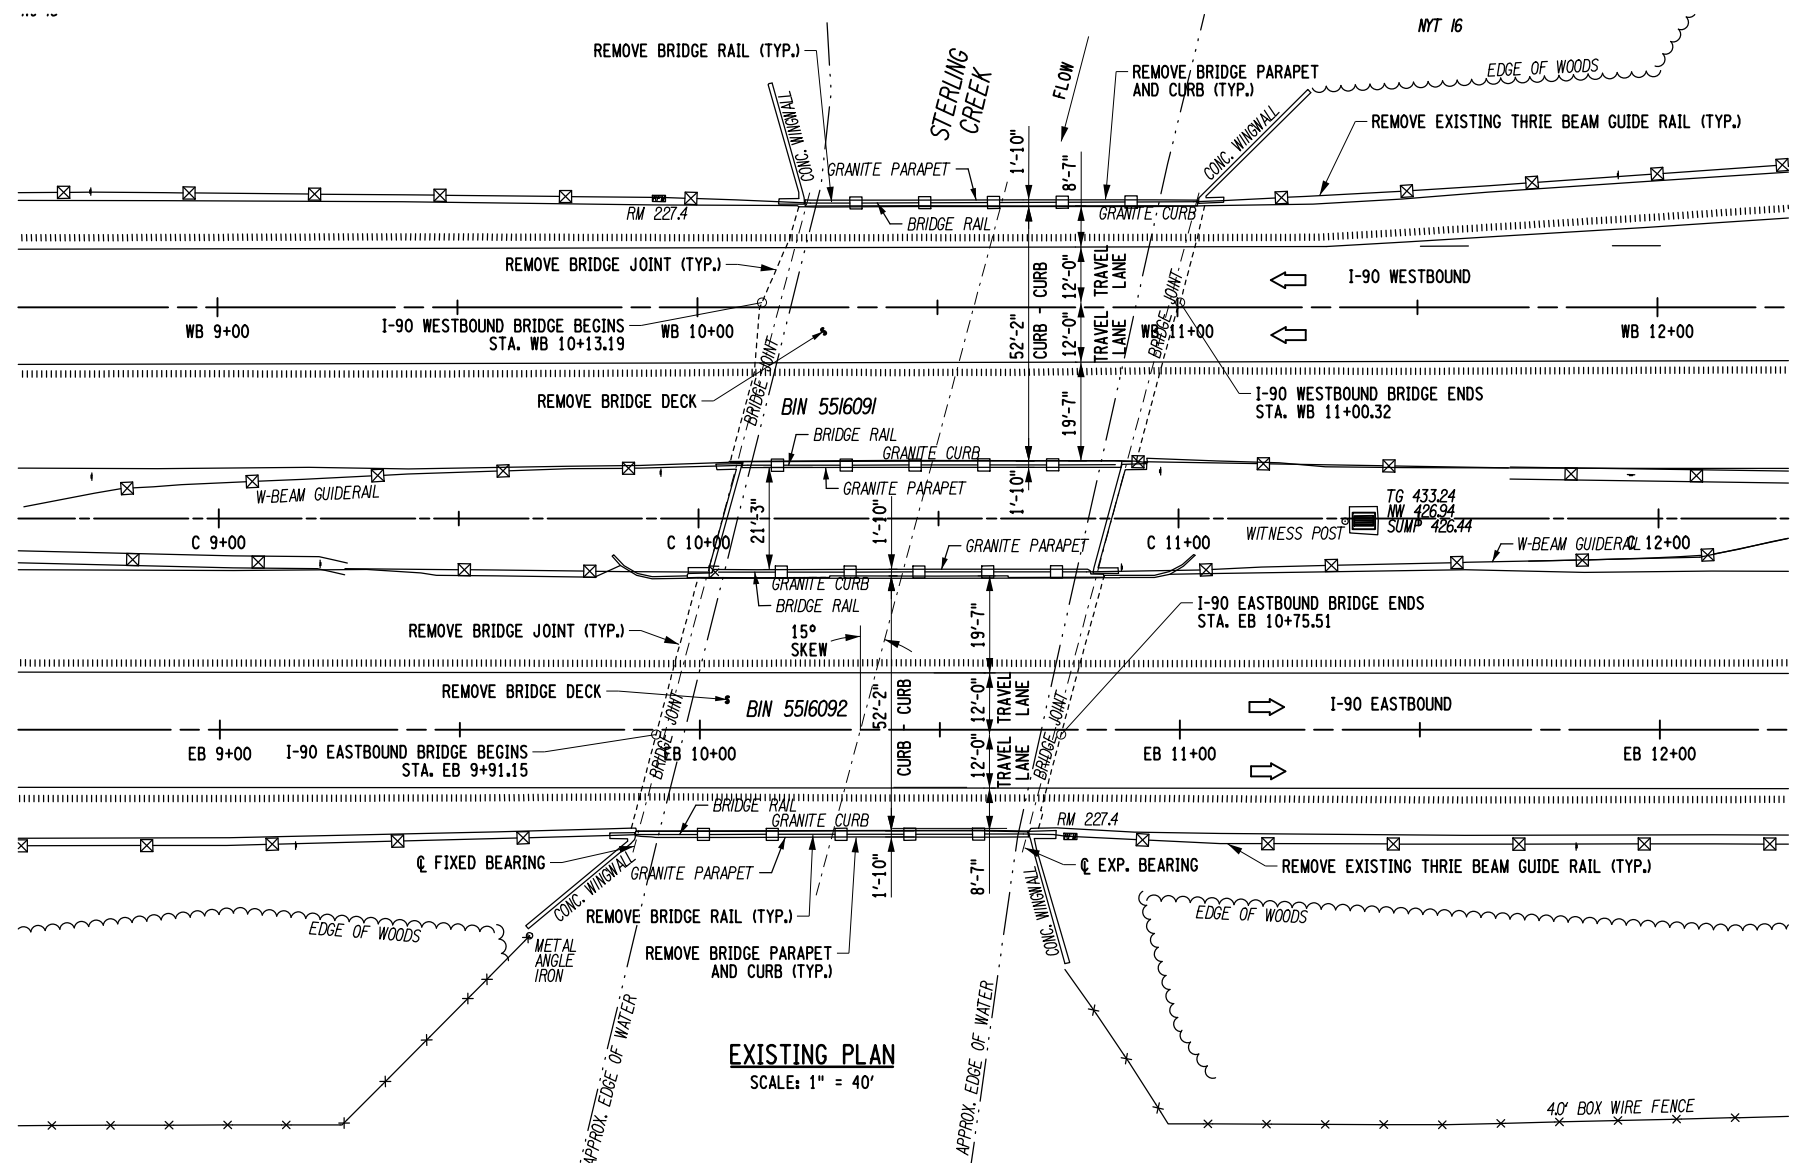
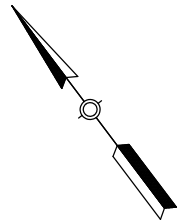
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TITLE OF PROJECT STERLING CREEK BRIDGE REHABILITATION	CONTRACT NUMBER: TAS 24-5B
LOCATION OF PROJECT SYRACUSE DIVISION BIN 5516091 & 5516092 MP 227.40 & MP 227.41	DATE: NOV. 2023
TITLE OF DRAWING GENERAL NOTES (2 OF 2)	DRAWING NUMBER: ST-2



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 CHECKED BY: T. LINDO
 DRAFTED BY: T. LINDO
 CHECKED BY: N. BARNHARD
 DESIGN SUPERVISOR: C. SICHAK

FILE NAME = B2221_cpb_gen-1.dgn
 DATE/TIME = 04-DEC-2023 15:20
 USER = L.lindo

ALTERED ON: SIGNATURE: STAMP:	AFFIXED ON: 12/04/2023 SIGNATURE: STAMP:

IT IS A VIOLATION OF LAW FOR ANY PERSON, UNLESS THEY ARE ACTING UNDER THE DIRECTION OF A LICENSED PROFESSIONAL ENGINEER, ARCHITECT, LANDSCAPE ARCHITECT, OR LAND SURVEYOR, TO ALTER AN ITEM IN ANY WAY. IF AN ITEM BEARING THE STAMP OF A LICENSED PROFESSIONAL IS ALTERED, THE ALTERING ENGINEER, ARCHITECT, LANDSCAPE ARCHITECT, OR LAND SURVEYOR SHALL STAMP THE DOCUMENT AND INCLUDE THE NOTATION "ALTERED BY" FOLLOWED BY THEIR SIGNATURE. THE DATE OF SUCH ALTERATION, AND A SPECIFIC DESCRIPTION OF THE ALTERATION.

REVISIONS			
DATE	DESCRIPTION	BY	SYM.

 Thruway Authority	TITLE OF PROJECT STERLING CREEK BRIDGE REHABILITATION LOCATION OF PROJECT SYRACUSE DIVISION BIN 5516091 & 5516092 MP 227.40 & MP 227.41 TITLE OF DRAWING EXISTING PLAN AND ELEVATION	CONTRACT NUMBER: TAS 24-5B DATE: NOV. 2023 DRAWING NUMBER: ST-3
	ERDMAN ANTHONY	

CHECKED BY: N. BARNHARD


DRAFTED BY: T. LINDO

CHECKED BY: N. BARNHARD


DESIGNED BY: C. SICHAK

15:20

FILE NAME = B2221_cpb_gen-2.dgn
DATE/TIME = 04-DEC-2023
USER = L.lindo

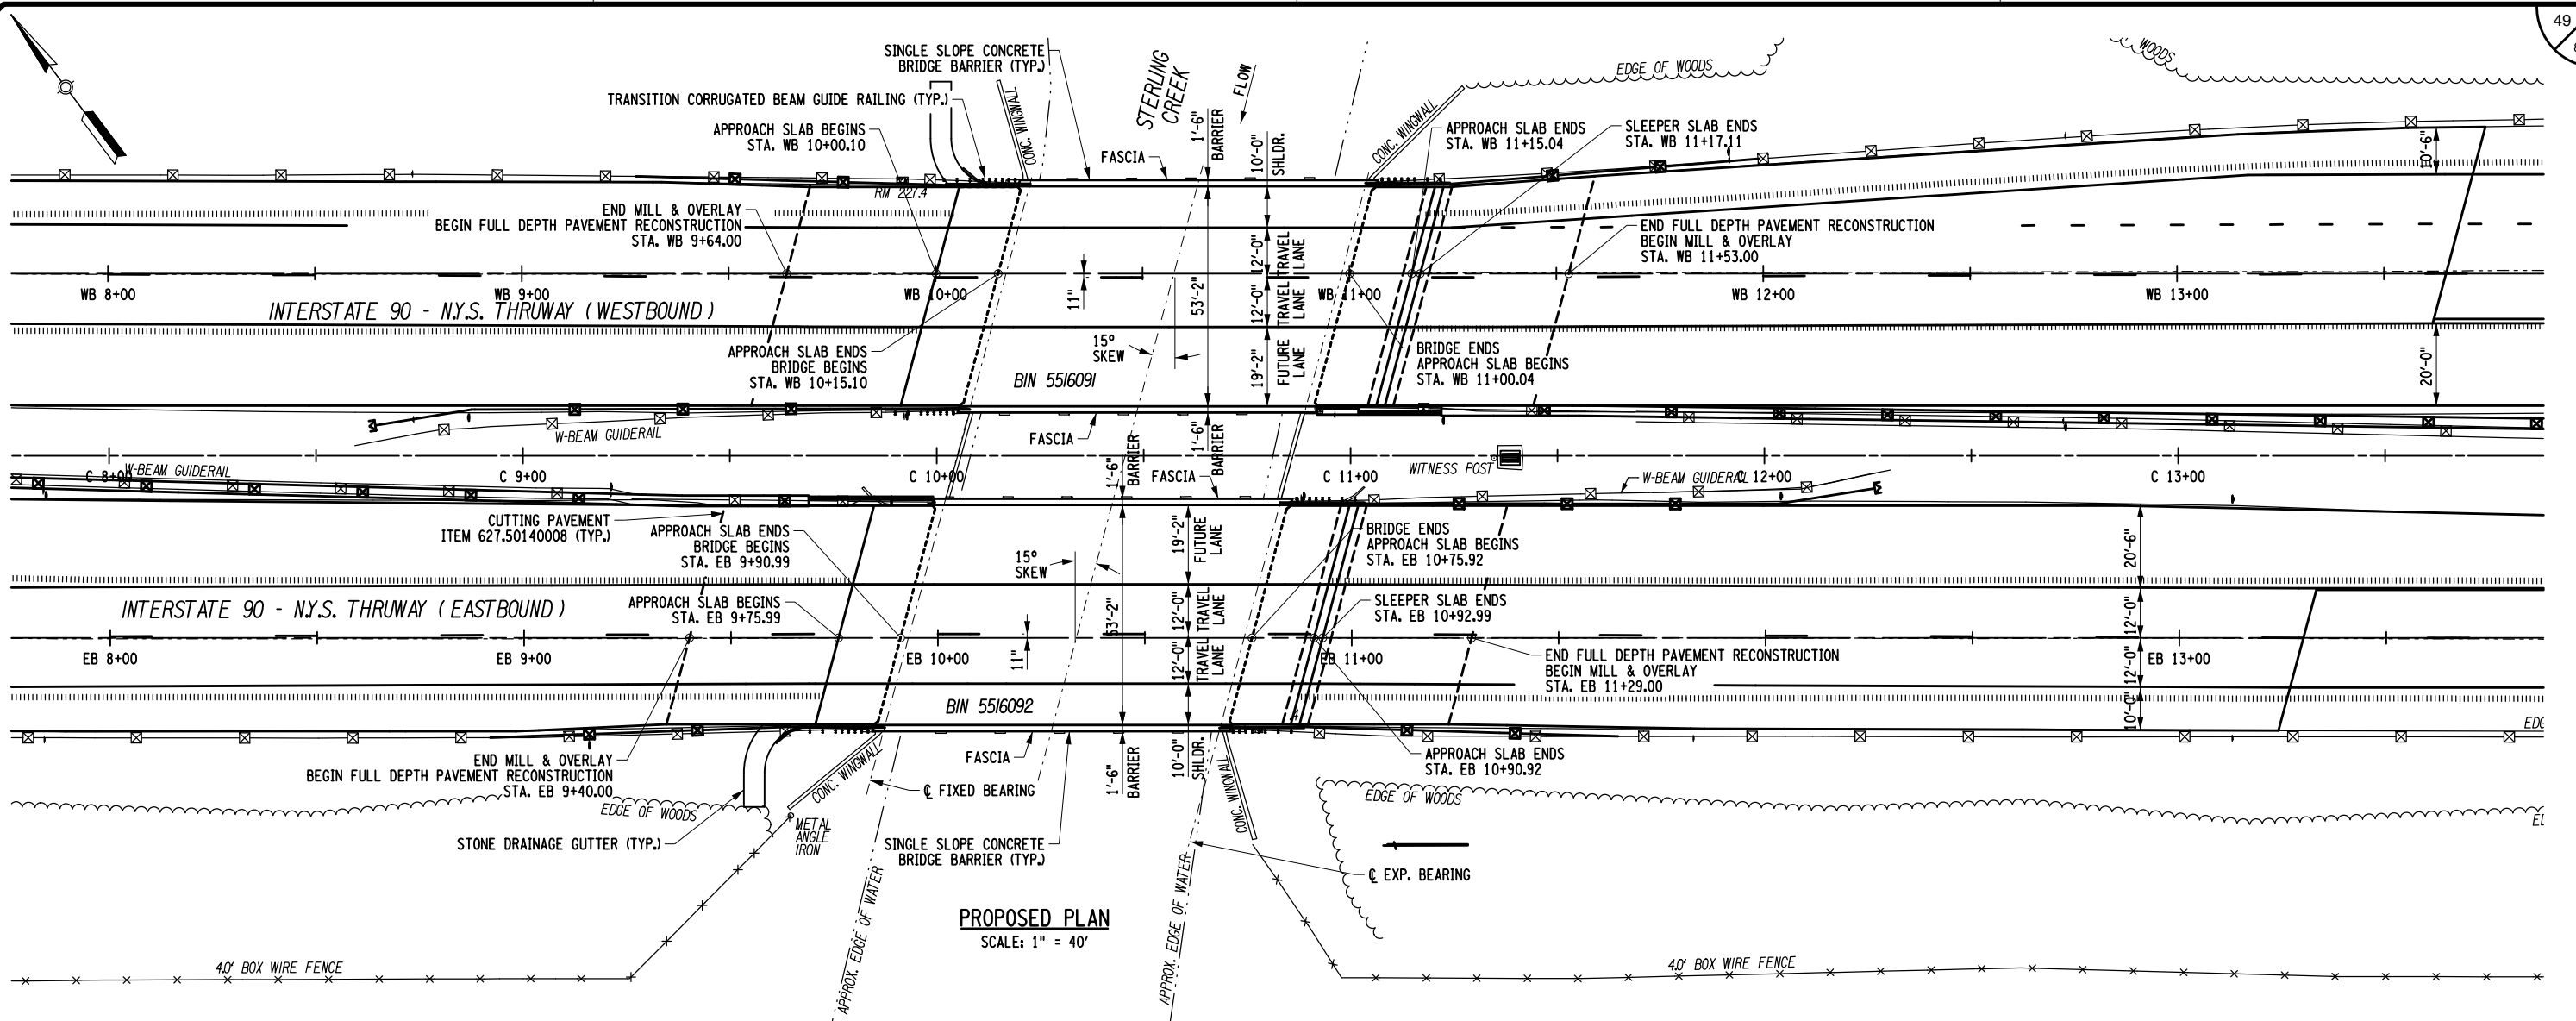

- TRANSITION FROM NEW BRIDGE BARRIER TO EXISTING HPBO MEDIAN BARRIER INCLUDES ITEM 606.9004 - TRANSITION BETWEEN HALF-SECTION AND FULL-SECTION SINGLE SLOPE CONCRETE BARRIER (RIGHT POCKET), ITEM 606.8906 - TRANSITION: HPBO (MOD.) CORRUGATED BEAM MEDIAN BARRIER TO SINGLE SLOPE CONCRETE MEDIAN BARRIER AND ITEM 606.2801 - HPBO (MOD.) CORRUGATED BEAM MEDIAN BARRIER (AS NEEDED).

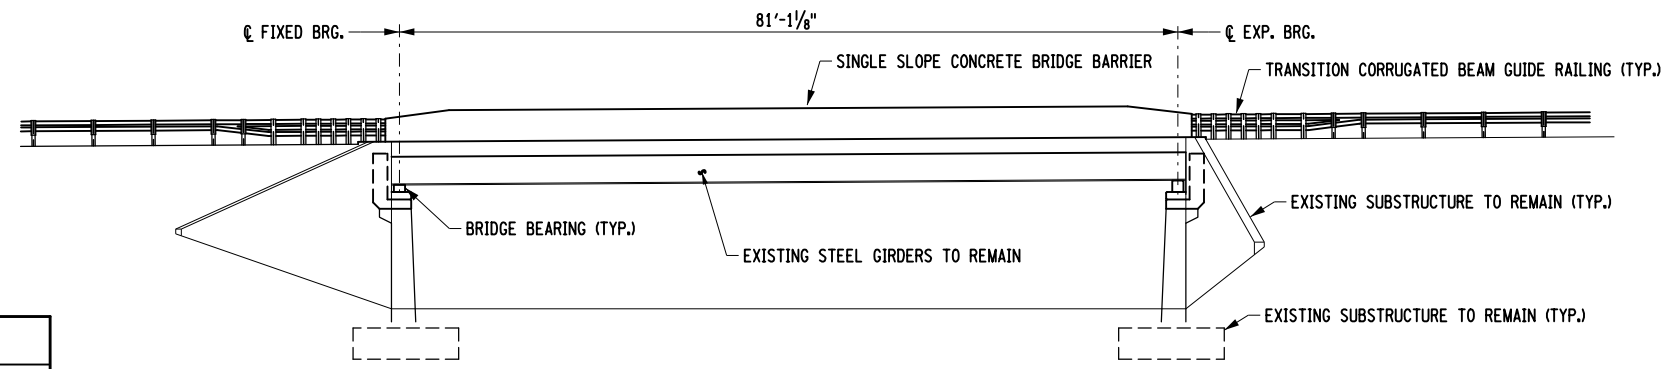

ALTERED ON:	AFFIXED ON: 12/04/2023
SIGNATURE: STAMP:	SIGNATURE: STAMP:


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REVISIONS			
DATE	DESCRIPTION	BY	SYM.

	TITLE OF PROJECT STERLING CREEK BRIDGE REHABILITATION	CONTRACT NUMBER: TAS 24-5B
	LOCATION OF PROJECT SYRACUSE DIVISION BIN 5516091 & 5516092, MP 227.40 & MP 227.41	DATE: NOV. 2023
	TITLE OF DRAWING PROPOSED PLAN AND ELEVATION	DRAWING NUMBER: ST-4

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 USER = L.lindo

DESIGN SUPERVISOR: C. SICHAK
 DRAFTED BY: T. LINDO
 CHECKED BY: N. BARNHARD

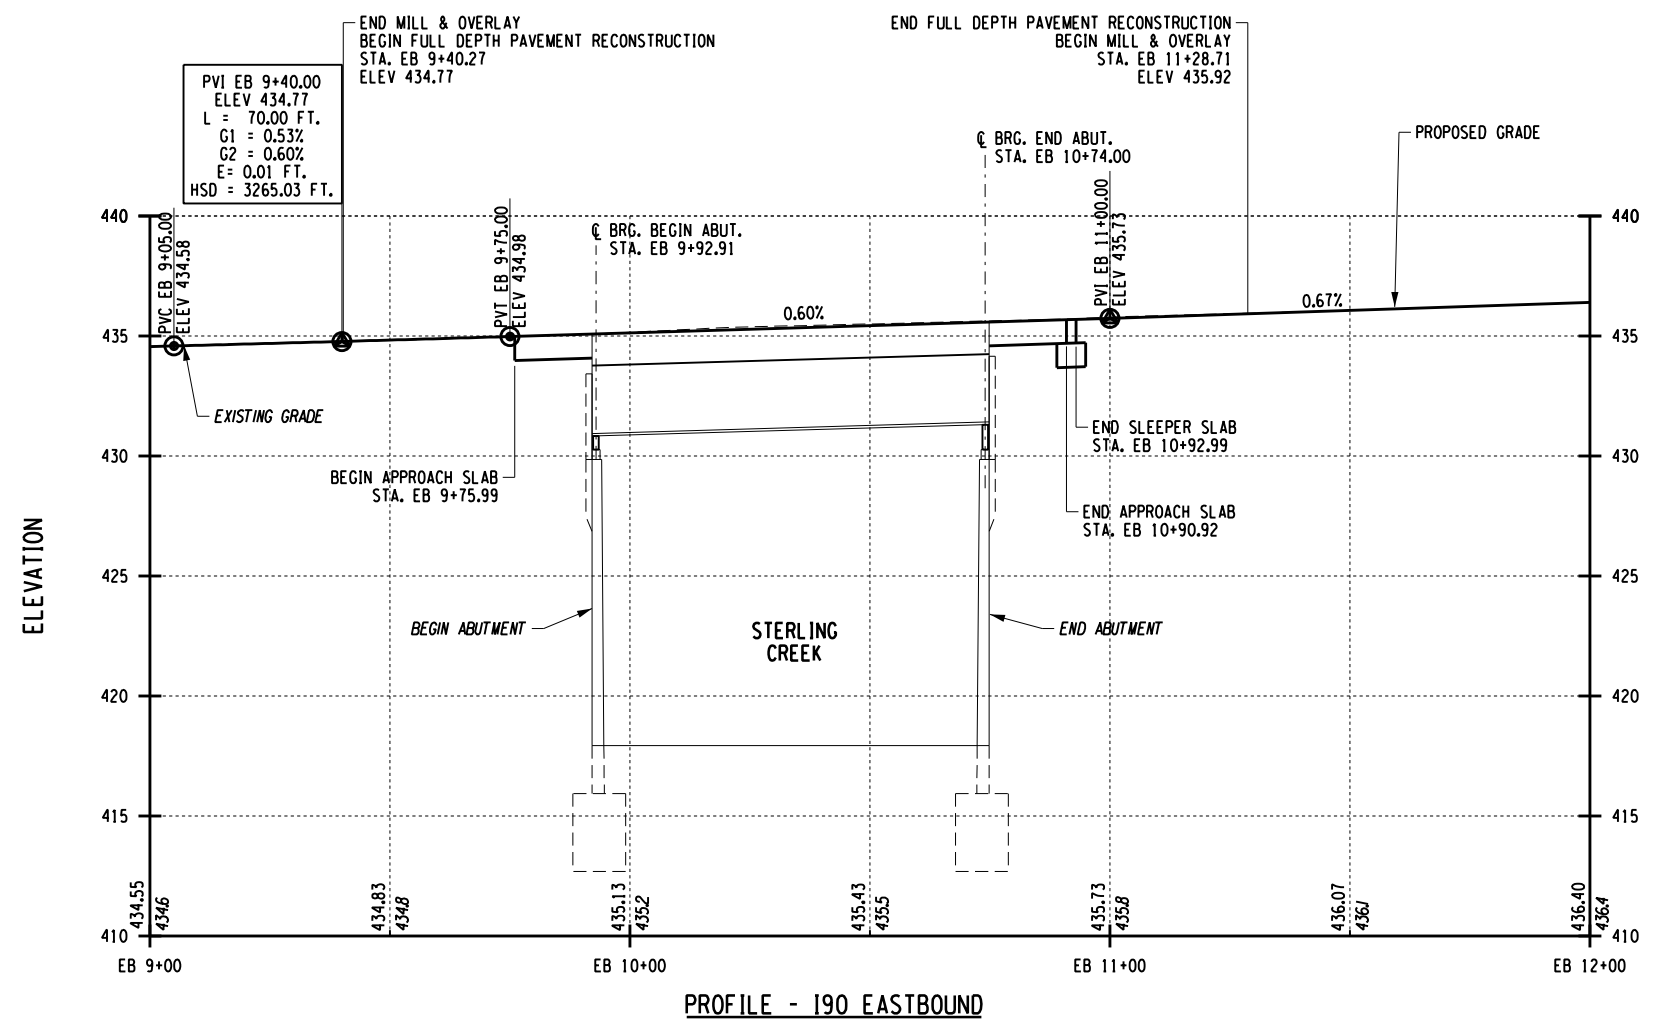

ALTERED ON:	AFFIXED ON: 12/04/2023
SIGNATURE: STAMP:	SIGNATURE: STAMP:

IT IS A VIOLATION OF LAW FOR ANY PERSON, UNLESS THEY ARE ACTING UNDER THE DIRECTION OF A LICENSED PROFESSIONAL ENGINEER, ARCHITECT, LANDSCAPE ARCHITECT, OR LAND SURVEYOR, TO ALTER AN ITEM IN ANY WAY. IF AN ITEM BEARING THE STAMP OF A LICENSED PROFESSIONAL IS ALTERED, THE ALTERING ENGINEER, ARCHITECT, LANDSCAPE ARCHITECT, OR LAND SURVEYOR SHALL STAMP THE DOCUMENT AND INCLUDE THE NOTATION "ALTERED BY" FOLLOWED BY THEIR SIGNATURE. THE DATE OF SUCH ALTERATION, AND A SPECIFIC DESCRIPTION OF THE ALTERATION.


REVISIONS			
DATE	DESCRIPTION	BY	SYMBOL

Thruway Authority


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LOCATION OF PROJECT SYRACUSE DIVISION BIN 5516091 & 5516092 MP 227.40 & MP 227.41	DATE: NOV. 2023
TITLE OF DRAWING PROPOSED PROFILE (EASTBOUND)	DRAWING NUMBER: ST-6

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 USER = L.lindo

DESIGN SUPERVISOR: C. SICHAK
 DRAFTED BY: T. LINDO
 CHECKED BY: N. BARNHARD

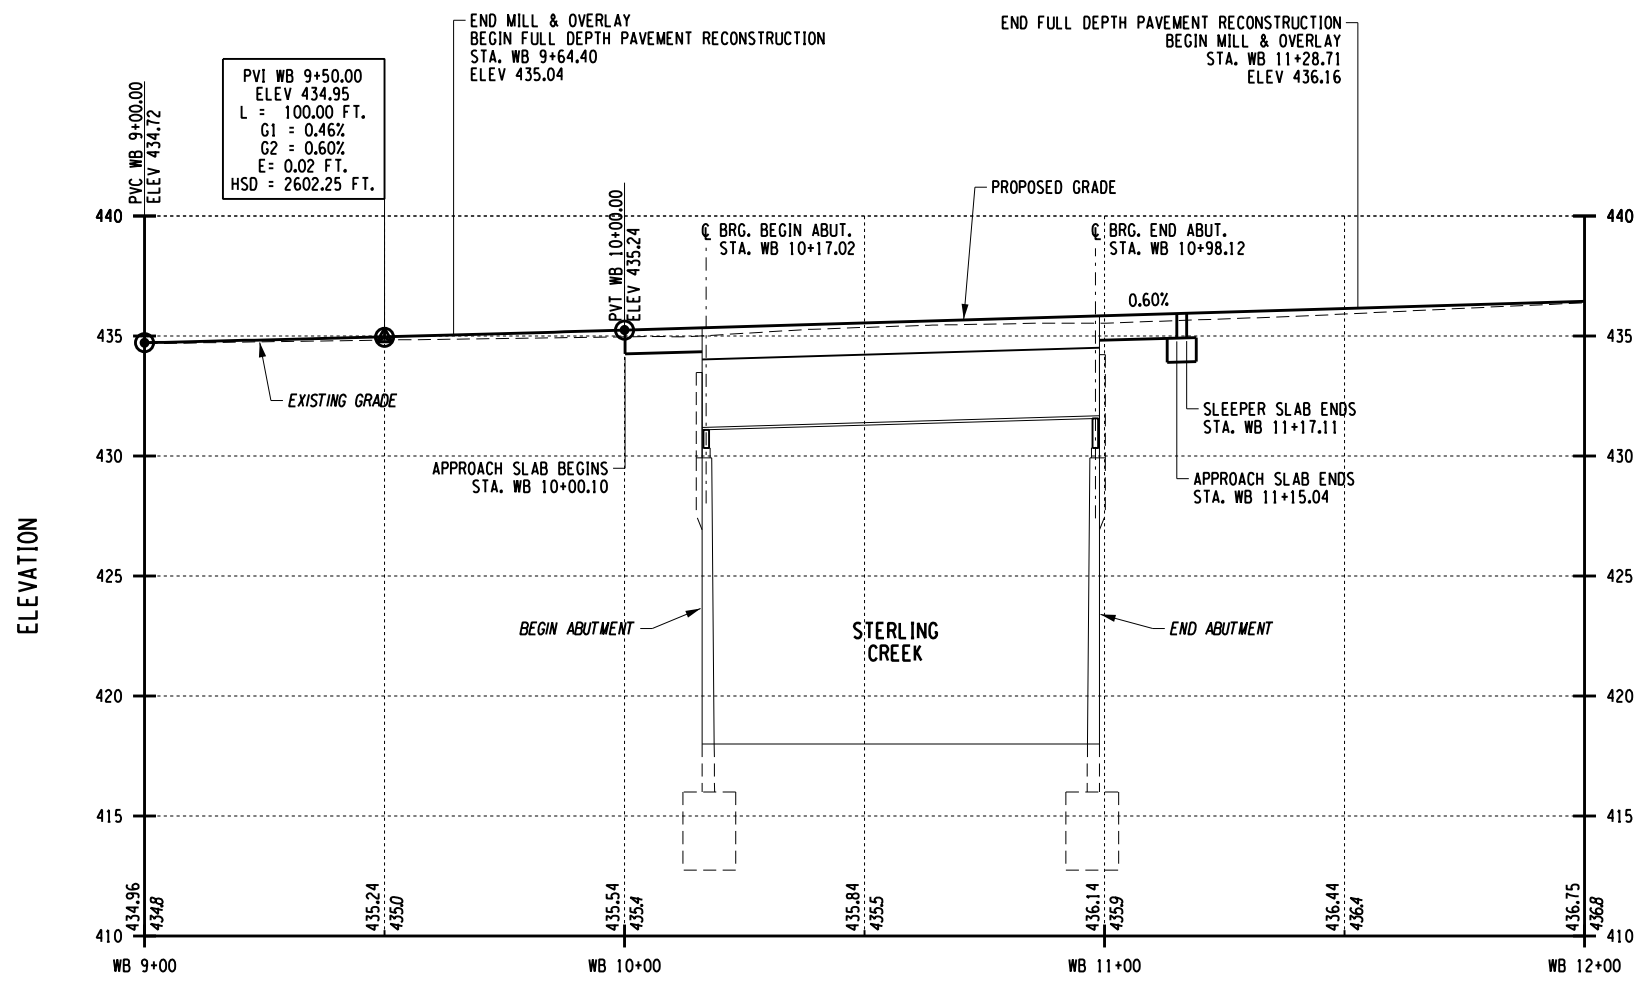

PROFILE - 190 WESTBOUND

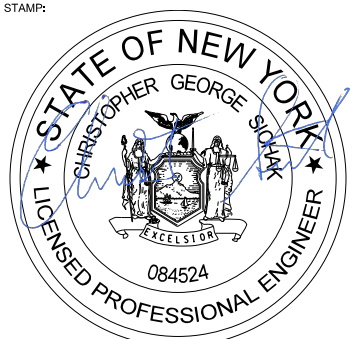ALTERED ON:	AFFIXED ON: 12/04/2023
SIGNATURE: STAMP:	SIGNATURE: STAMP: 


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REVISIONS			
DATE	DESCRIPTION	BY	SYM.




TITLE OF PROJECT: STERLING CREEK BRIDGE REHABILITATION
 LOCATION OF PROJECT: SYRACUSE DIVISION
 BIN 5516091 & 5516092 MP 227.40 & MP 227.41
 TITLE OF DRAWING: PROPOSED PROFILE (WESTBOUND)

CONTRACT NUMBER: TAS 24-5B
 DATE: NOV. 2023
 DRAWING NUMBER: ST-7

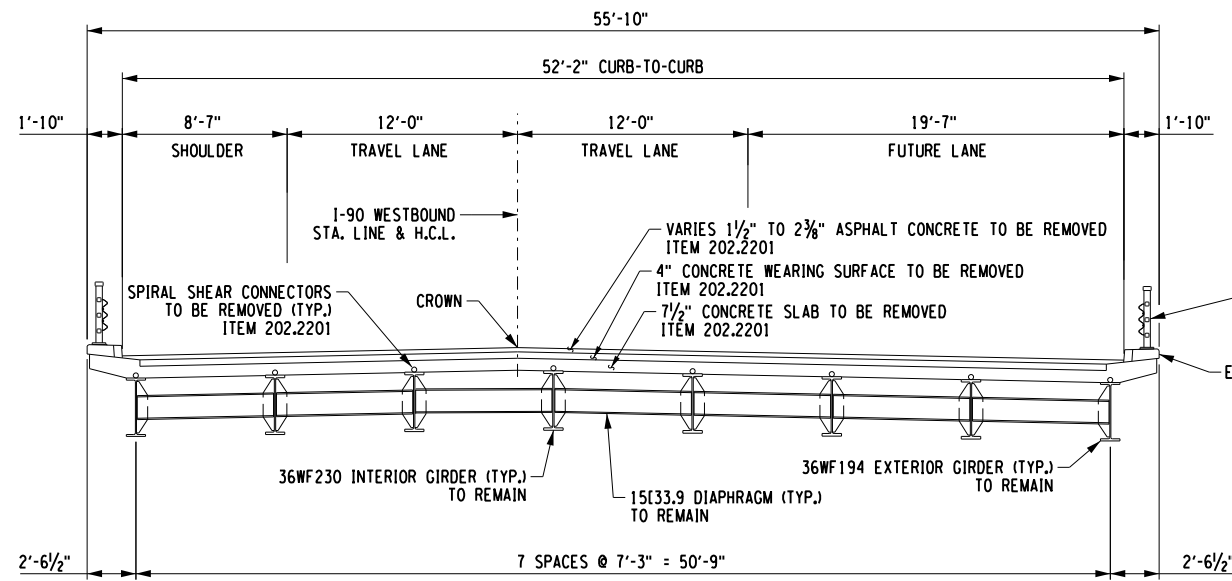


I-90 WESTBOUND

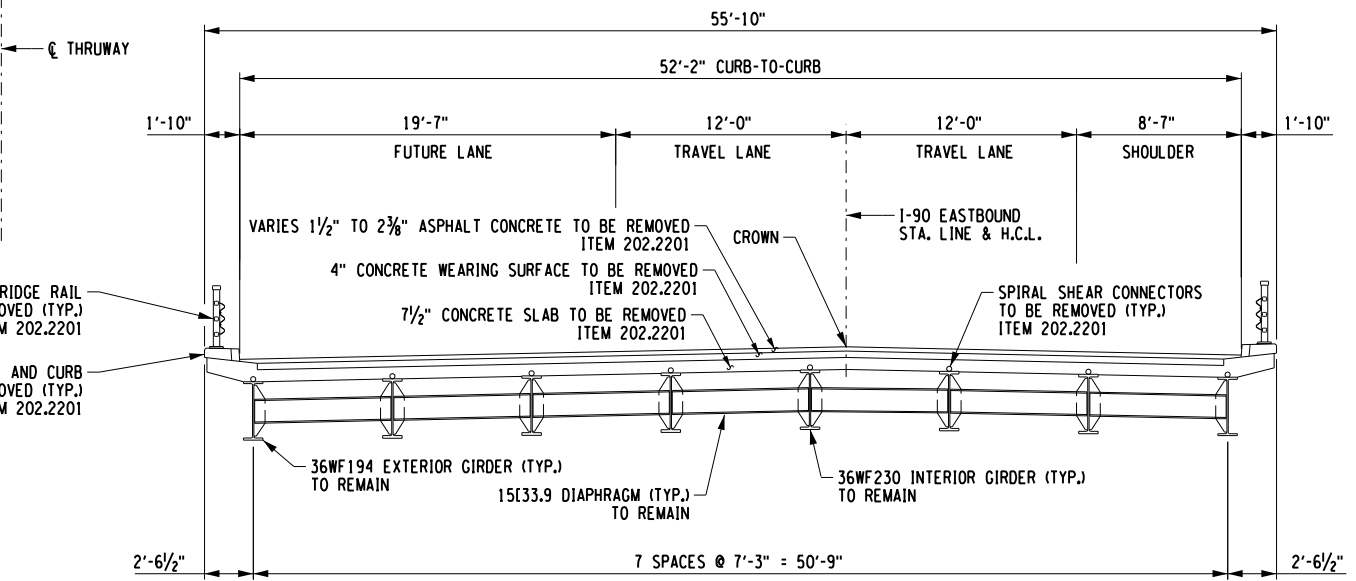


I-90 EASTBOUND

EXISTING TRANSVERSE SECTION
SCALE: 1" = 10'

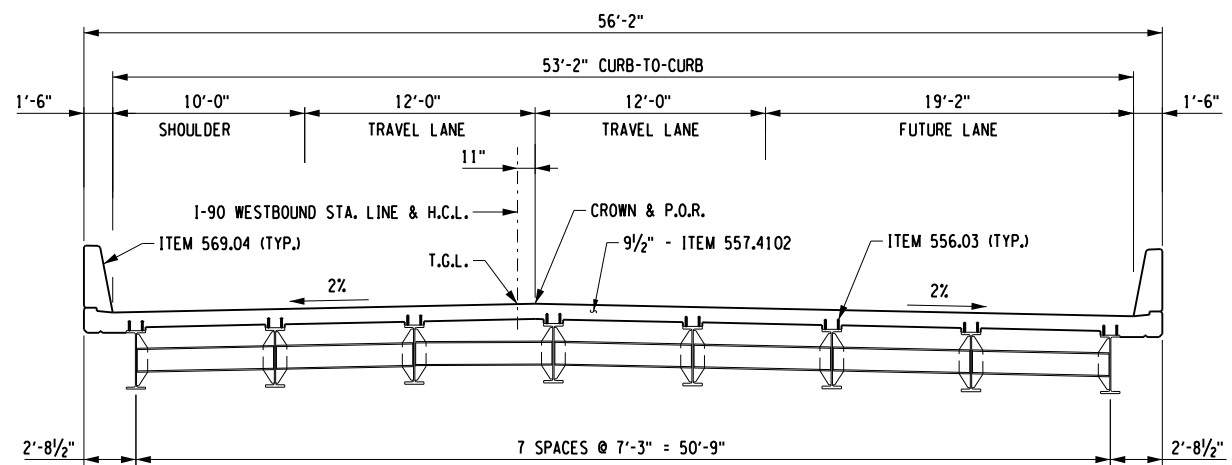


I-90 WESTBOUND

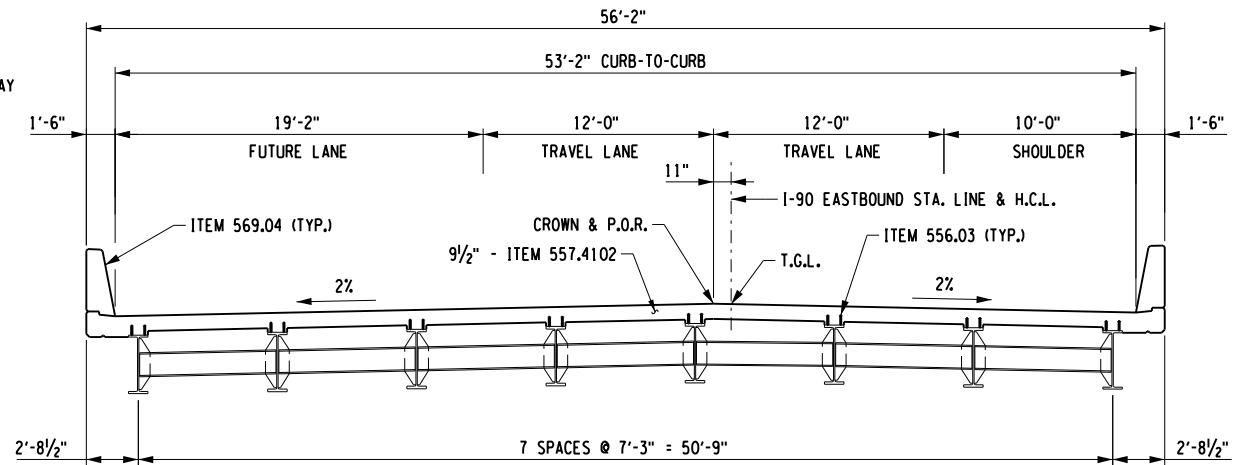

I-90 EASTBOUND


PROPOSED TRANSVERSE SECTION
SCALE: 1" = 10'

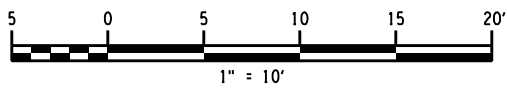


CHECKED BY: N. BARNHARD
 DRAFTED BY: T. LINDO
 CHECKED BY: N. BARNHARD
 DESIGNED BY: C. SICHAK

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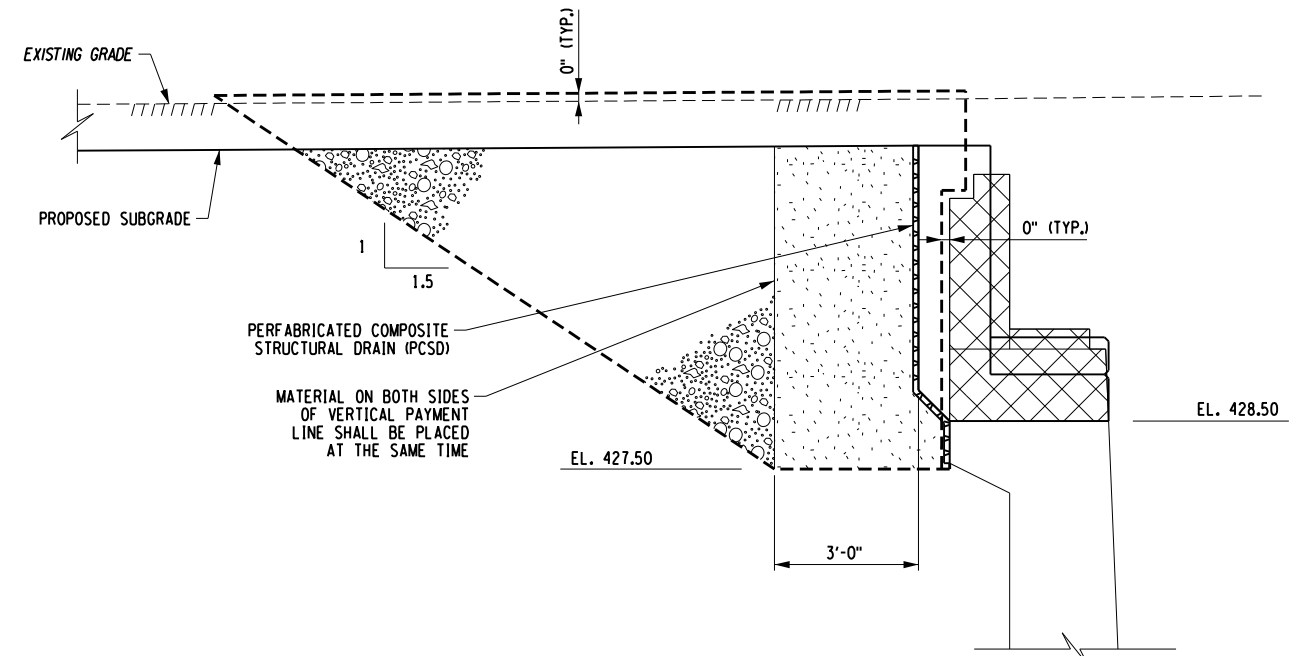
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SIGNATURE: STAMP:		SIGNATURE: STAMP:		556.03	STUD SHEAR CONNECTORS FOR BRIDGES	EA					
				557.4102	SUPERSTRUCTURE SLAB WITH INTEGRAL WEARING SURFACE -	SY					
				404.097201	HPIC BOTTOM FORMWORK REQUIRED, TYPE 2 FRICTION	LF					
				569.04	SINGLE SLOPE (HALF SECTION) CONCRETE BRIDGE BARRIER						
IT IS A VIOLATION OF LAW FOR ANY PERSON, UNLESS THEY ARE ACTING UNDER THE DIRECTION OF A LICENSED PROFESSIONAL ENGINEER, ARCHITECT, LANDSCAPE ARCHITECT, OR LAND SURVEYOR, TO ALTER AN ITEM IN ANY WAY. IF AN ITEM BEARING THE STAMP OF A LICENSED PROFESSIONAL IS ALTERED, THE ALTERING ENGINEER, ARCHITECT, LANDSCAPE ARCHITECT, OR LAND SURVEYOR SHALL STAMP THE DOCUMENT AND INCLUDE THE NOTATION "ALTERED BY" FOLLOWED BY THEIR SIGNATURE. THE DATE OF SUCH ALTERATION, AND A SPECIFIC DESCRIPTION OF THE ALTERATION.				REVISIONS DATE DESCRIPTION BY SYM.						TITLE OF PROJECT STERLING CREEK BRIDGE REHABILITATION	CONTRACT NUMBER: TAS 24-5B
								LOCATION OF PROJECT SYRACUSE DIVISION BIN 5516091 & 5516092 MP 227.40 & MP 227.41		DATE: NOV. 2023	
										TITLE OF DRAWING EXISTING AND PROPOSED TRANSVERSE SECTION	DRAWING NUMBER: ST-5

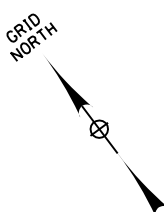

CHECKED BY: N. BARNHARD
 DRAFTED BY: T. LINDO
 CHECKED BY: N. BARNHARD
 DESIGNED BY: C. SICHAK
 DESIGN SUPERVISOR: C. SICHAK

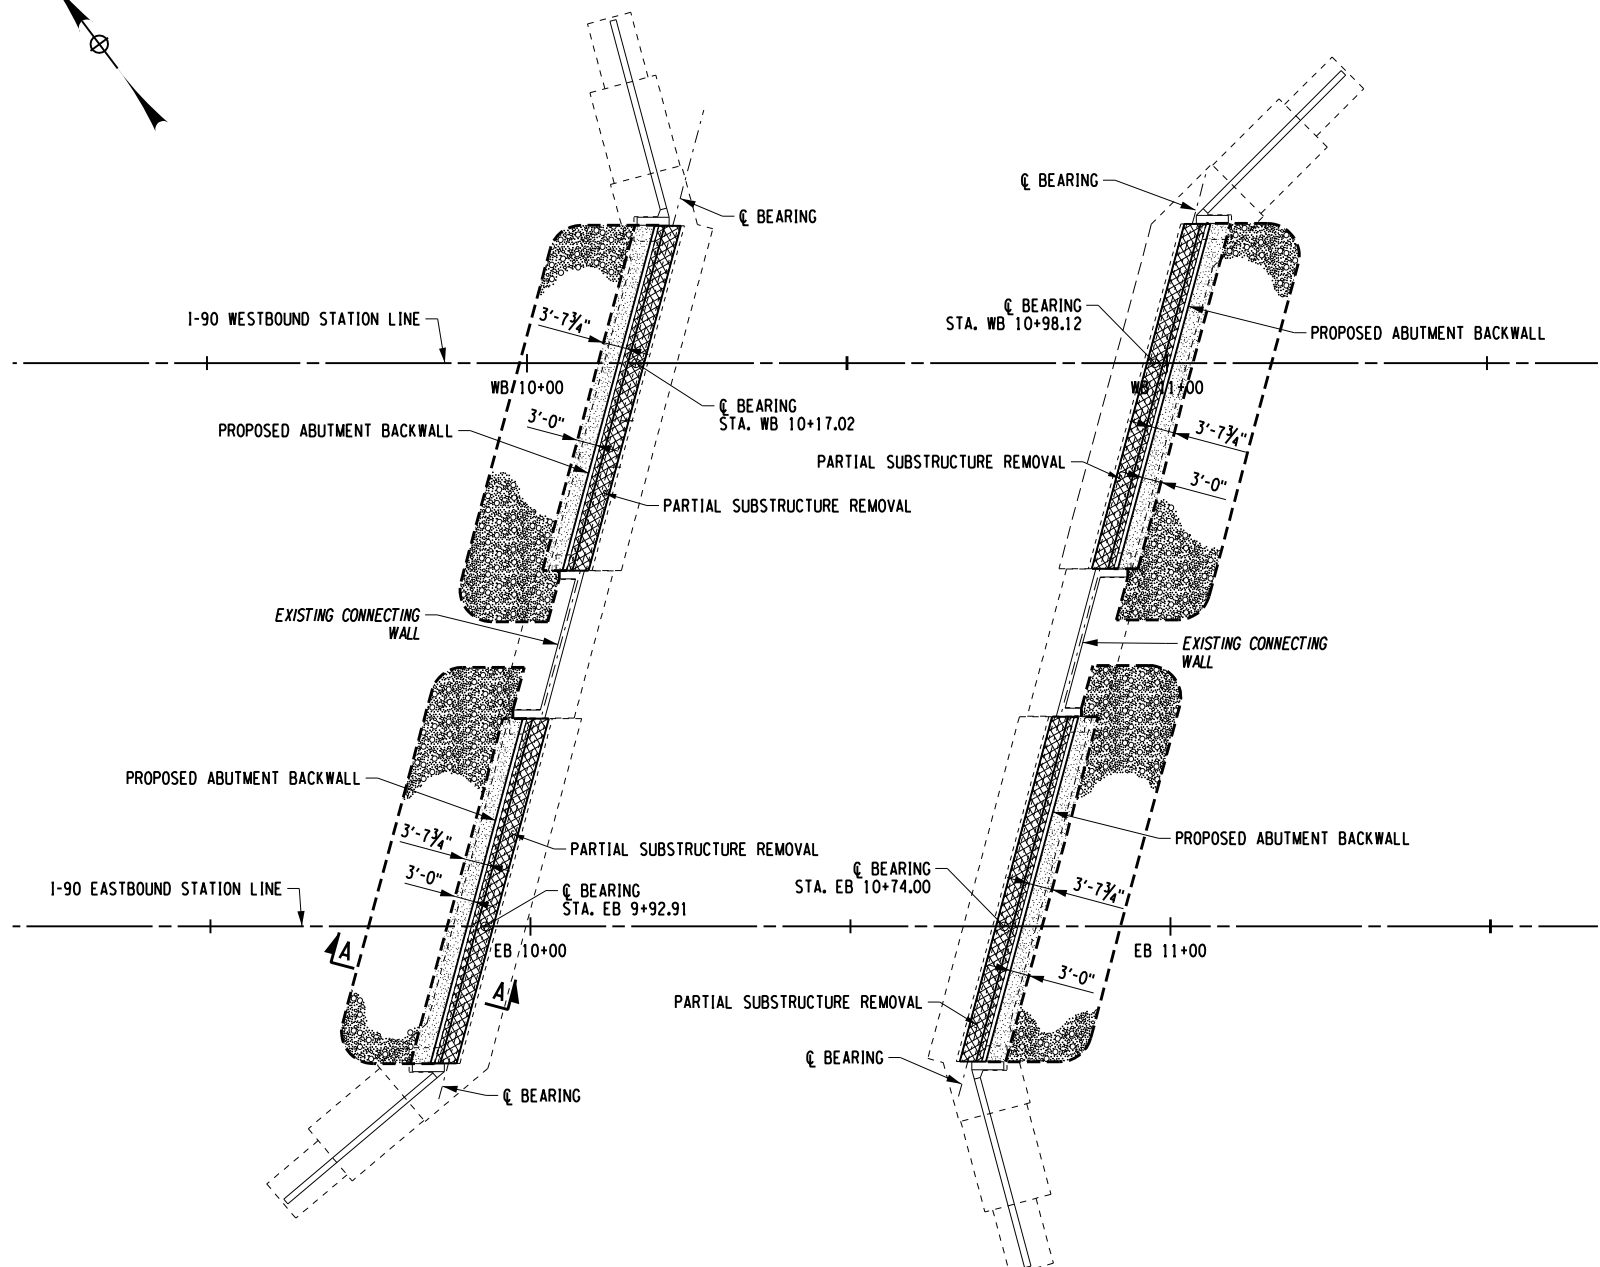

EXCAVATION PLAN
SCALE: 1" = 30'-0"



SECTION A-A
(I-90 EASTBOUND BEGIN ABUTMENT SHOWN,
I-90 EASTBOUND END ABUTMENT AND I-90 WESTBOUND ABUTMENTS SIMILAR)

LEGEND

- EXISTING GROUND SURFACE
- SELECT STRUCTURE FILL (ITEM 203.21), COMPACTED TO 95% OF STANDARD PROCTOR MAXIMUM DENSITY
- EMBANKMENT IN PLACE (ITEM 203.03)
- REMOVAL OF STRUCTURAL CONCRETE, ITEM 580.01
- AREA ENCLOSED WITHIN THESE LINES DESIGNATES PAYMENT LINES FOR STRUCTURE EXCAVATION (ITEM 206.01)
- PREFABRICATED COMPOSITE STRUCTURAL/INTEGRAL ABUTMENT DRAIN (ITEM 207.26/27)

ALTERED ON: SIGNATURE: STAMP:	AFFIXED ON: 12/04/2023 SIGNATURE: STAMP: <div style="text-align: center;"> </div>
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


REVISIONS			
DATE	DESCRIPTION	BY	SYM.

 Thruway Authority 	TITLE OF PROJECT STERLING CREEK BRIDGE REHABILITATION	CONTRACT NUMBER: TAS 24-5B
	LOCATION OF PROJECT SYRACUSE DIVISION BIN 5516091 & 5516092 MP 227.40 & MP 227.41	DATE: NOV. 2023
	TITLE OF DRAWING EXCAVATION PLAN AND SECTION	DRAWING NUMBER: ST-8

NOTES:

1. SAWCUT ALL CONCRETE REMOVAL LIMITS TO 1" DEEP ALONG ALL EDGES PRIOR TO CONCRETE REMOVAL.
2. SEE DRAWING NO. ST-13 FOR SECTION A-A.
3. LOAD TABLES HAVE BEEN PROVIDED FOR THE LIFTING OPERATIONS OF THE EXISTING GIRDERS AND DIAPHRAGMS. THESE LOADS ARE BASED ON A SYMMETRICAL SUPPORT SYSTEM ABOUT THE LENGTH OF THE GIRDERS. IF THE SUPPORT SYSTEM IS NOT SYMMETRICAL, THE LOADS PROVIDED IN THE TABLES MUST BE RE-EVALUATED.
4. SEE CONCRETE REMOVAL DETAILS ON DRAWING NO. ST-19.
5. REFER TO "USACE NATIONWIDE PERMIT #3 MAINTENANCE" FOR WATERWAY DIVERSION AND IN-WATER WORK REQUIREMENTS.


LEGEND

-  REMOVAL OF STRUCTURAL CONCRETE, ITEM 580.01
-  REMOVAL OF STRUCTURAL CONCRETE - REPLACEMENT WITH CLASS D CONCRETE, ITEM 528.06
-  CRACK REPAIR BY EPOXY INJECTION (RESTORATION), ITEM 555.80020001


ABBR.	DESCRIPTION
(H)	HOLLOW
(HL)	HAIR LINE
(S)	SPALLED
(SC)	SCALING
(E)	EFFLORESCENCE
(MC)	MAP CRACKING
(CJ)	CONSTRUCTION JOINT

CONCRETE REMOVAL & REPAIR TABLE	
QUANTITY	ITEM NO.
24.2 CY	580.01
100.0 SF	582.06
25.0 LF	555.80020001

STRUCTURAL LIFTING LOAD TABLE	
GIRDER	LOAD (kip)
G9	10.949
G10	12.884
G11	12.884
G12	12.884
G13	12.884
G14	12.884
G15	12.884
G16	10.949

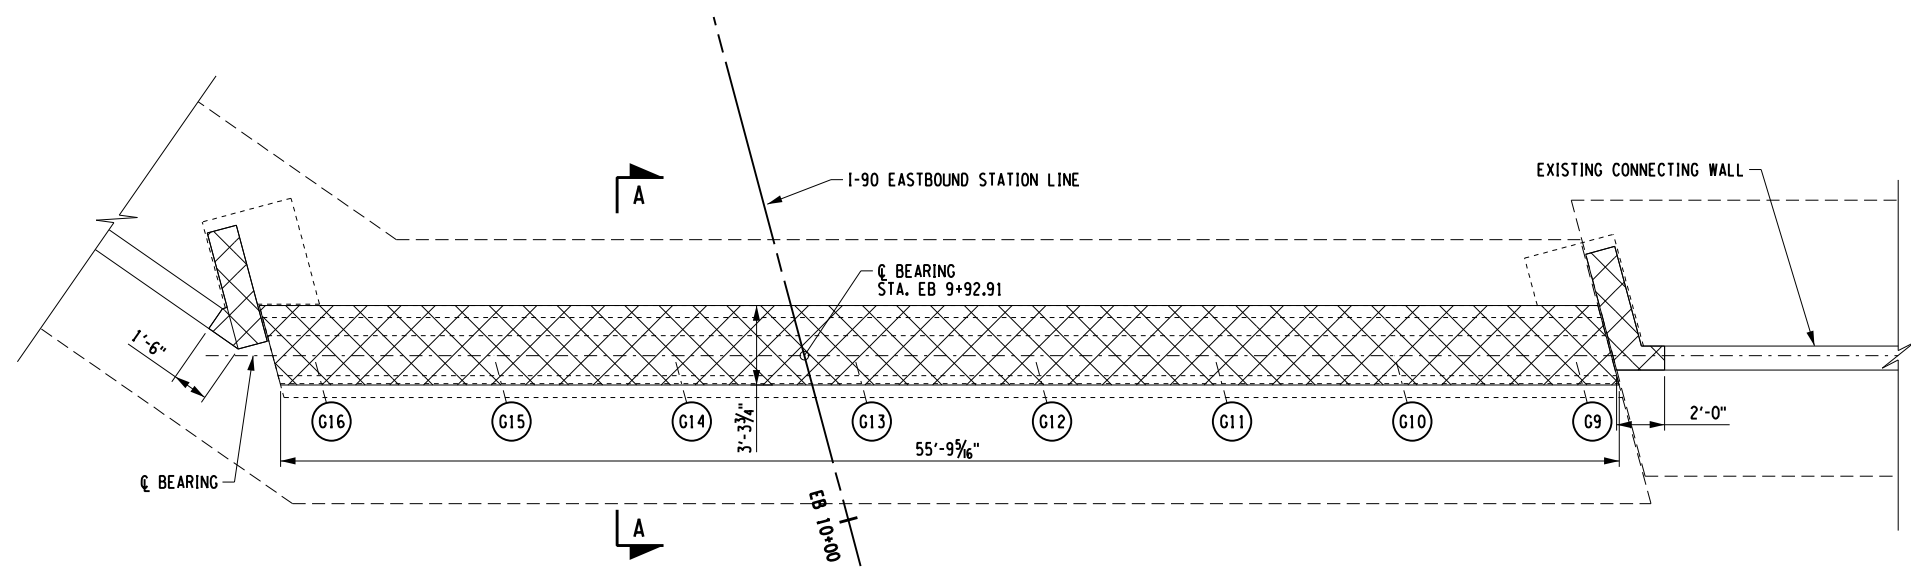

BEGIN ABUTMENT PLAN
(I-90 EASTBOUND)
SCALE: 1/8" = 1'-0"

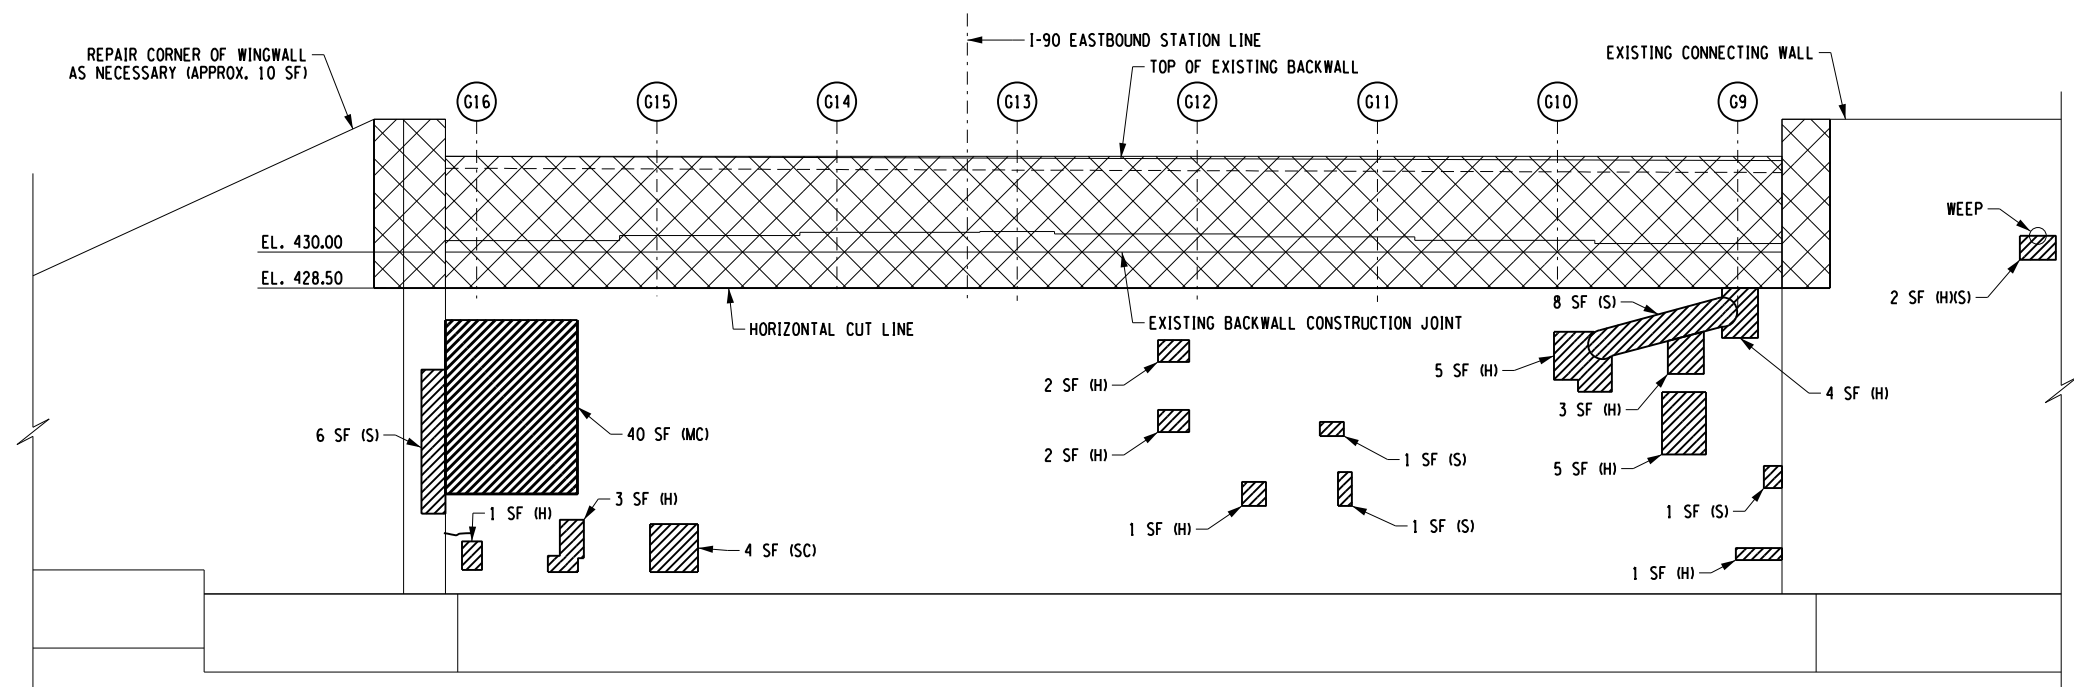


ELEVATION
(I-90 EASTBOUND)
SCALE: 1/8" = 1'-0"

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
DESIGN SUPERVISOR: C. SICHAK
 CHECKED BY: N. BARNHARD
 DRAFTED BY: T. LINDO
 CHECKED BY: N. BARNHARD

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


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REVISIONS			
DATE	DESCRIPTION	BY	SYM.



Thruway Authority






TITLE OF PROJECT STERLING CREEK BRIDGE REHABILITATION	CONTRACT NUMBER: TAS 24-5B
LOCATION OF PROJECT SYRACUSE DIVISION BIN 5516091 & 5516092 MP 227.40 & MP 227.41	DATE: NOV. 2023
TITLE OF DRAWING BEGIN ABUTMENT DEMOLITION PLAN AND ELEVATION (EASTBOUND)	DRAWING NUMBER: ST-9

NOTES:

1. SAWCUT ALL CONCRETE REMOVAL LIMITS TO 1" DEEP ALONG ALL EDGES PRIOR TO CONCRETE REMOVAL.
2. SEE DRAWING NO. ST-13 FOR SECTION A-A.
3. LOAD TABLES HAVE BEEN PROVIDED FOR THE LIFTING OPERATIONS OF THE EXISTING GIRDERS AND DIAPHRAGMS. THESE LOADS ARE BASED ON A SYMMETRICAL SUPPORT SYSTEM ABOUT THE LENGTH OF THE GIRDERS. IF THE SUPPORT SYSTEM IS NOT SYMMETRICAL, THE LOADS PROVIDED IN THE TABLES MUST BE RE-EVALUATED.
4. SEE CONCRETE REMOVAL DETAILS ON DRAWING NO. ST-19.
5. REFER TO "USACE NATIONWIDE PERMIT #3 MAINTENANCE" FOR WATERWAY DIVERSION AND IN-WATER WORK REQUIREMENTS.



LEGEND

-  REMOVAL OF STRUCTURAL CONCRETE, ITEM 580.01
-  REMOVAL OF STRUCTURAL CONCRETE - REPLACEMENT WITH CLASS D CONCRETE, ITEM 582.06
-  CRACK REPAIR BY EPOXY INJECTION (RESTORATION), ITEM 555.80020001

ABBR.	DESCRIPTION
(H)	HOLLOW
(HL)	HAIR LINE
(S)	SPALLED
(SC)	SCALING
(E)	EFFLORESCENCE
(MC)	MAP CRACKING
(CJ)	CONSTRUCTION JOINT

CONCRETE REMOVAL & REPAIR TABLE	
QUANTITY	ITEM NO.
24.2 CY	580.01
38.6 SF	582.06
19.0 LF	555.80020001


STRUCTURAL LIFTING LOAD TABLE	
GIRDER	LOAD (kip)
G1	10,949
G2	12,884
G3	12,884
G4	12,884
G5	12,884
G6	12,884
G7	12,884
G8	10,949

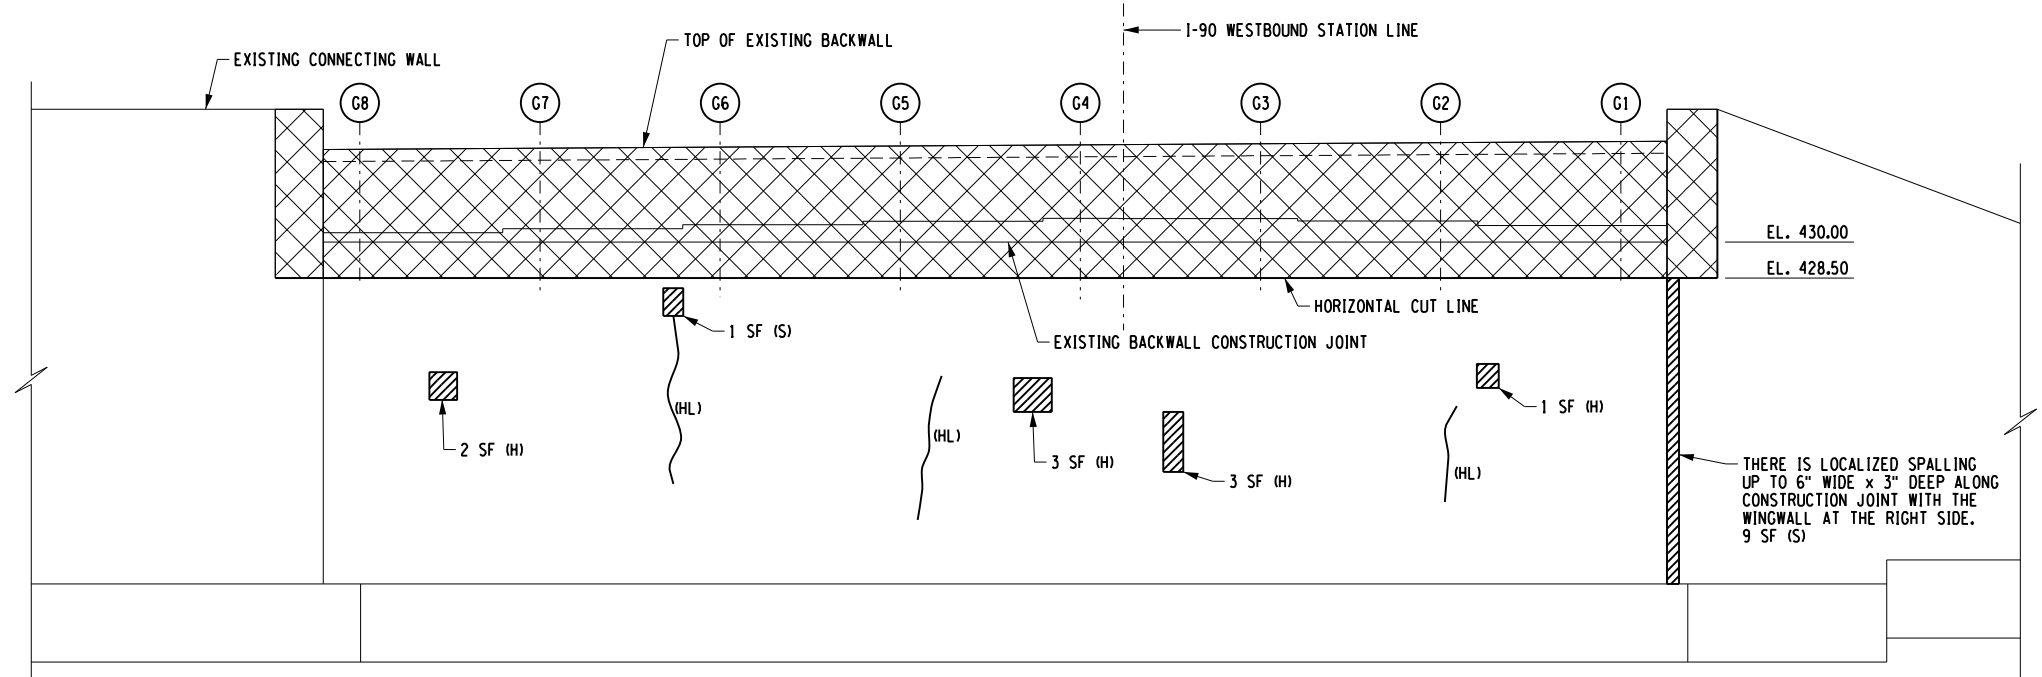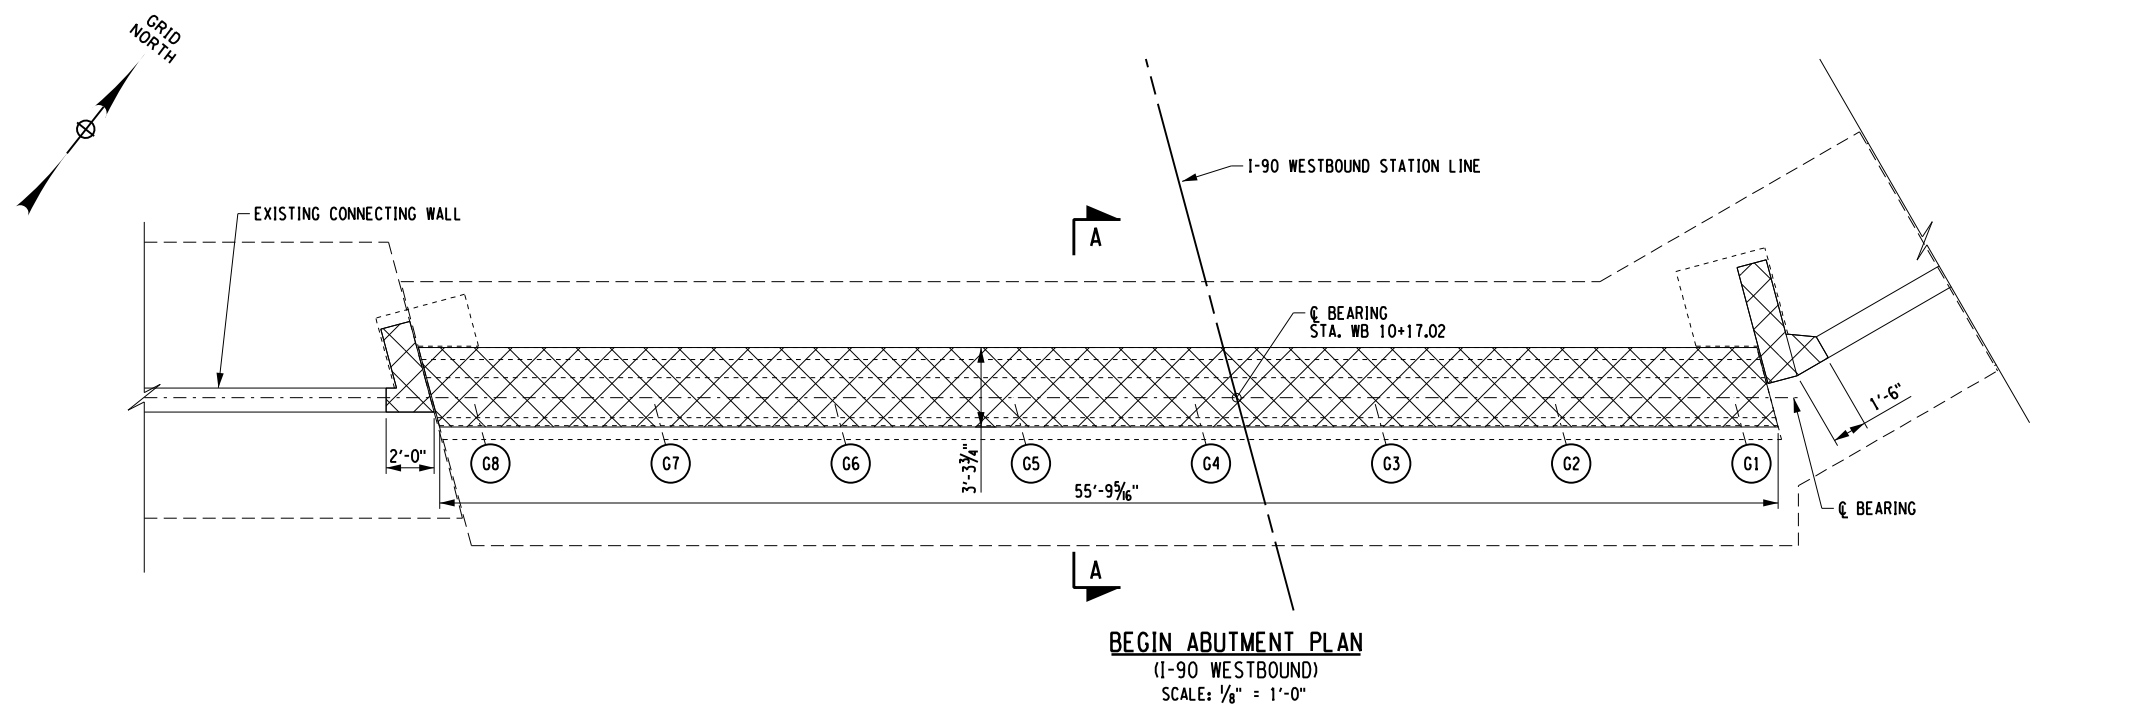

ELEVATION
(I-90 WESTBOUND)
SCALE: 1/8" = 1'-0"



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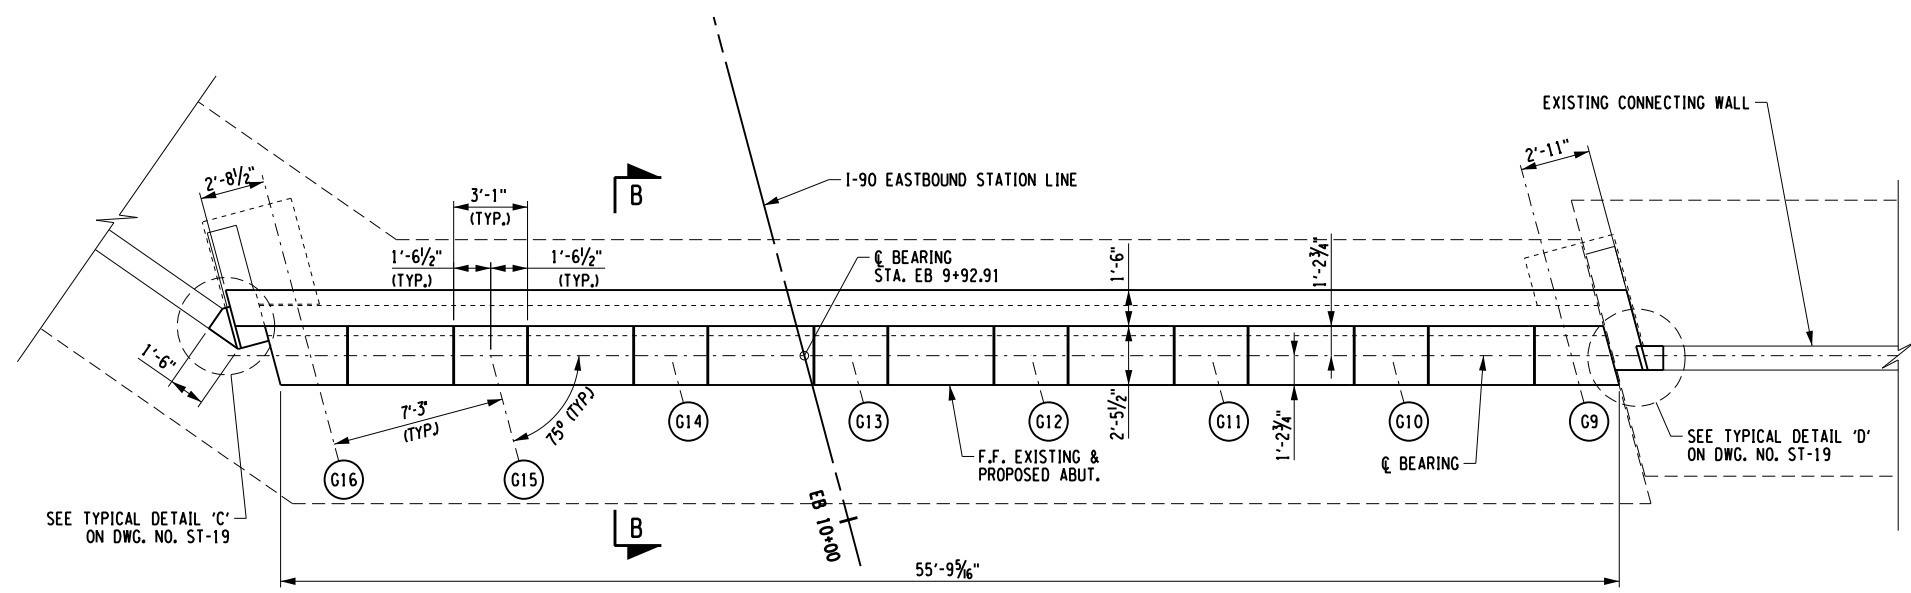
DESIGN SUPERVISOR: C. SICHAK
 DESIGNED BY: N. BARNHARD
 CHECKED BY: N. BARNHARD
 DRAFTED BY: T. LINDO

ALTERED ON:	AFFIXED ON: 12/04/2023
SIGNATURE: STAMP:	SIGNATURE: STAMP:
	


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REVISIONS			
DATE	DESCRIPTION	BY	SYM.

	TITLE OF PROJECT STERLING CREEK BRIDGE REHABILITATION	CONTRACT NUMBER: TAS 24-5B
	LOCATION OF PROJECT SYRACUSE DIVISION BIN 5516091 & 5516092 MP 227.40 & MP 227.41	DATE: NOV. 2023
	TITLE OF DRAWING BEGIN ABUTMENT DEMOLITION PLAN AND ELEVATION (WESTBOUND)	DRAWING NUMBER: ST-10



BEGIN ABUTMENT PLAN
(I-90 EASTBOUND)
SCALE: 1/8" = 1'-0"

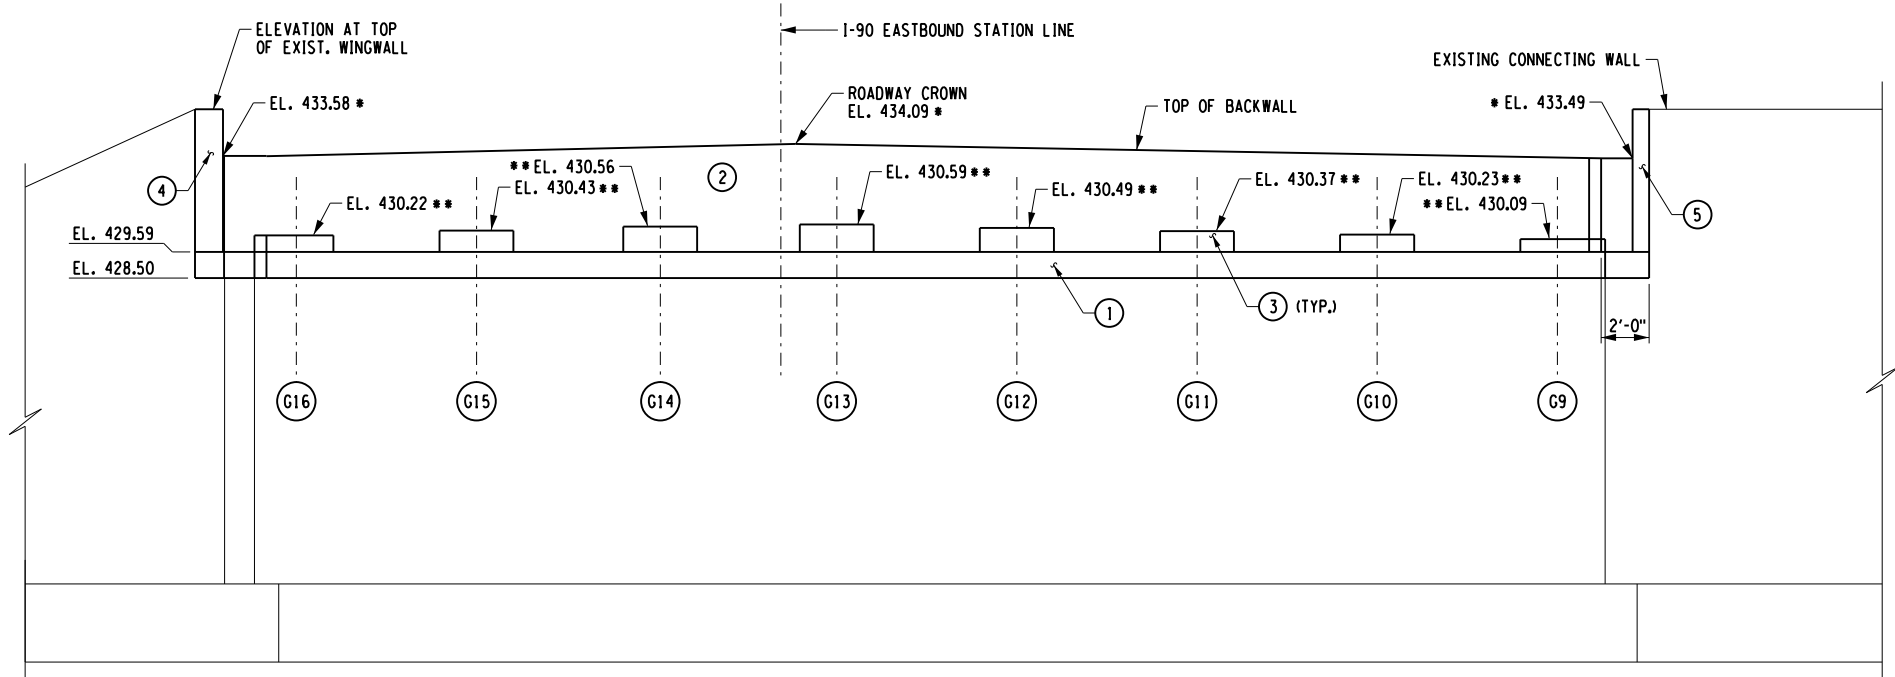

ELEVATION
(I-90 EASTBOUND)
SCALE: 1/8" = 1'-0"

NOTES:

1. SEE DWG. NO. ST-13 FOR SECTION B-B & REINFORCEMENT DETAILS.
2. SEE DWG. NO. ST-13 FOR DETAILS.
3. THE CONTRACTOR SHALL VERIFY THAT THE WEB OF THE GIRDERS ARE PLUMB. IF THE GIRDERS ARE ROTATED ABOUT THEIR LONGITUDINAL AXIS BY MORE THAN 1%, OR THE DIFFERENCE IN ELEVATION BETWEEN EACH EDGE OF THE BOTTOM FLANGE IS MORE THAN 1/8", THEN THE CONTRACTOR SHALL COORDINATE WITH THE BEARING MANUFACTURER TO DESIGN SOLE PLATES THAT ARE TAPERED IN THE TRANSVERSE DIRECTION.

LEGEND

- (G*) - DENOTES EXISTING GIRDER NUMBER
- (NO.) DENOTES CONCRETE PLACEMENT NUMBER

CONCRETE TABLE		
PLACEMENT	QUANTITY	ITEM NO.
1	9.9 CY	555.09
2	13.9 CY	555.09
3	2.9 CY	555.09
4	0.3 CY	555.09
5	0.2 CY	555.09

* ELEVATIONS GIVEN AT FRONT FACE OF BACKWALL
 ** THESE ELEVATIONS MAY HAVE TO BE ADJUSTED TO ACCOMMODATE THE ACTUAL BEARINGS FURNISHED. IT IS THE RESPONSIBILITY OF THE CONTRACTOR TO COORDINATE ANY CHANGES IN THE BEARINGS WHICH MAY AFFECT THE PEDESTAL ELEVATIONS.

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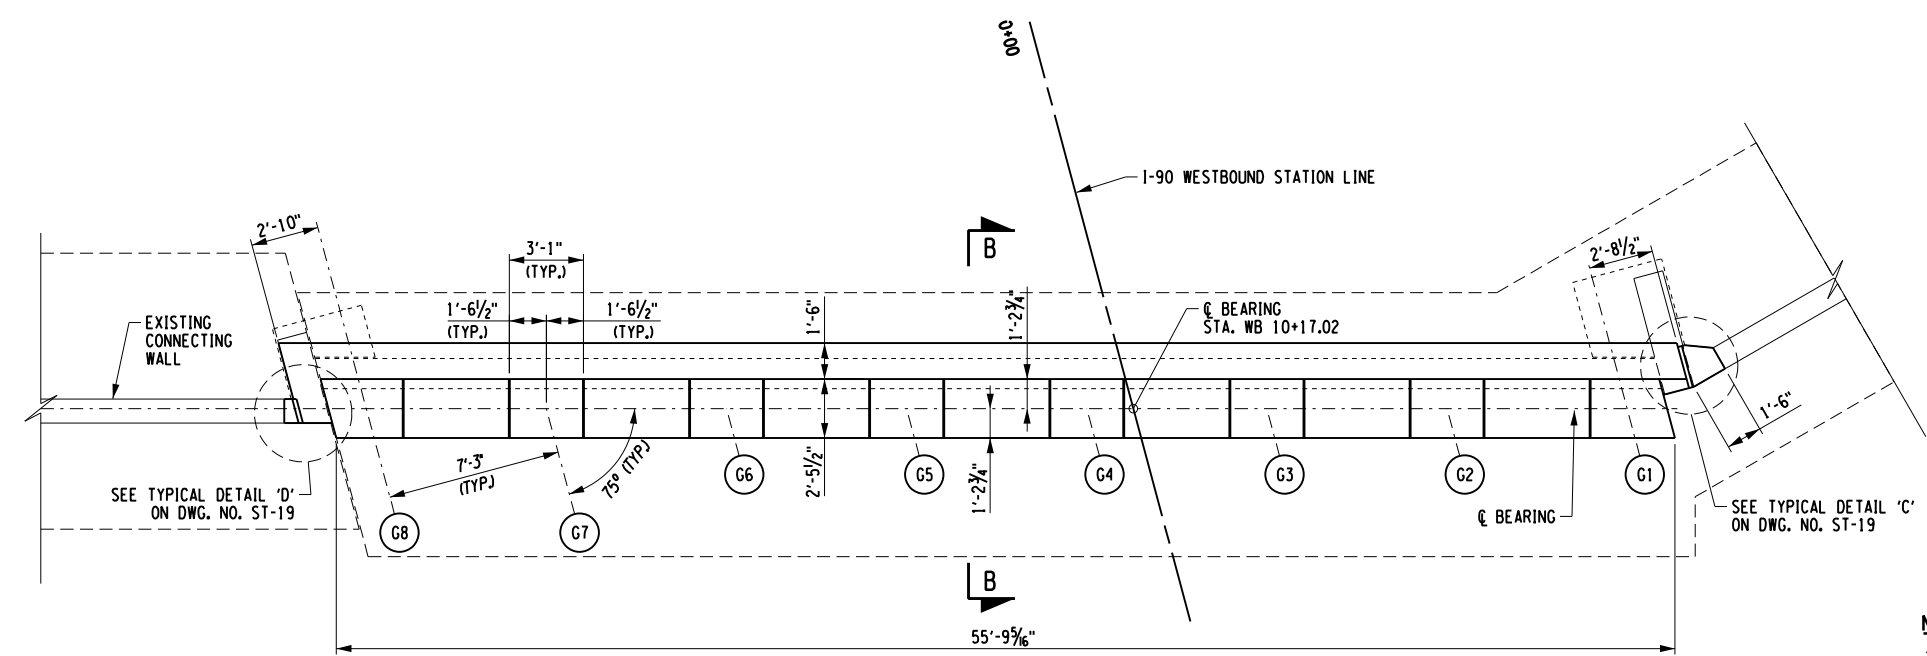
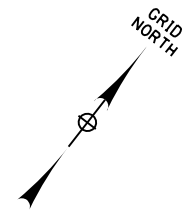
DESIGN SUPERVISOR: C. SICHAK
 CHECKED BY: N. BARNHARD
 DRAFTED BY: T. LINDO
 CHECKED BY: N. BARNHARD

ALTERED ON:	AFFIXED ON: 12/04/2023
SIGNATURE: STAMP:	SIGNATURE: STAMP:

IT IS A VIOLATION OF LAW FOR ANY PERSON, UNLESS THEY ARE ACTING UNDER THE DIRECTION OF A LICENSED PROFESSIONAL ENGINEER, ARCHITECT, LANDSCAPE ARCHITECT, OR LAND SURVEYOR, TO ALTER AN ITEM IN ANY WAY. IF AN ITEM BEARING THE STAMP OF A LICENSED PROFESSIONAL IS ALTERED, THE ALTERING ENGINEER, ARCHITECT, LANDSCAPE ARCHITECT, OR LAND SURVEYOR SHALL STAMP THE DOCUMENT AND INCLUDE THE NOTATION "ALTERED BY" FOLLOWED BY THEIR SIGNATURE. THE DATE OF SUCH ALTERATION, AND A SPECIFIC DESCRIPTION OF THE ALTERATION.


REVISIONS			
DATE	DESCRIPTION	BY	SYMBOL

	TITLE OF PROJECT STERLING CREEK BRIDGE REHABILITATION	CONTRACT NUMBER: TAS 24-5B
	LOCATION OF PROJECT SYRACUSE DIVISION BIN 5516091 & 5516092 MP 227.40 & MP 227.41	DATE: NOV. 2023
	TITLE OF DRAWING BEGIN ABUTMENT PROPOSED PLAN AND ELEVATION (EASTBOUND)	DRAWING NUMBER: ST-11



BEGIN ABUTMENT PLAN
(I-90 WESTBOUND)
SCALE: 1/8" = 1'-0"

- NOTES:**
1. SEE DWG. NO. ST-13 FOR SECTION B-B & REINFORCEMENT DETAILS.
 2. SEE DWG. NO. ST-13 FOR DETAILS.
 3. THE CONTRACTOR SHALL VERIFY THAT THE WEB OF THE GIRDERS ARE PLUMB. IF THE GIRDERS ARE ROTATED ABOUT THEIR LONGITUDINAL AXIS BY MORE THAN 1%, OR THE DIFFERENCE IN ELEVATION BETWEEN EACH EDGE OF THE BOTTOM FLANGE IS MORE THAN 1/8", THEN THE CONTRACTOR SHALL COORDINATE WITH THE BEARING MANUFACTURER TO DESIGN SOLE PLATES THAT ARE TAPERED IN THE TRANSVERSE DIRECTION.

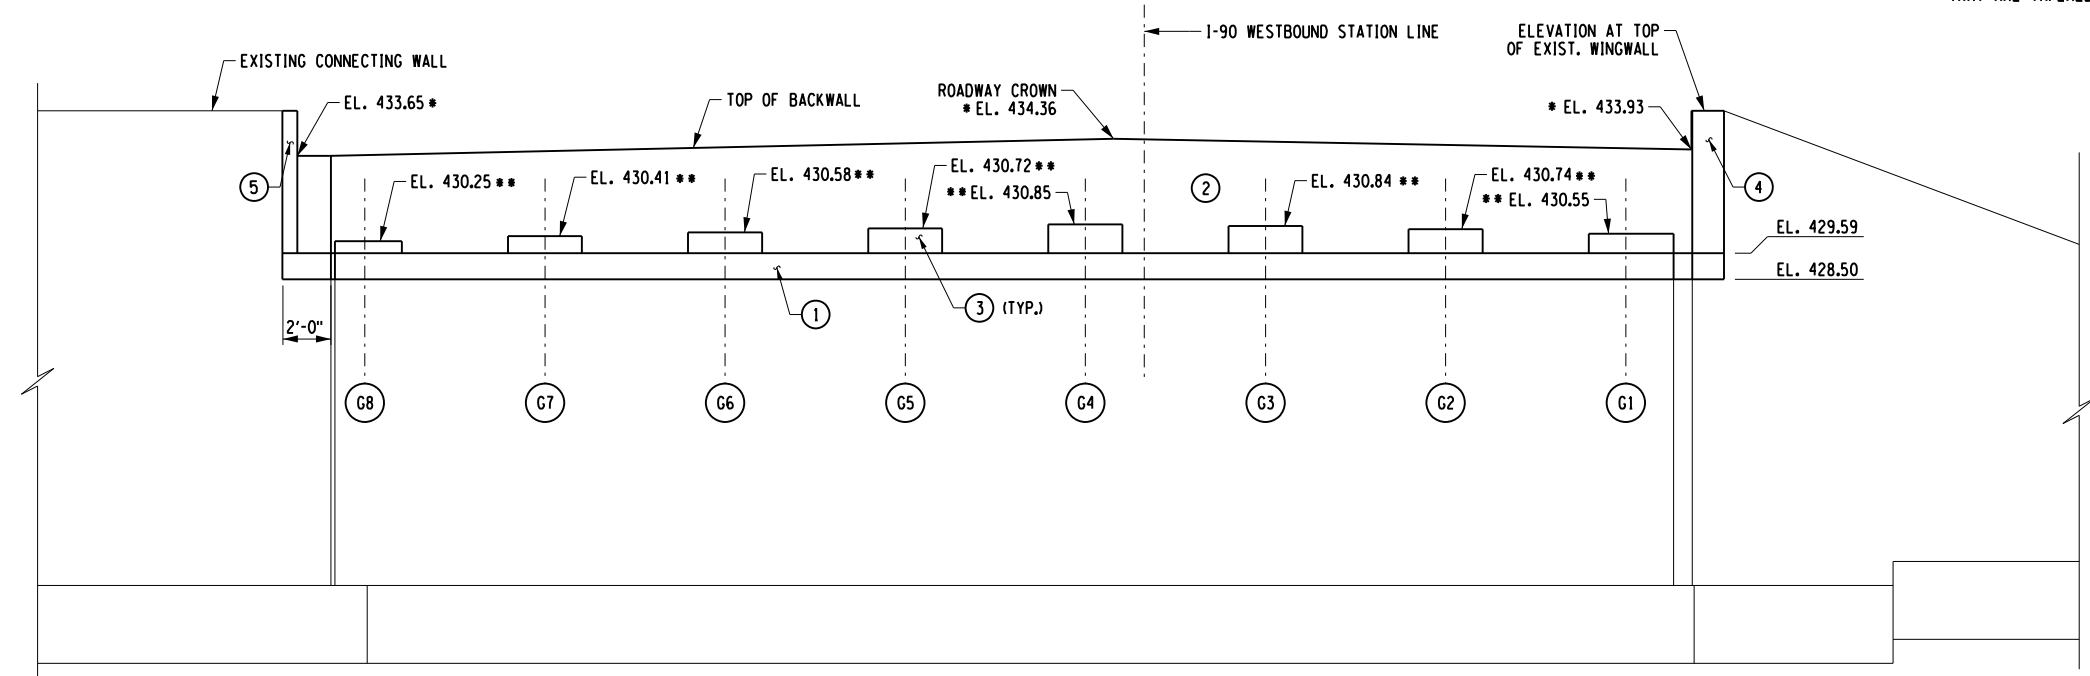

ELEVATION
(I-90 WESTBOUND)
SCALE: 1/8" = 1'-0"

- LEGEND**
- (G*) - DENOTES EXISTING GIRDER NUMBER
 - (NO.) DENOTES CONCRETE PLACEMENT NUMBER

CONCRETE TABLE		
PLACEMENT	QUANTITY	ITEM NO.
1	9.9 CY	555.09
2	14.8 CY	555.09
3	3.8 CY	555.09
4	0.5 CY	555.09
5	0.2 CY	555.09

- * ELEVATIONS GIVEN AT FRONT FACE OF BACKWALL
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REVISIONS			
DATE	DESCRIPTION	BY	SYM.




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LOCATION OF PROJECT SYRACUSE DIVISION BIN 5516091 & 5516092 MP 227.40 & MP 227.41	DATE: NOV. 2023
TITLE OF DRAWING BEGIN ABUTMENT PROPOSED PLAN AND ELEVATION (WESTBOUND)	DRAWING NUMBER: ST-12

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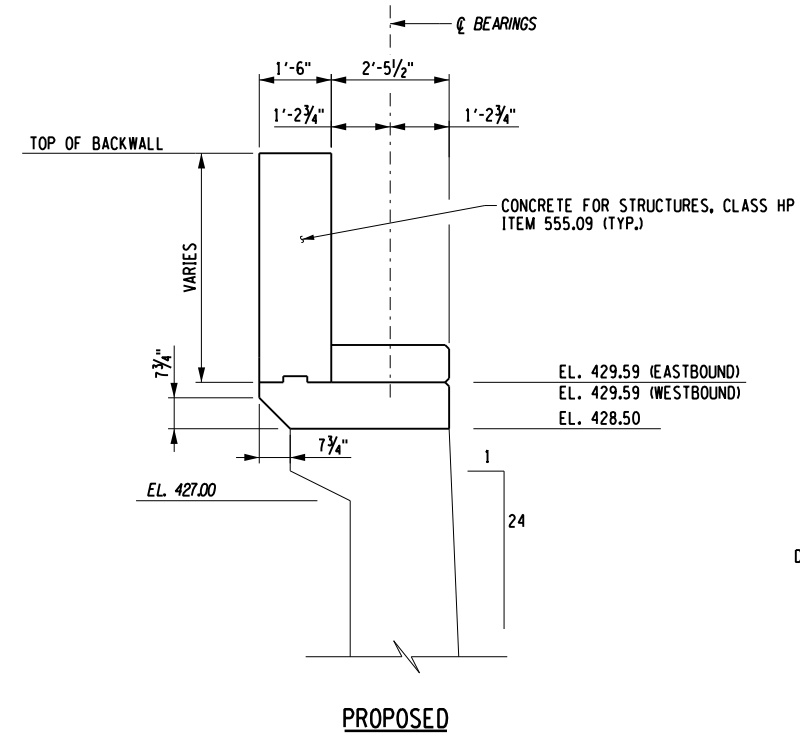
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CHECKED BY: N. BARNHARD
DRAFTED BY: T. LINDO
CHECKED BY: N. BARNHARD

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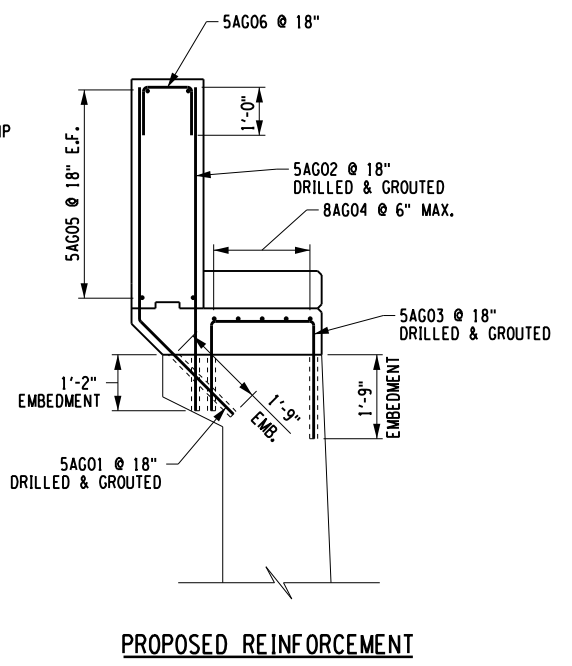
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 DESIGN SUPERVISOR: C. SICHAK
 DRAFTED BY: T. LINDO
 CHECKED BY: N. BARNHARD



SECTION A-A
(I-90 BEGIN ABUTMENT)
SCALE: 1/4" = 1'-0"

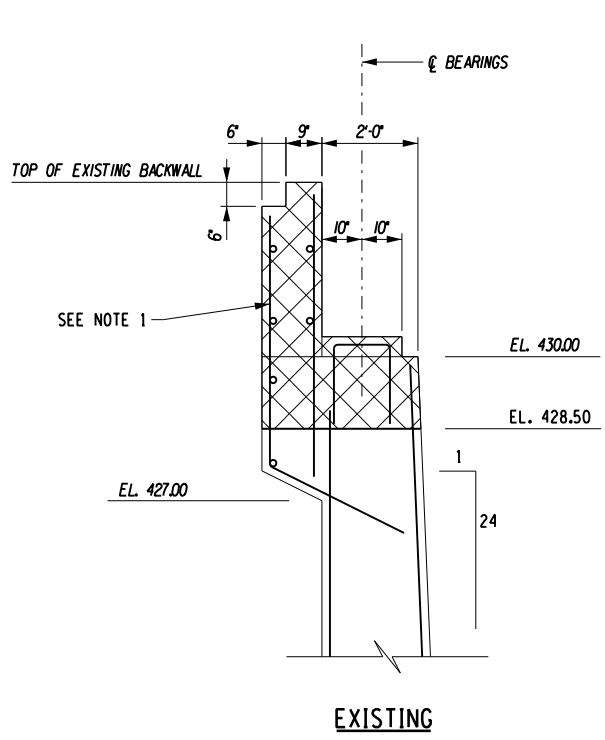


SECTION B-B
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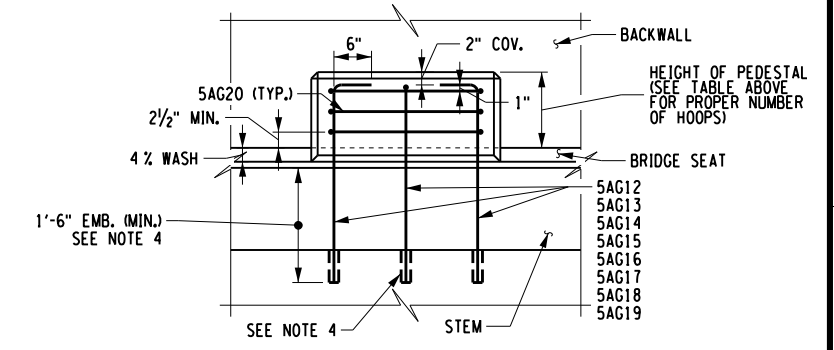


PROPOSED REINFORCEMENT

PEDESTAL HEIGHT	NUMBER OF HOOPS
6" TO 8"	1
8" TO 11"	2
11" TO 14"	3
14" TO 17"	4
17" TO 20"	5

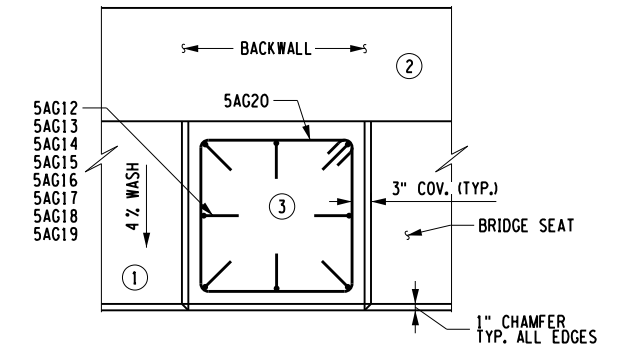

TYPICAL PEDESTAL PLAN



**TYPICAL PEDESTAL ELEVATION
PEDESTAL DETAILS**

NOTES:

- EXCEPT FOR POURS 4 AND 5, REMOVE ALL FULLY EXPOSED EXISTING REINFORCEMENT WITHIN THE LIMITS OF DEMOLITION. CUT ALL EXISTING VERTICAL REINFORCEMENT FLUSH TO CONCRETE REMOVAL LIMITS IN POURS 1, 2, AND 3. RETAIN EXISTING REINFORCEMENT IN POURS 4 AND 5 AND CUT TO PROVIDE 2" OF COVER.
- SAWCUT ALL CONCRETE REMOVAL LIMITS TO 1" DEEP ALONG ALL EDGES PRIOR TO CONCRETE REMOVAL.
- SEE DWG. NO.'S ST-9 THRU ST-12 FOR SECTION LOCATION.
- WHERE MINIMUM EMBEDMENT LENGTH CANNOT BE ACHIEVED IN CONCRETE, BARS SHALL BE DRILLED AND GROUTED INTO EXISTING CONCRETE IN ACCORDANCE WITH ITEM 586.0201.

LEGEND

REMOVAL OF STRUCTURAL CONCRETE, ITEM 580.01

ALTERED ON:	AFFIXED ON: 12/04/2023
SIGNATURE: STAMP:	SIGNATURE: STAMP:

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REVISIONS			
DATE	DESCRIPTION	BY	SYMBOL






TITLE OF PROJECT STERLING CREEK BRIDGE REHABILITATION	CONTRACT NUMBER: TAS 24-5B
LOCATION OF PROJECT SYRACUSE DIVISION BIN 5516091 & 5516092 MP 227.40 & MP 227.41	DATE: NOV. 2023
TITLE OF DRAWING BEGIN ABUTMENT DETAILS	DRAWING NUMBER: ST-13

NOTES:

1. SAWCUT ALL CONCRETE REMOVAL LIMITS TO 1" DEEP ALONG ALL EDGES PRIOR TO CONCRETE REMOVAL.
2. SEE DRAWING NO. ST-18 FOR SECTION C-C.
3. LOAD TABLES HAVE BEEN PROVIDED FOR THE LIFTING OPERATIONS OF THE EXISTING GIRDERS AND DIAPHRAGMS. THESE LOADS ARE BASED ON A SYMMETRICAL SUPPORT SYSTEM ABOUT THE LENGTH OF THE GIRDERS. IF THE SUPPORT SYSTEM IS NOT SYMMETRICAL, THE LOADS PROVIDED IN THE TABLES MUST BE RE-EVALUATED.
4. SEE CONCRETE REMOVAL DETAILS ON DRAWING NO. ST-19.
5. REFER TO "USACE NATIONWIDE PERMIT #3 MAINTENANCE" FOR WATERWAY DIVERSION AND IN-WATER WORK REQUIREMENTS.



LEGEND

-  REMOVAL OF STRUCTURAL CONCRETE, ITEM 580.01
-  REMOVAL OF STRUCTURAL CONCRETE - REPLACEMENT WITH CLASS D CONCRETE, ITEM 582.06
-  CRACK REPAIR BY EPOXY INJECTION (RESTORATION), ITEM 555.80020001

ABBR.	DESCRIPTION
(H)	HOLLOW
(HL)	HAIR LINE
(S)	SPALLED
(SC)	SCALING
(E)	EFFLORESCENCE
(MC)	MAP CRACKING
(CJ)	CONSTRUCTION JOINT


CONCRETE REMOVAL & REPAIR TABLE	
QUANTITY	ITEM NO.
24.2 CY	580.01
10.0 SF	582.06
19.0 LF	555.80020001

STRUCTURAL LIFTING LOAD TABLE	
GIRDER	LOAD (kip)
G9	10.949
G10	12.884
G11	12.884
G12	12.884
G13	12.884
G14	12.884
G15	12.884
G16	10.949

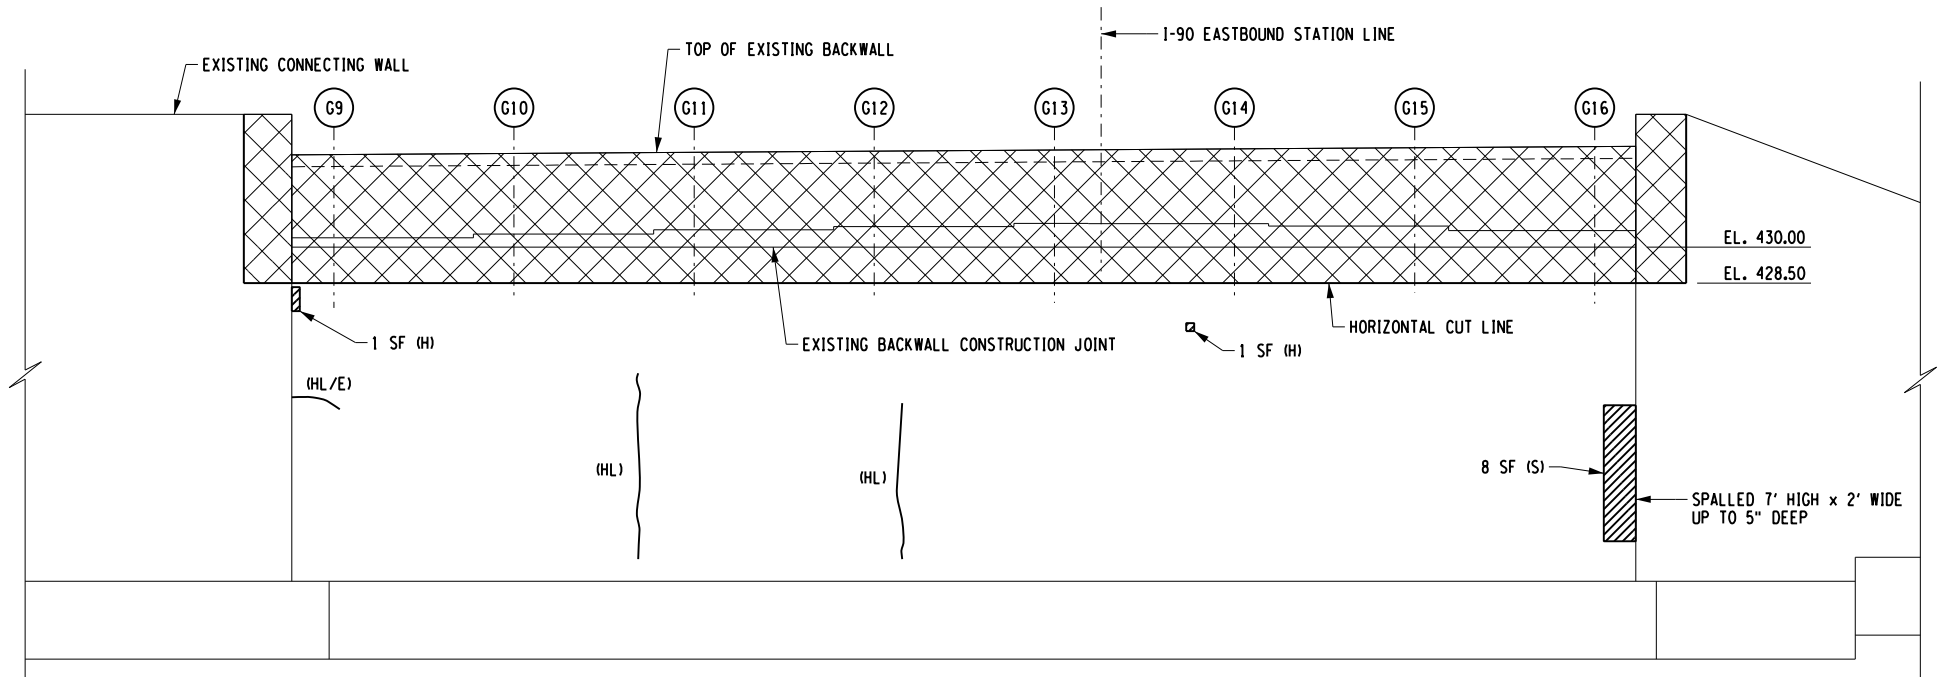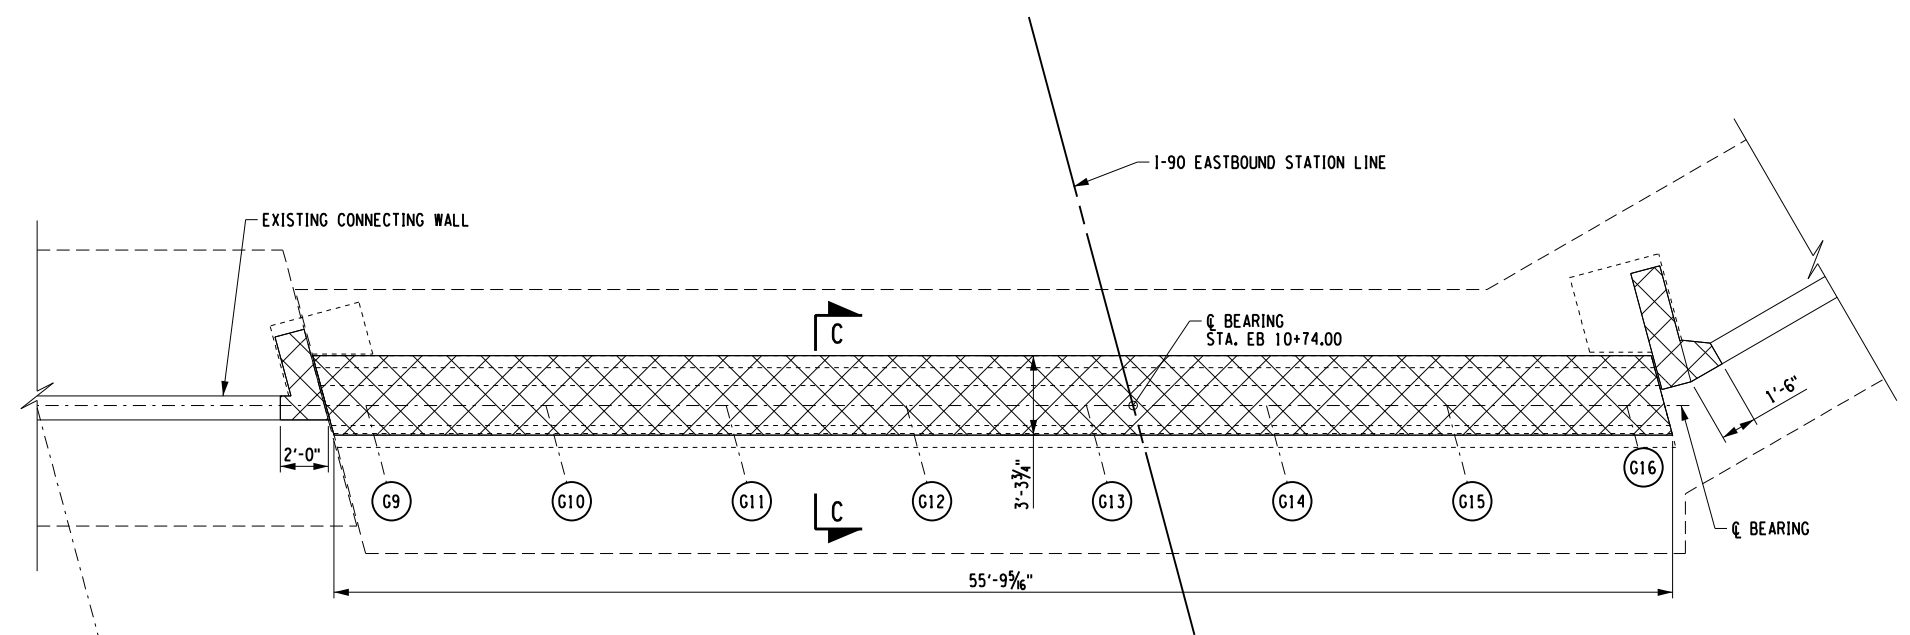




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 USER = L.lindo

DESIGN SUPERVISOR: C. SICHAK
 CHECKED BY: N. BARNHARD
 DRAFTED BY: T. LINDO

ALTERED ON:	AFFIXED ON: 12/04/2023
SIGNATURE: STAMP:	SIGNATURE: STAMP: 

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


REVISIONS			
DATE	DESCRIPTION	BY	SYM.

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	LOCATION OF PROJECT SYRACUSE DIVISION BIN 5516091 & 5516092 MP 227.40 & MP 227.41	DATE: NOV. 2023
	TITLE OF DRAWING END ABUTMENT DEMOLITION PLAN AND ELEVATION (EASTBOUND)	DRAWING NUMBER: ST-14

NOTES:

1. SAWCUT ALL CONCRETE REMOVAL LIMITS TO 1" DEEP ALONG ALL EDGES PRIOR TO CONCRETE REMOVAL.
2. SEE DRAWING NO. ST-18 FOR SECTION C-C.
3. LOAD TABLES HAVE BEEN PROVIDED FOR THE LIFTING OPERATIONS OF THE EXISTING GIRDERS AND DIAPHRAGMS. THESE LOADS ARE BASED ON A SYMMETRICAL SUPPORT SYSTEM ABOUT THE LENGTH OF THE GIRDERS. IF THE SUPPORT SYSTEM IS NOT SYMMETRICAL, THE LOADS PROVIDED IN THE TABLES MUST BE RE-EVALUATED.
4. SEE CONCRETE REMOVAL DETAILS ON DRAWING NO. ST-19.
5. REFER TO "USACE NATIONWIDE PERMIT #3 MAINTENANCE" FOR WATERWAY DIVERSION AND IN-WATER WORK REQUIREMENTS.


LEGEND

-  REMOVAL OF STRUCTURAL CONCRETE, ITEM 580.01
-  REMOVAL OF STRUCTURAL CONCRETE - REPLACEMENT WITH CLASS D CONCRETE, ITEM 580.06
-  CRACK REPAIR BY EPOXY INJECTION (RESTORATION), ITEM 555.80020001


ABBR.	DESCRIPTION
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(HL)	HAIR LINE
(S)	SPALLED
(SC)	SCAILING
(E)	EFFLORESCENCE
(MC)	MAP CRACKING
(CJ)	CONSTRUCTION JOINT

CONCRETE REMOVAL & REPAIR TABLE	
QUANTITY	ITEM NO.
24.2 CY	580.01
29.0 SF	582.06
38.0 LF	555.80020001

STRUCTURAL LIFTING LOAD TABLE	
GIRDER	LOAD (kip)
G1	10.949
G2	12.884
G3	12.884
G4	12.884
G5	12.884
G6	12.884
G7	12.884
G8	10.949

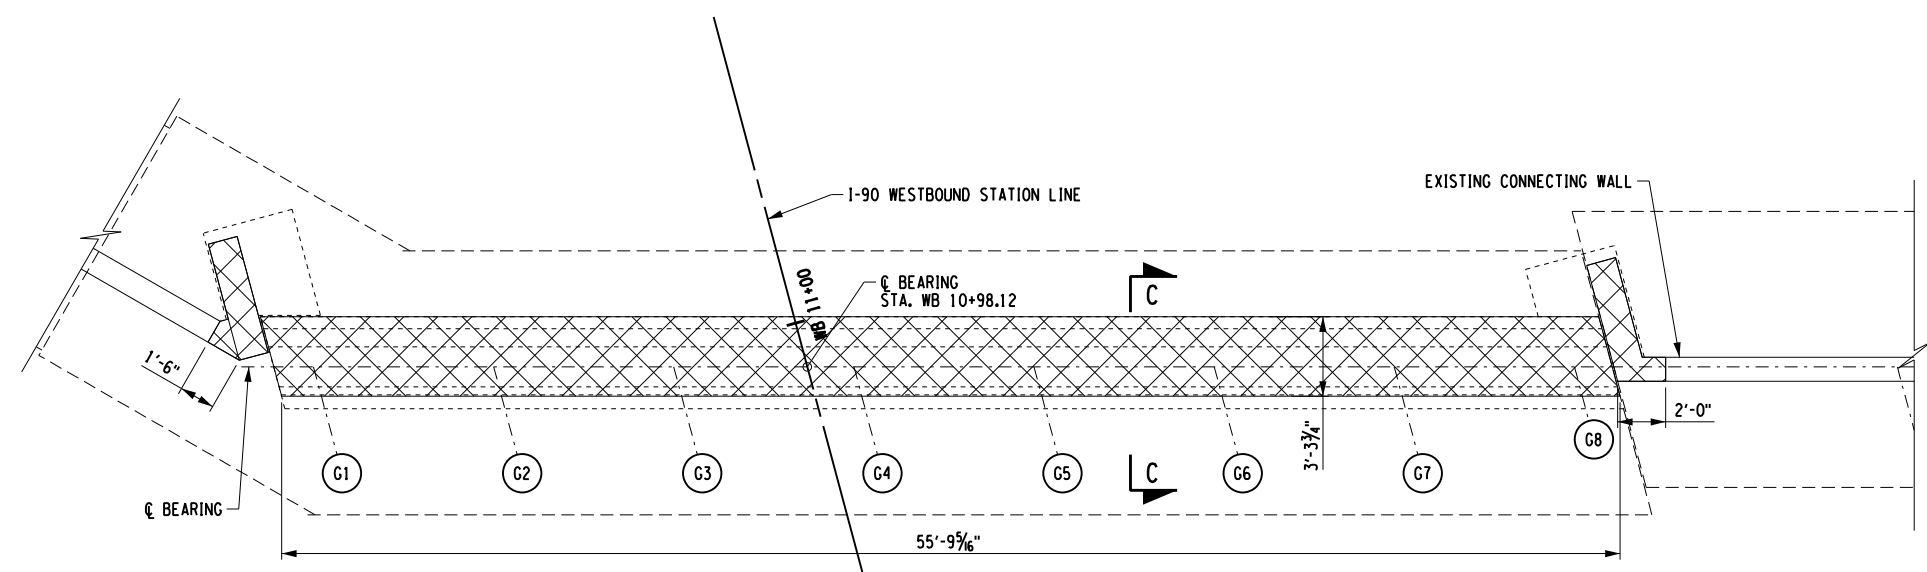

END ABUTMENT PLAN
(I-90 WESTBOUND)
SCALE: 1/8" = 1'-0"

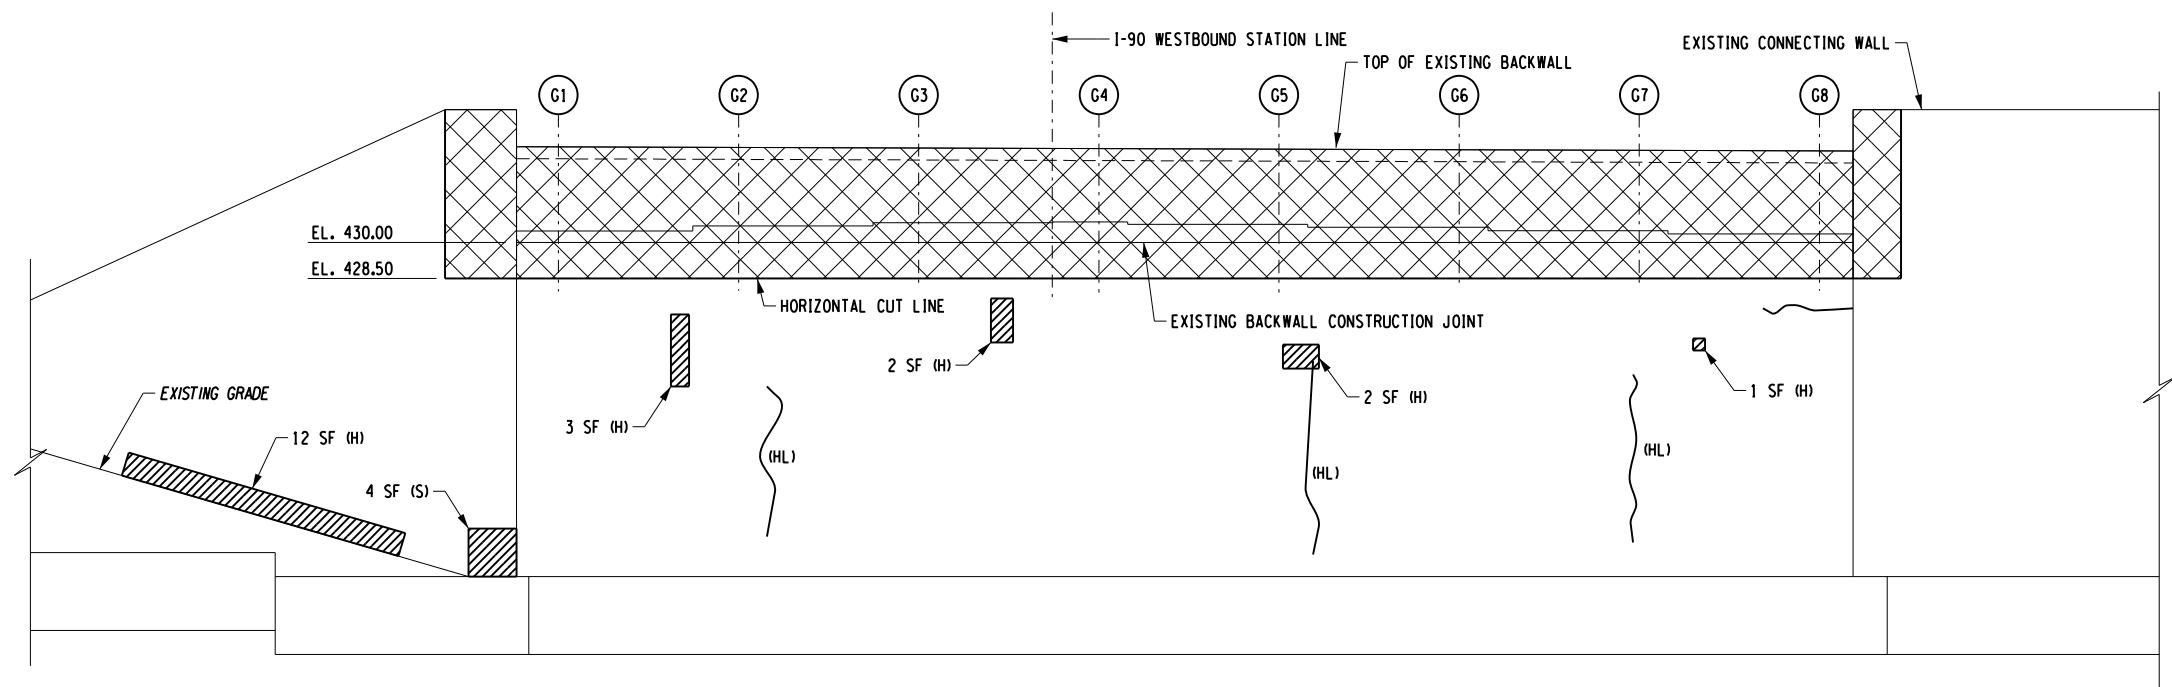


ELEVATION
(I-90 WESTBOUND)
SCALE: 1/8" = 1'-0"

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
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 CHECKED BY: N. BARNHARD
 DRAFTED BY: T. LINDO

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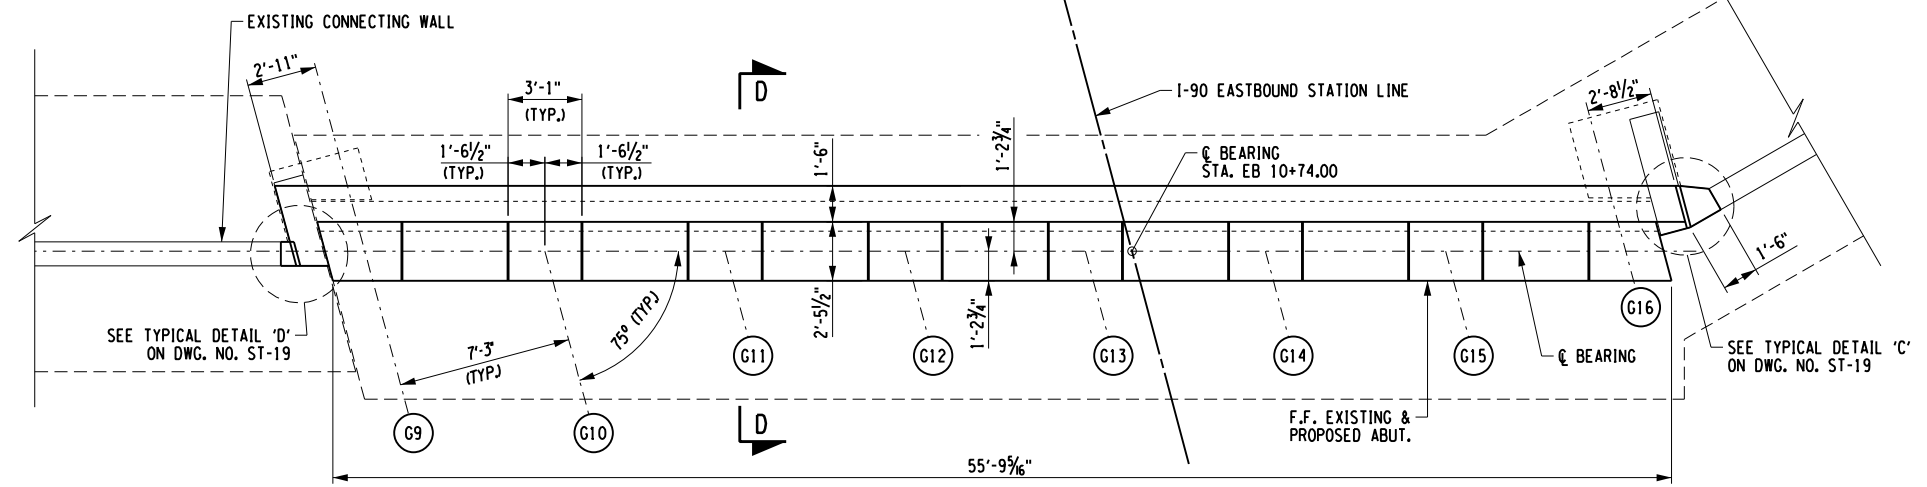
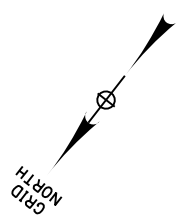
IT IS A VIOLATION OF LAW FOR ANY PERSON, UNLESS THEY ARE ACTING UNDER THE DIRECTION OF A LICENSED PROFESSIONAL ENGINEER, ARCHITECT, LANDSCAPE ARCHITECT, OR LAND SURVEYOR, TO ALTER AN ITEM IN ANY WAY. IF AN ITEM BEARING THE STAMP OF A LICENSED PROFESSIONAL IS ALTERED, THE ALTERING ENGINEER, ARCHITECT, LANDSCAPE ARCHITECT, OR LAND SURVEYOR SHALL STAMP THE DOCUMENT AND INCLUDE THE NOTATION "ALTERED BY" FOLLOWED BY THEIR SIGNATURE, THE DATE OF SUCH ALTERATION, AND A SPECIFIC DESCRIPTION OF THE ALTERATION.

REVISIONS			
DATE	DESCRIPTION	BY	SYM.


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	LOCATION OF PROJECT SYRACUSE DIVISION BIN 5516091 & 5516092 MP 227.40 & MP 227.41	DATE: NOV. 2023
TITLE OF DRAWING END ABUTMENT DEMOLITION PLAN AND ELEVATION (WESTBOUND)	DRAWING NUMBER: ST-15	

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USER = L.lindo

DESIGNED BY: C. SICHAK
CHECKED BY: N. BARNHARD
DRAFTED BY: T. LINDO
CHECKED BY: N. BARNHARD



END ABUTMENT PLAN
(I-90 EASTBOUND)
SCALE: 1/8" = 1'-0"

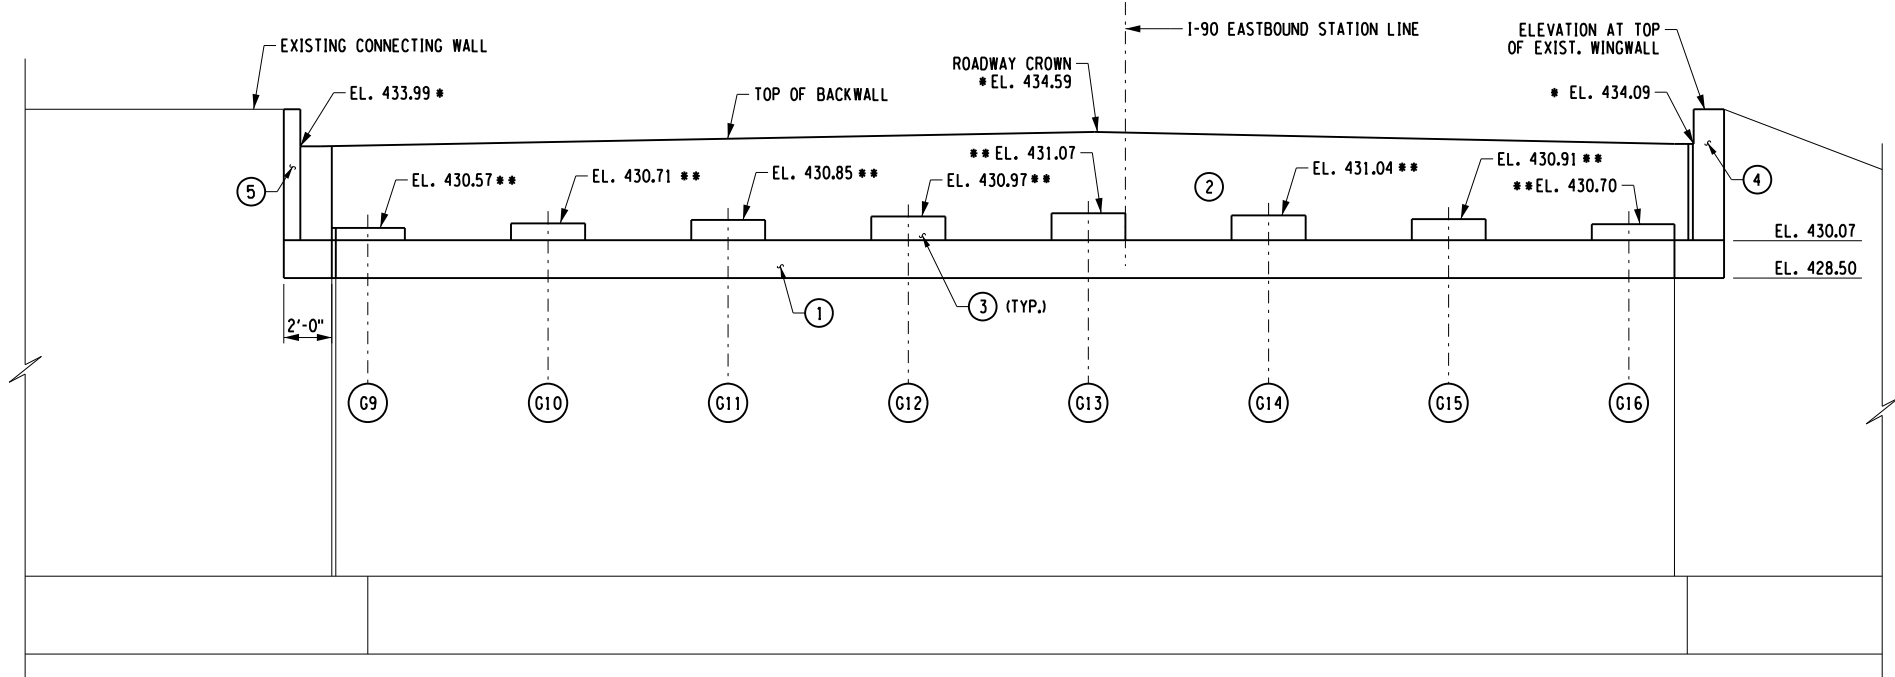

ELEVATION
(I-90 EASTBOUND)
SCALE: 1/8" = 1'-0"

* ELEVATIONS GIVEN AT FRONT FACE OF BACKWALL
** THESE ELEVATIONS MAY HAVE TO BE ADJUSTED TO ACCOMMODATE THE ACTUAL BEARINGS FURNISHED. IT IS THE RESPONSIBILITY OF THE CONTRACTOR TO COORDINATE ANY CHANGES IN THE BEARINGS WHICH MAY AFFECT THE PEDESTAL ELEVATIONS.

- NOTES:**
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 - SEE DWG. NO. ST-18 FOR DETAILS.
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- LEGEND**
- G* - DENOTES EXISTING GIRDER NUMBER
 - (NO) - DENOTES CONCRETE PLACEMENT NUMBER

CONCRETE TABLE		
PLACEMENT	QUANTITY	ITEM NO.
1	14.2 CY	555.09
2	14.0 CY	555.09
3	2.9 CY	555.09
4	0.5 CY	555.09
5	0.2 CY	555.09

ALTERED ON:	AFFIXED ON: 12/04/2023
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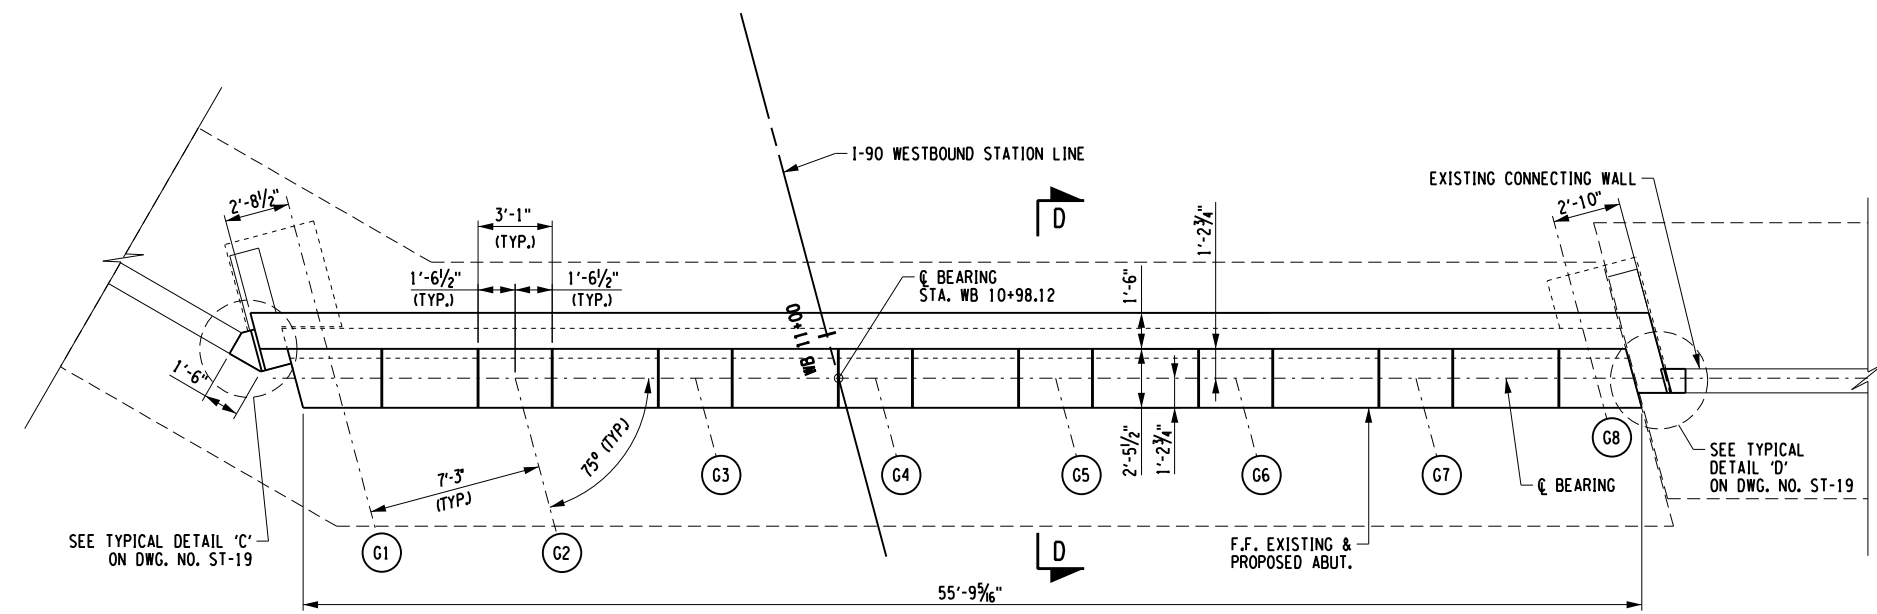
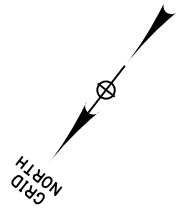
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REVISIONS			
DATE	DESCRIPTION	BY	SYM.


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	LOCATION OF PROJECT SYRACUSE DIVISION BIN 5516091 & 5516092 MP 227.40 & MP 227.41	DATE: NOV. 2023
	TITLE OF DRAWING END ABUTMENT PROPOSED PLAN AND ELEVATION (EASTBOUND)	DRAWING NUMBER: ST-16

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USER = L.lindo

DESIGNED BY: C. SICHAK
CHECKED BY: N. BARNHARD
DRAFTED BY: T. LINDO
CHECKED BY: N. BARNHARD



END ABUTMENT PLAN
(I-90 WESTBOUND)
SCALE: 1/8" = 1'-0"

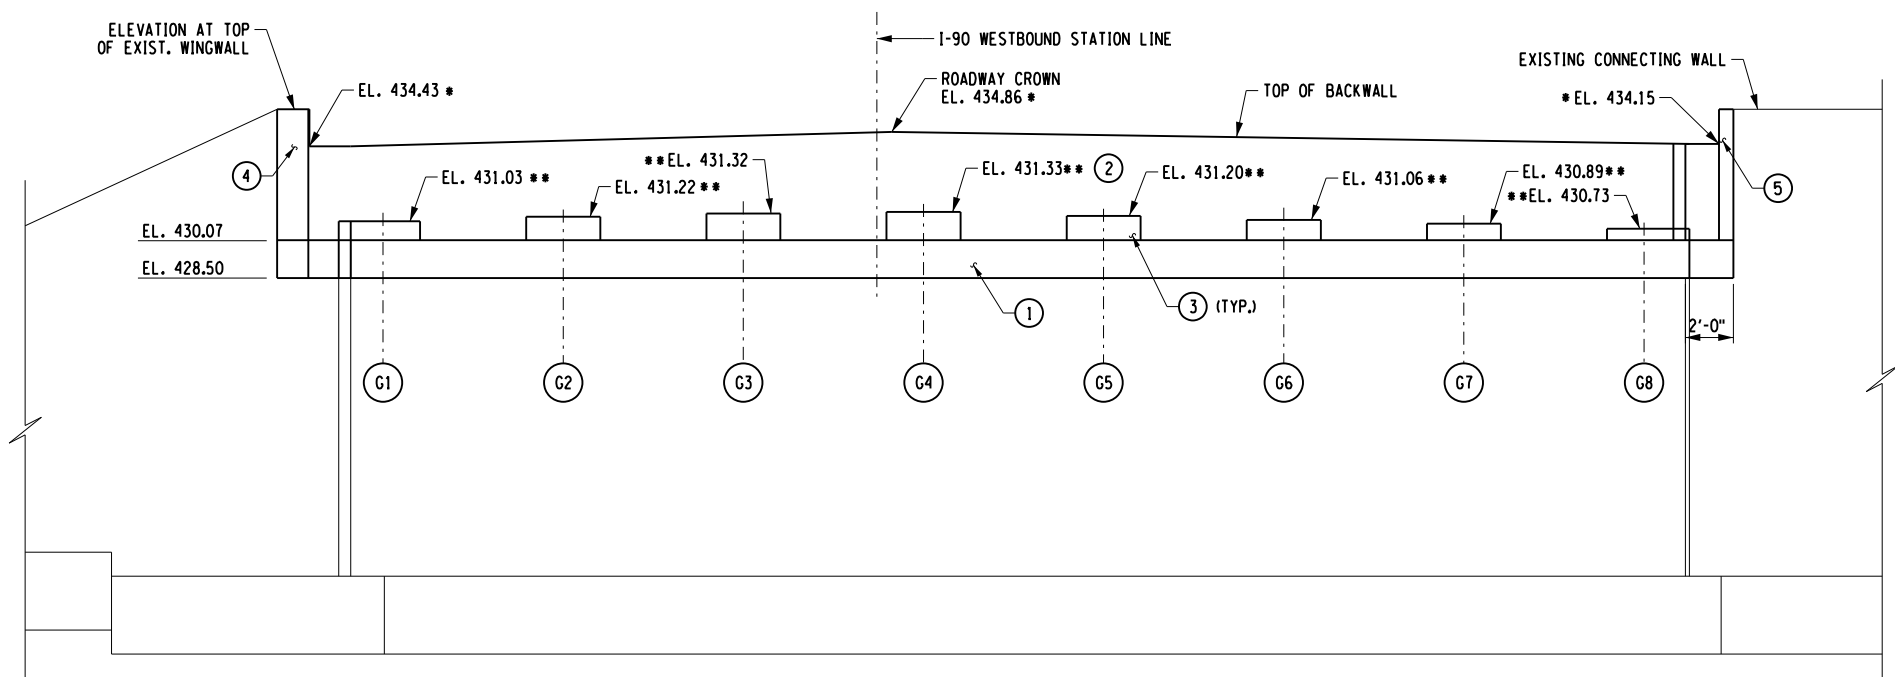

ELEVATION
(I-90 WESTBOUND)
SCALE: 1/8" = 1'-0"

NOTES:

- SEE DWG. NO. ST-18 FOR SECTION D-D & REINFORCEMENT DETAILS.
- SEE DWG. NO. ST-18 FOR DETAILS.
- THE CONTRACTOR SHALL VERIFY THAT THE WEB OF THE GIRDERS ARE PLUMB. IF THE GIRDERS ARE ROTATED ABOUT THEIR LONGITUDINAL AXIS BY MORE THAN 1%, OR THE DIFFERENCE IN ELEVATION BETWEEN EACH EDGE OF THE BOTTOM FLANGE IS MORE THAN 1/8", THEN THE CONTRACTOR SHALL COORDINATE WITH THE BEARING MANUFACTURER TO DESIGN SOLE PLATES THAT ARE TAPERED IN THE TRANSVERSE DIRECTION.

LEGEND

- (G*) - DENOTES EXISTING GIRDER NUMBER
- (NO) - DENOTES CONCRETE PLACEMENT NUMBER

CONCRETE TABLE		
PLACEMENT	QUANTITY	ITEM NO.
1	14.2 CY	555.09
2	14.9 CY	555.09
3	3.8 CY	555.09
4	0.4 CY	555.09
5	0.2 CY	555.09


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SIGNATURE: STAMP:	SIGNATURE: STAMP:

IT IS A VIOLATION OF LAW FOR ANY PERSON, UNLESS THEY ARE ACTING UNDER THE DIRECTION OF A LICENSED PROFESSIONAL ENGINEER, ARCHITECT, LANDSCAPE ARCHITECT, OR LAND SURVEYOR, TO ALTER AN ITEM IN ANY WAY. IF AN ITEM BEARING THE STAMP OF A LICENSED PROFESSIONAL IS ALTERED, THE ALTERING ENGINEER, ARCHITECT, LANDSCAPE ARCHITECT, OR LAND SURVEYOR SHALL STAMP THE DOCUMENT AND INCLUDE THE NOTATION "ALTERED BY" FOLLOWED BY THEIR SIGNATURE. THE DATE OF SUCH ALTERATION, AND A SPECIFIC DESCRIPTION OF THE ALTERATION.


REVISIONS			
DATE	DESCRIPTION	BY	SYM.

 Thruway Authority	TITLE OF PROJECT STERLING CREEK BRIDGE REHABILITATION	CONTRACT NUMBER: TAS 24-5B
	LOCATION OF PROJECT SYRACUSE DIVISION BIN 5516091 & 5516092 MP 227.40 & MP 227.41	DATE: NOV. 2023
	TITLE OF DRAWING END ABUTMENT PROPOSED PLAN AND ELEVATION (WESTBOUND)	DRAWING NUMBER: ST-17


CHECKED BY: N. BARNHARD
 DRAFTED BY: T. LINDO
 CHECKED BY: N. BARNHARD
 DESIGNED BY: C. SICHAK

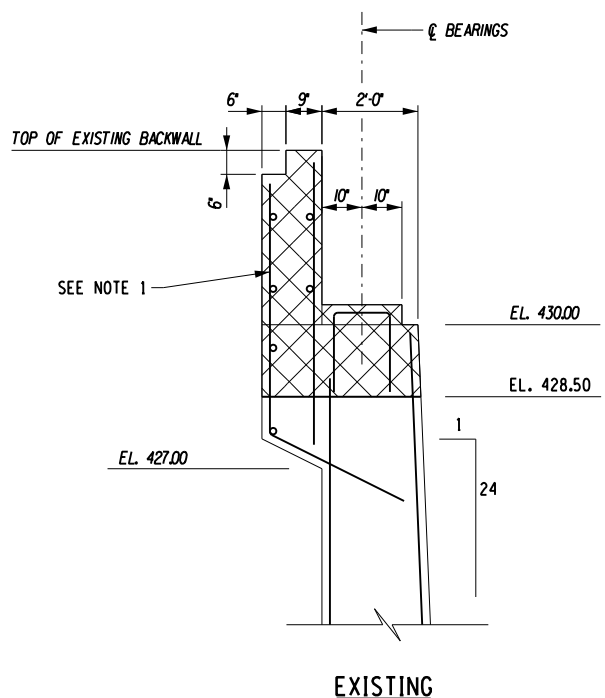

SECTION C-C
(1-90 END ABUTMENT)
SCALE: 1/4" = 1'-0"

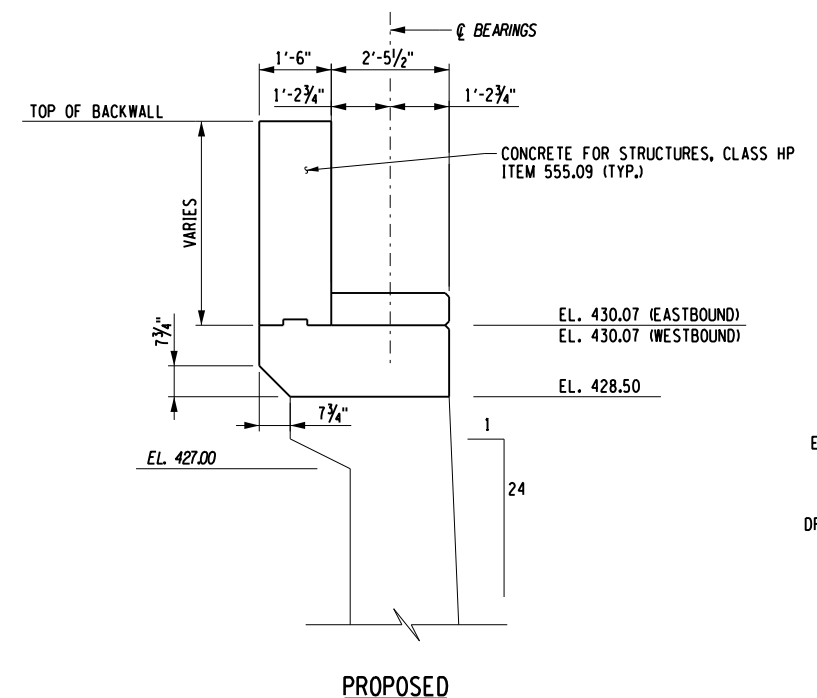


SECTION D-D
(1-90 END ABUTMENT)
SCALE: 1/4" = 1'-0"

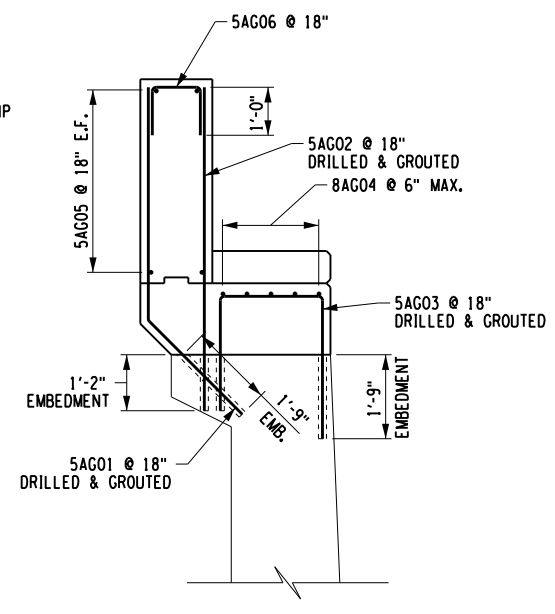


PROPOSED REINFORCEMENT

PEDESTAL HEIGHT	NUMBER OF HOOPS
6" TO 8"	1
8" TO 11"	2
11" TO 14"	3
14" TO 17"	4
17" TO 20"	5

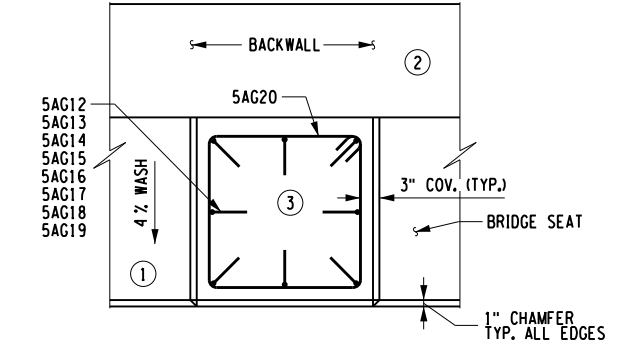

TYPICAL PEDESTAL PLAN

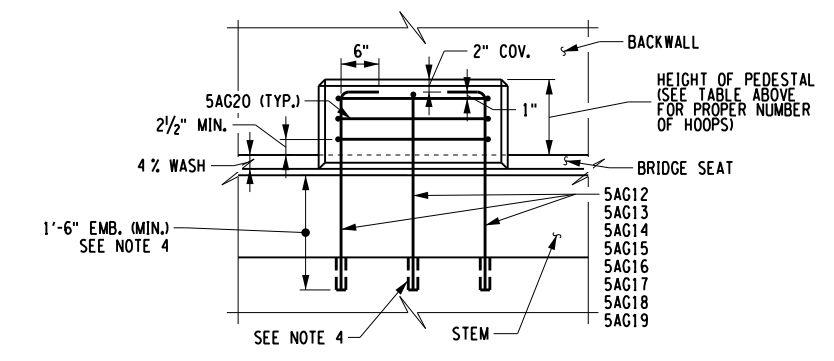

TYPICAL PEDESTAL ELEVATION
PEDESTAL DETAILS

NOTES:

- EXCEPT FOR POURS 4 AND 5, REMOVE ALL FULLY EXPOSED EXISTING REINFORCEMENT WITHIN THE LIMITS OF DEMOLITION. CUT ALL EXISTING VERTICAL REINFORCEMENT FLUSH TO CONCRETE REMOVAL LIMITS IN POURS 1, 2, AND 3. RETAIN EXISTING REINFORCEMENT IN POURS 4 AND 5 AND CUT TO PROVIDE 2" OF COVER.
- SAWCUT ALL CONCRETE REMOVAL LIMITS TO 1" DEEP ALONG ALL EDGES PRIOR TO CONCRETE REMOVAL.
- SEE DWG. NO.'S ST-14 THRU ST-17 FOR SECTION LOCATION.
- WHERE MINIMUM EMBEDMENT LENGTH CANNOT BE ACHIEVED IN CONCRETE, BARS SHALL BE DRILLED AND GROUTED INTO EXISTING CONCRETE IN ACCORDANCE WITH ITEM 586.0201.

LEGEND

REMOVAL OF STRUCTURAL CONCRETE, ITEM 580.01

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REVISIONS			
DATE	DESCRIPTION	BY	SYM.

 Thruway Authority	TITLE OF PROJECT STERLING CREEK BRIDGE REHABILITATION	CONTRACT NUMBER: TAS 24-5B
	LOCATION OF PROJECT SYRACUSE DIVISION BIN 5516091 & 5516092 MP 227.40 & MP 227.41	DATE: NOV. 2023
	TITLE OF DRAWING END ABUTMENT DETAILS	DRAWING NUMBER: ST-18

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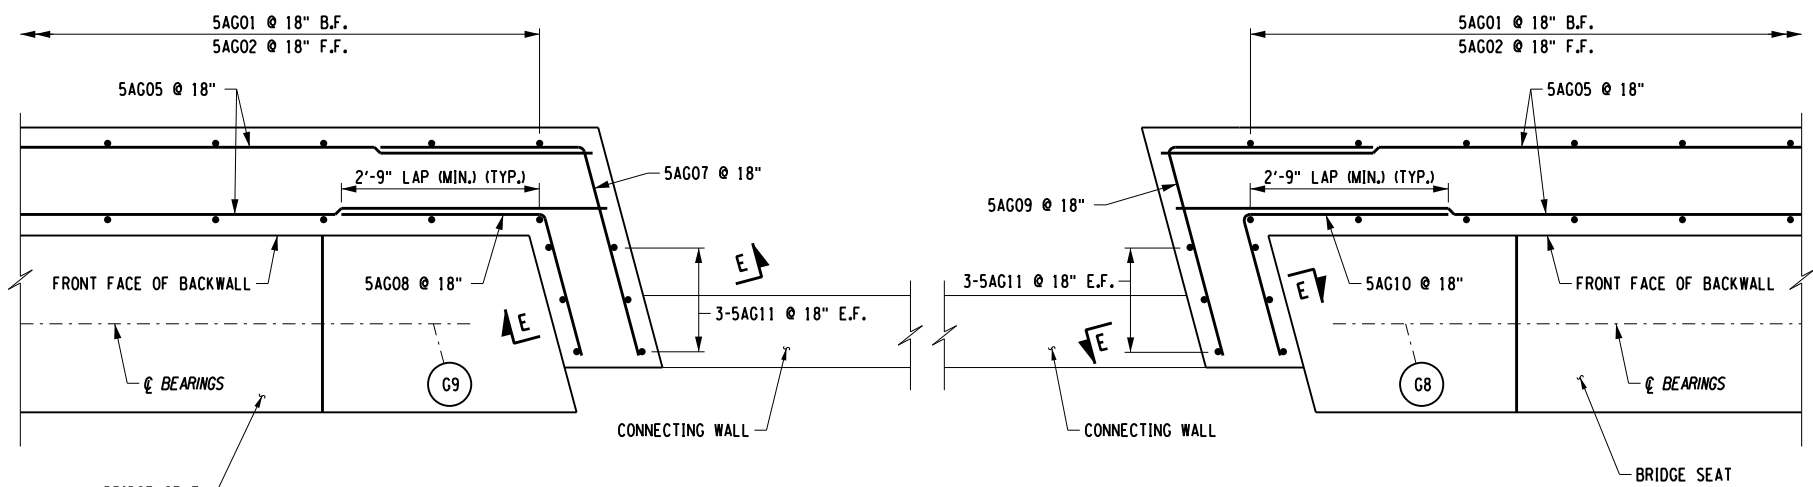
CHECKED BY: N. BARNHARD

DRAFTED BY: T. LINDO


CHECKED BY: N. BARNHARD

DESIGNED BY: C. SICHAK


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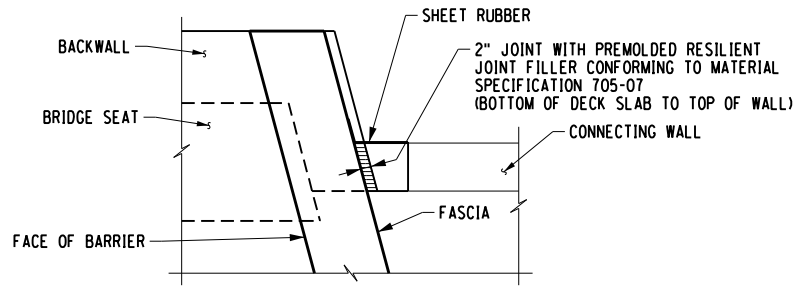
PARTIAL BACWALL REINFORCING PLAN
BEGIN ABUTMENT SHOWN, END ABUTMENT SIMILAR
NOT TO SCALE




SECTION E-E
NOT TO SCALE

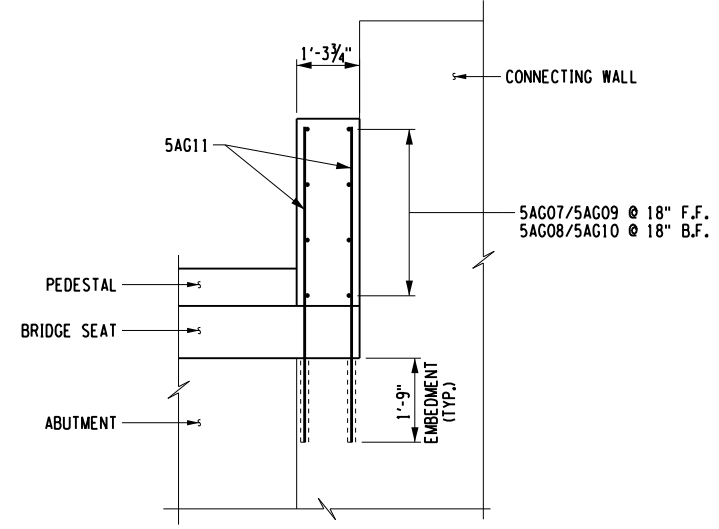


DETAIL 'C'
(TYPICAL AT EACH WINGWALL LOCATION)
NOT TO SCALE

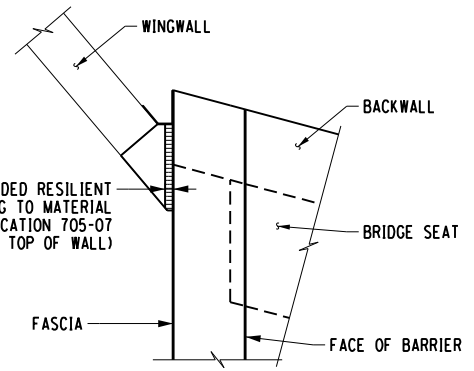

DETAIL 'D'
(TYPICAL AT EACH CONNECTING WALL LOCATION)
NOT TO SCALE

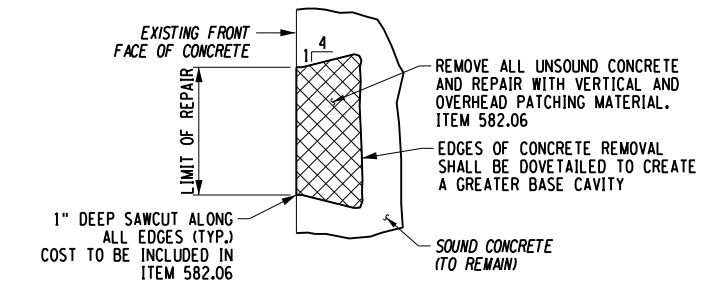

TYPICAL VERTICAL SURFACE REMOVAL DETAIL D < 1/2"
NOT TO SCALE

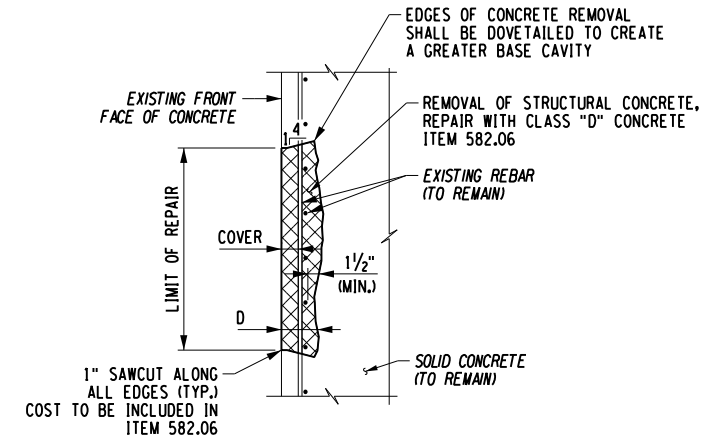

TYPICAL VERTICAL SURFACE REMOVAL DETAIL D > 1/2"
NOT TO SCALE
REMOVE AND REPAIR DETAILS
(SEE NOTE 3)

REPAIR NOTES:


- UNLESS OTHERWISE NOTED, SAWCUT ALL CONCRETE REMOVAL LIMITS 1" MINIMUM ALONG ALL EDGES PRIOR TO CONCRETE REMOVAL. COST INCLUDED UNDER REMOVAL ITEM.
- LIMITS OF ITEM 582.06 ARE DETERMINED BASED ON CONDITIONS NOTED IN FIELD INSPECTION AND REPORTS. THE CONTRACTOR SHALL MARK OUT ALL REPAIR LIMITS FOR APPROVAL BY THE ENGINEER PRIOR TO COMMENCING THE WORK. ALL WORK SHALL BE ABOVE THE WATER LEVEL AT THE TIME OF CONSTRUCTION AS ORDERED BY THE ENGINEER. NO BELOW WATER WORK OR INSTALLATION OF COFFERDAMS IS REQUIRED FOR THIS WORK.
- THE TYPE OF CONCRETE REPAIR MATERIAL TO BE USED SHALL BE AS SPECIFIED UNDER ITEM 582.06 OR AS ORDERED BY THE ENGINEER.
- THE CONTRACTOR SHALL REPLACE ALL REBAR THAT EXHIBITS 50% OR MORE OF SECTION LOSS UPON REMOVAL OF THE CONCRETE, OR AS ORDERED BY THE ENGINEER. PAID FOR UNDER ITEM 556.0202.

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REVISIONS			
DATE	DESCRIPTION	BY	SYM.

 Thruway Authority	TITLE OF PROJECT STERLING CREEK BRIDGE REHABILITATION	CONTRACT NUMBER: TAS 24-5B
	LOCATION OF PROJECT SYRACUSE DIVISION BIN 5516091 & 5516092 MP 227.40 & MP 227.41	DATE: NOV. 2023
	TITLE OF DRAWING COMMON DETAILS	DRAWING NUMBER: ST-19



STRUCTURAL SLAB REINFORCEMENT PLAN
SCALE: 1" = 10'

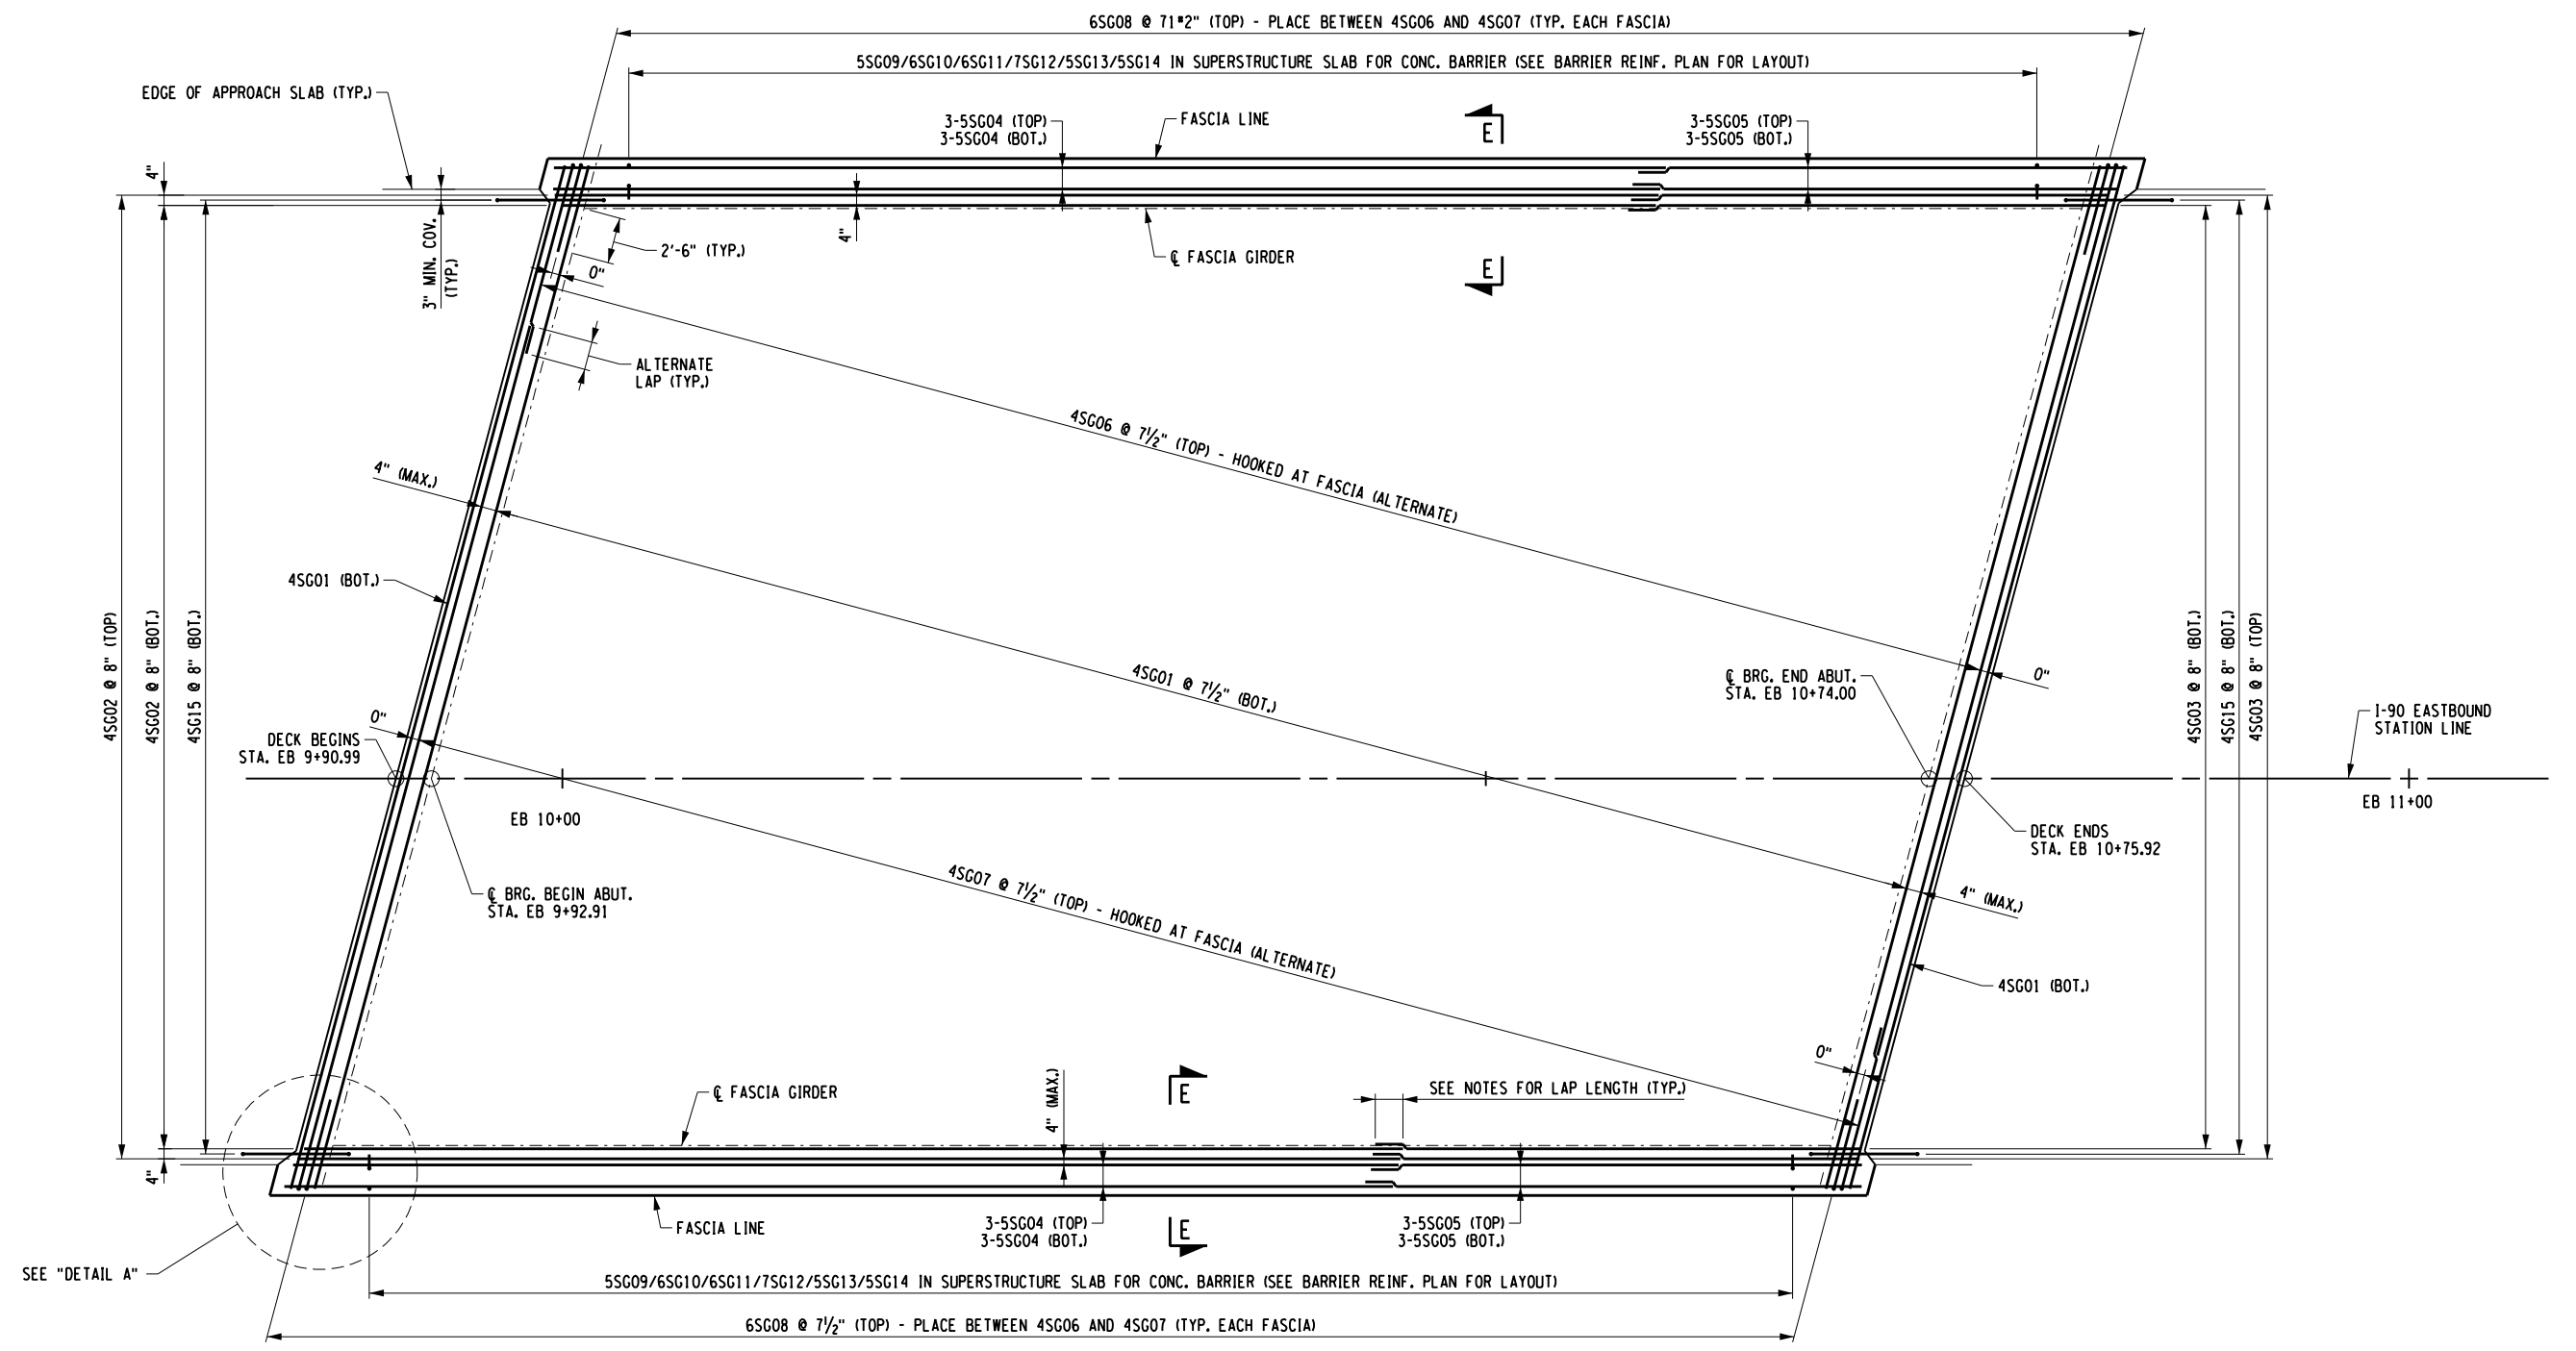NOTES:

1. SEE DWG. NO. ST-24 FOR SECTION E-E.
2. SEE DWG. NO. ST-24 FOR DETAIL A.
3. (G) DENOTES GALVANIZED COATED BARS
4. LAP LENGTH OF A #4 BAR = 1'-11"
5. LAP LENGTH OF A #5 BAR = 2'-4"
6. LAP LENGTH OF A #7 BAR = 3'-3"

FILE NAME = N:\19710-05-Sterling\Drawings\Structures\B2221-cpb.s lb.-sup.EB.dgn
 DATE/TIME = 12/4/2023 3:20:35 PM
 USER = L.LINDO

DESIGN SUPERVISOR: C. SICHAK
 CHECKED BY: N. BARNHARD
 DRAFTED BY: T. LINDO
 CHECKED BY: N. BARNHARD

ALTERED ON:	AFFIXED ON: 12/04/2023
SIGNATURE: STAMP:	SIGNATURE: STAMP:

CHRISTOPHER GEORGE SORAK
LICENSED PROFESSIONAL ENGINEER
084524

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REVISIONS			
DATE	DESCRIPTION	BY	SYM.


NEW YORK STATE OF OPPORTUNITY
Thruway Authority

ERDMAN ANTHONY

TITLE OF PROJECT STERLING CREEK BRIDGE REHABILITATION	CONTRACT NUMBER: TAS 24-5B
LOCATION OF PROJECT SYRACUSE DIVISION BIN 5516091 & 5516092 MP 227.40 & MP 227.41	DATE: NOV. 2023
TITLE OF DRAWING DECK SLAB PLAN (EASTBOUND)	DRAWING NUMBER: ST-20

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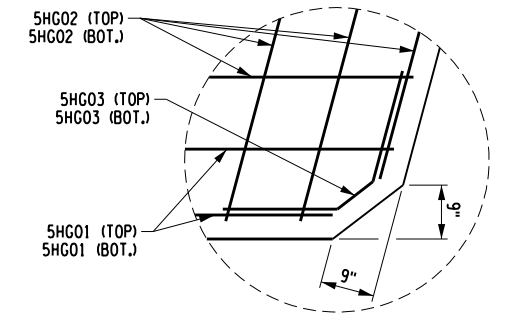
DESIGNED BY: C. SICHAK
DRAFTED BY: T. LINDO
CHECKED BY: N. BARNHARD

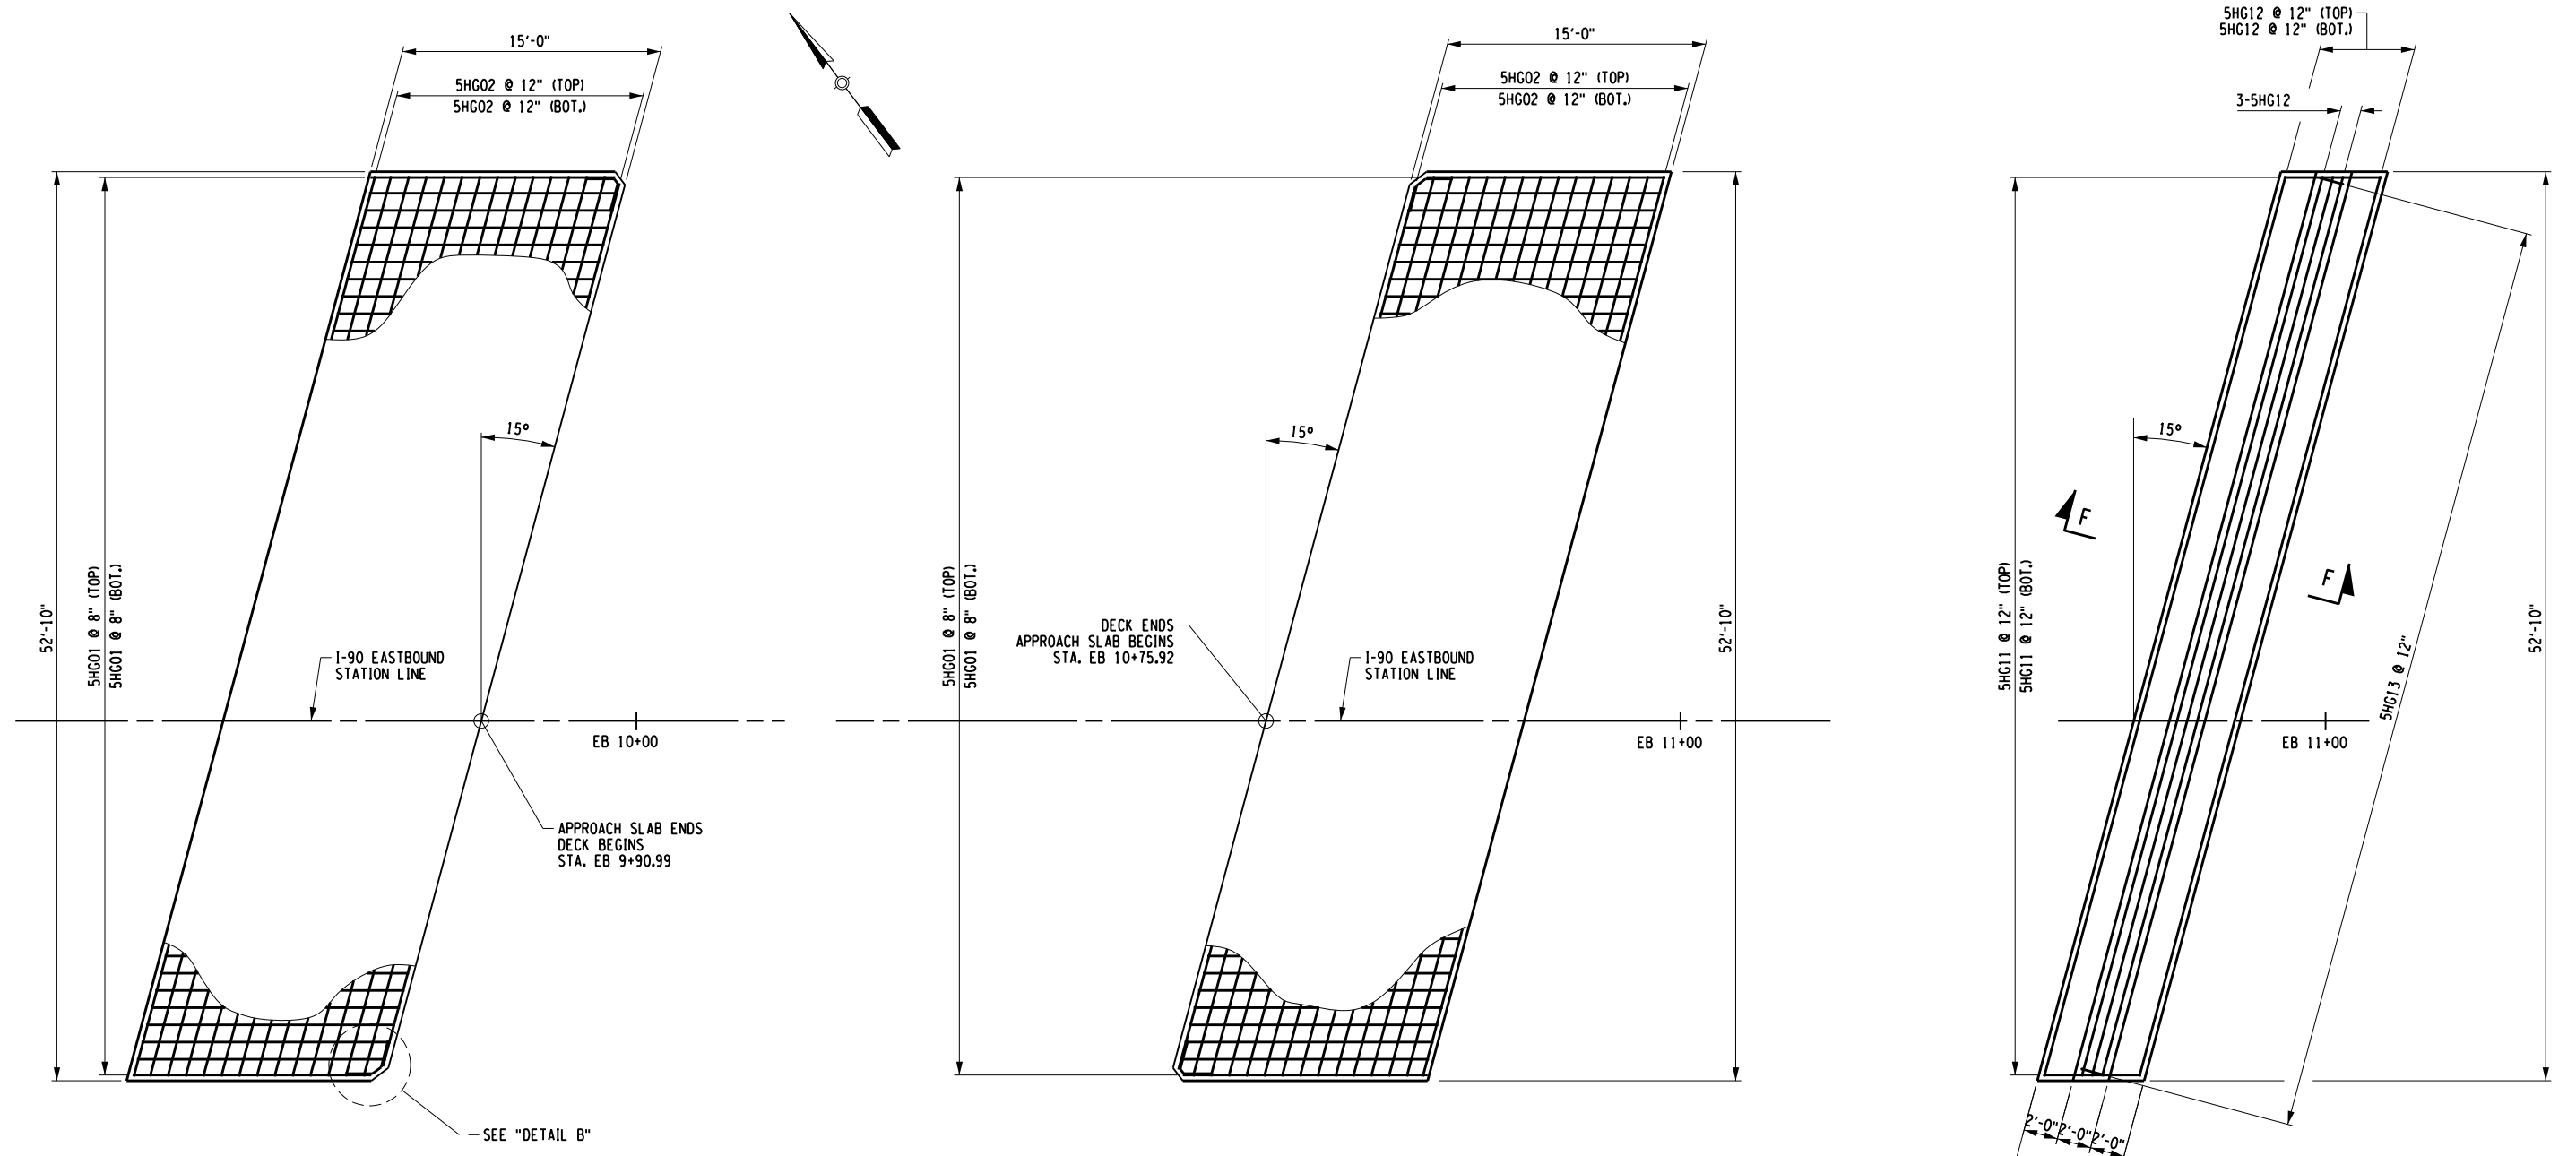

BEGIN APPROACH SLAB
(EASTBOUND)
SCALE: 1" = 10'

END APPROACH SLAB
(EASTBOUND)
SCALE: 1" = 10'

END APPROACH SLEEPER SLAB
(EASTBOUND)
SCALE: 1" = 10'



DETAIL "B"
NOT TO SCALE

NOTES:


1. ALL REINFORCEMENT SHALL HAVE 3 IN. COVER UNLESS OTHERWISE NOTED.
2. SLEEPER SLAB REINFORCEMENT NOT SHOWN FOR CLARITY.
3. SEE DWG. NO. ST-25 FOR SECTION F-F.
4. (G) DENOTES GALVANIZED COATED BARS

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REVISIONS			
DATE	DESCRIPTION	BY	SYM.

	TITLE OF PROJECT STERLING CREEK BRIDGE REHABILITATION	CONTRACT NUMBER: TAS 24-5B
	LOCATION OF PROJECT SYRACUSE DIVISION BIN 5516091 & 5516092 MP 227.40 & MP 227.41	DATE: NOV. 2023
	TITLE OF DRAWING APPROACH SLAB PLAN (EASTBOUND)	DRAWING NUMBER: ST-21



STRUCTURAL SLAB REINFORCEMENT PLAN
SCALE: 1" = 10'

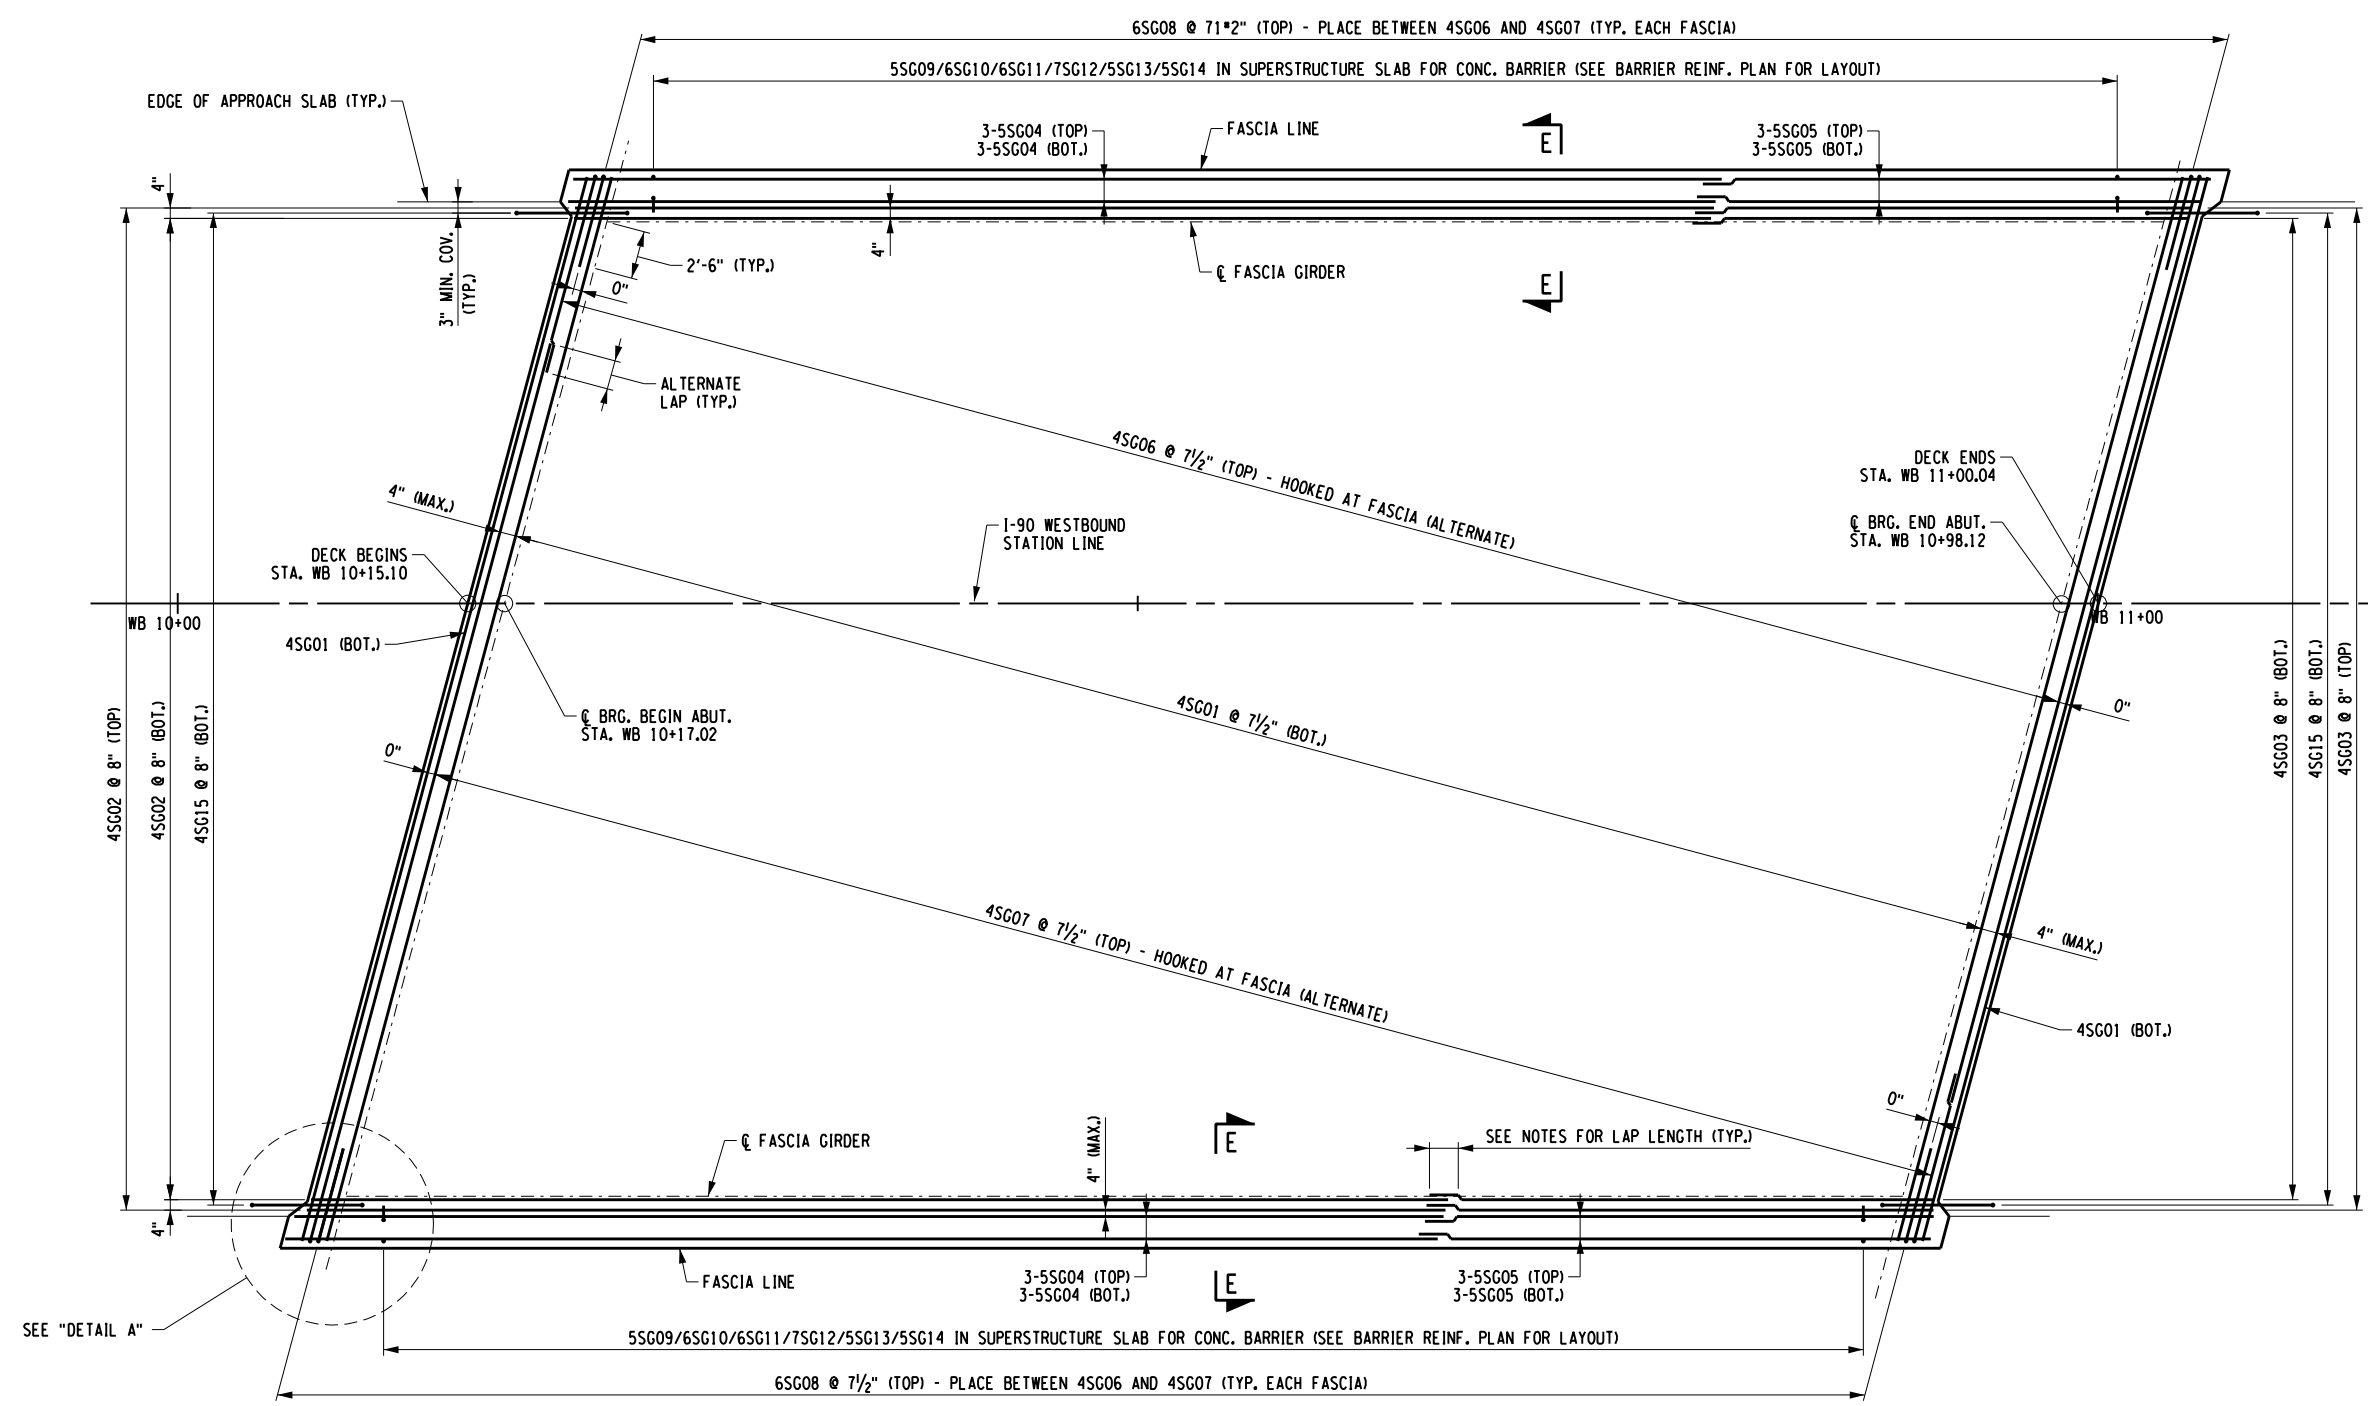- NOTES:**
1. SEE DWG. NO. ST-23 FOR SECTION E-E.
 2. SEE DWG. NO. ST-24 FOR DETAIL A.
 3. (G) DENOTES GALVANIZED COATED BARS
 4. LAP LENGTH OF A #4 BAR = 1'-11"
 5. LAP LENGTH OF A #5 BAR = 2'-4"
 6. LAP LENGTH OF A #7 BAR = 3'-3"

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DATE/TIME = 12/4/2023 3:20:38 PM
USER = LINDO

DESIGNED BY: C. SICHAK
CHECKED BY: N. BARNHARD
DRAFTED BY: T. LINDO
CHECKED BY: N. BARNHARD

ALTERED ON:	AFFIXED ON: 12/04/2023
SIGNATURE: STAMP:	SIGNATURE: STAMP:


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REVISIONS			
DATE	DESCRIPTION	BY	SYM.

 	TITLE OF PROJECT STERLING CREEK BRIDGE REHABILITATION	CONTRACT NUMBER: TAS 24-5B
	LOCATION OF PROJECT SYRACUSE DIVISION BIN 5516091 & 5516092 MP 227.40 & MP 227.41	DATE: NOV. 2023
	TITLE OF DRAWING DECK SLAB PLAN (WESTBOUND)	DRAWING NUMBER: ST-22

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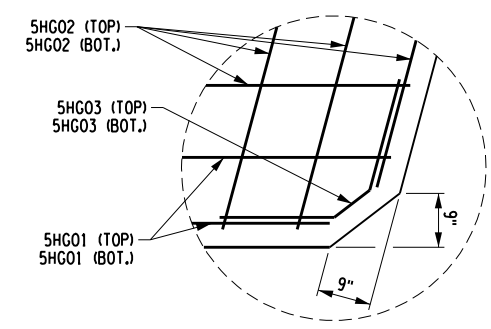
DESIGNED BY: C. SICHAK
 DRAFTED BY: T. LINDO
 CHECKED BY: N. BARNHARD



BEGIN APPROACH SLAB
 (WESTBOUND)
 SCALE: 1" = 10'

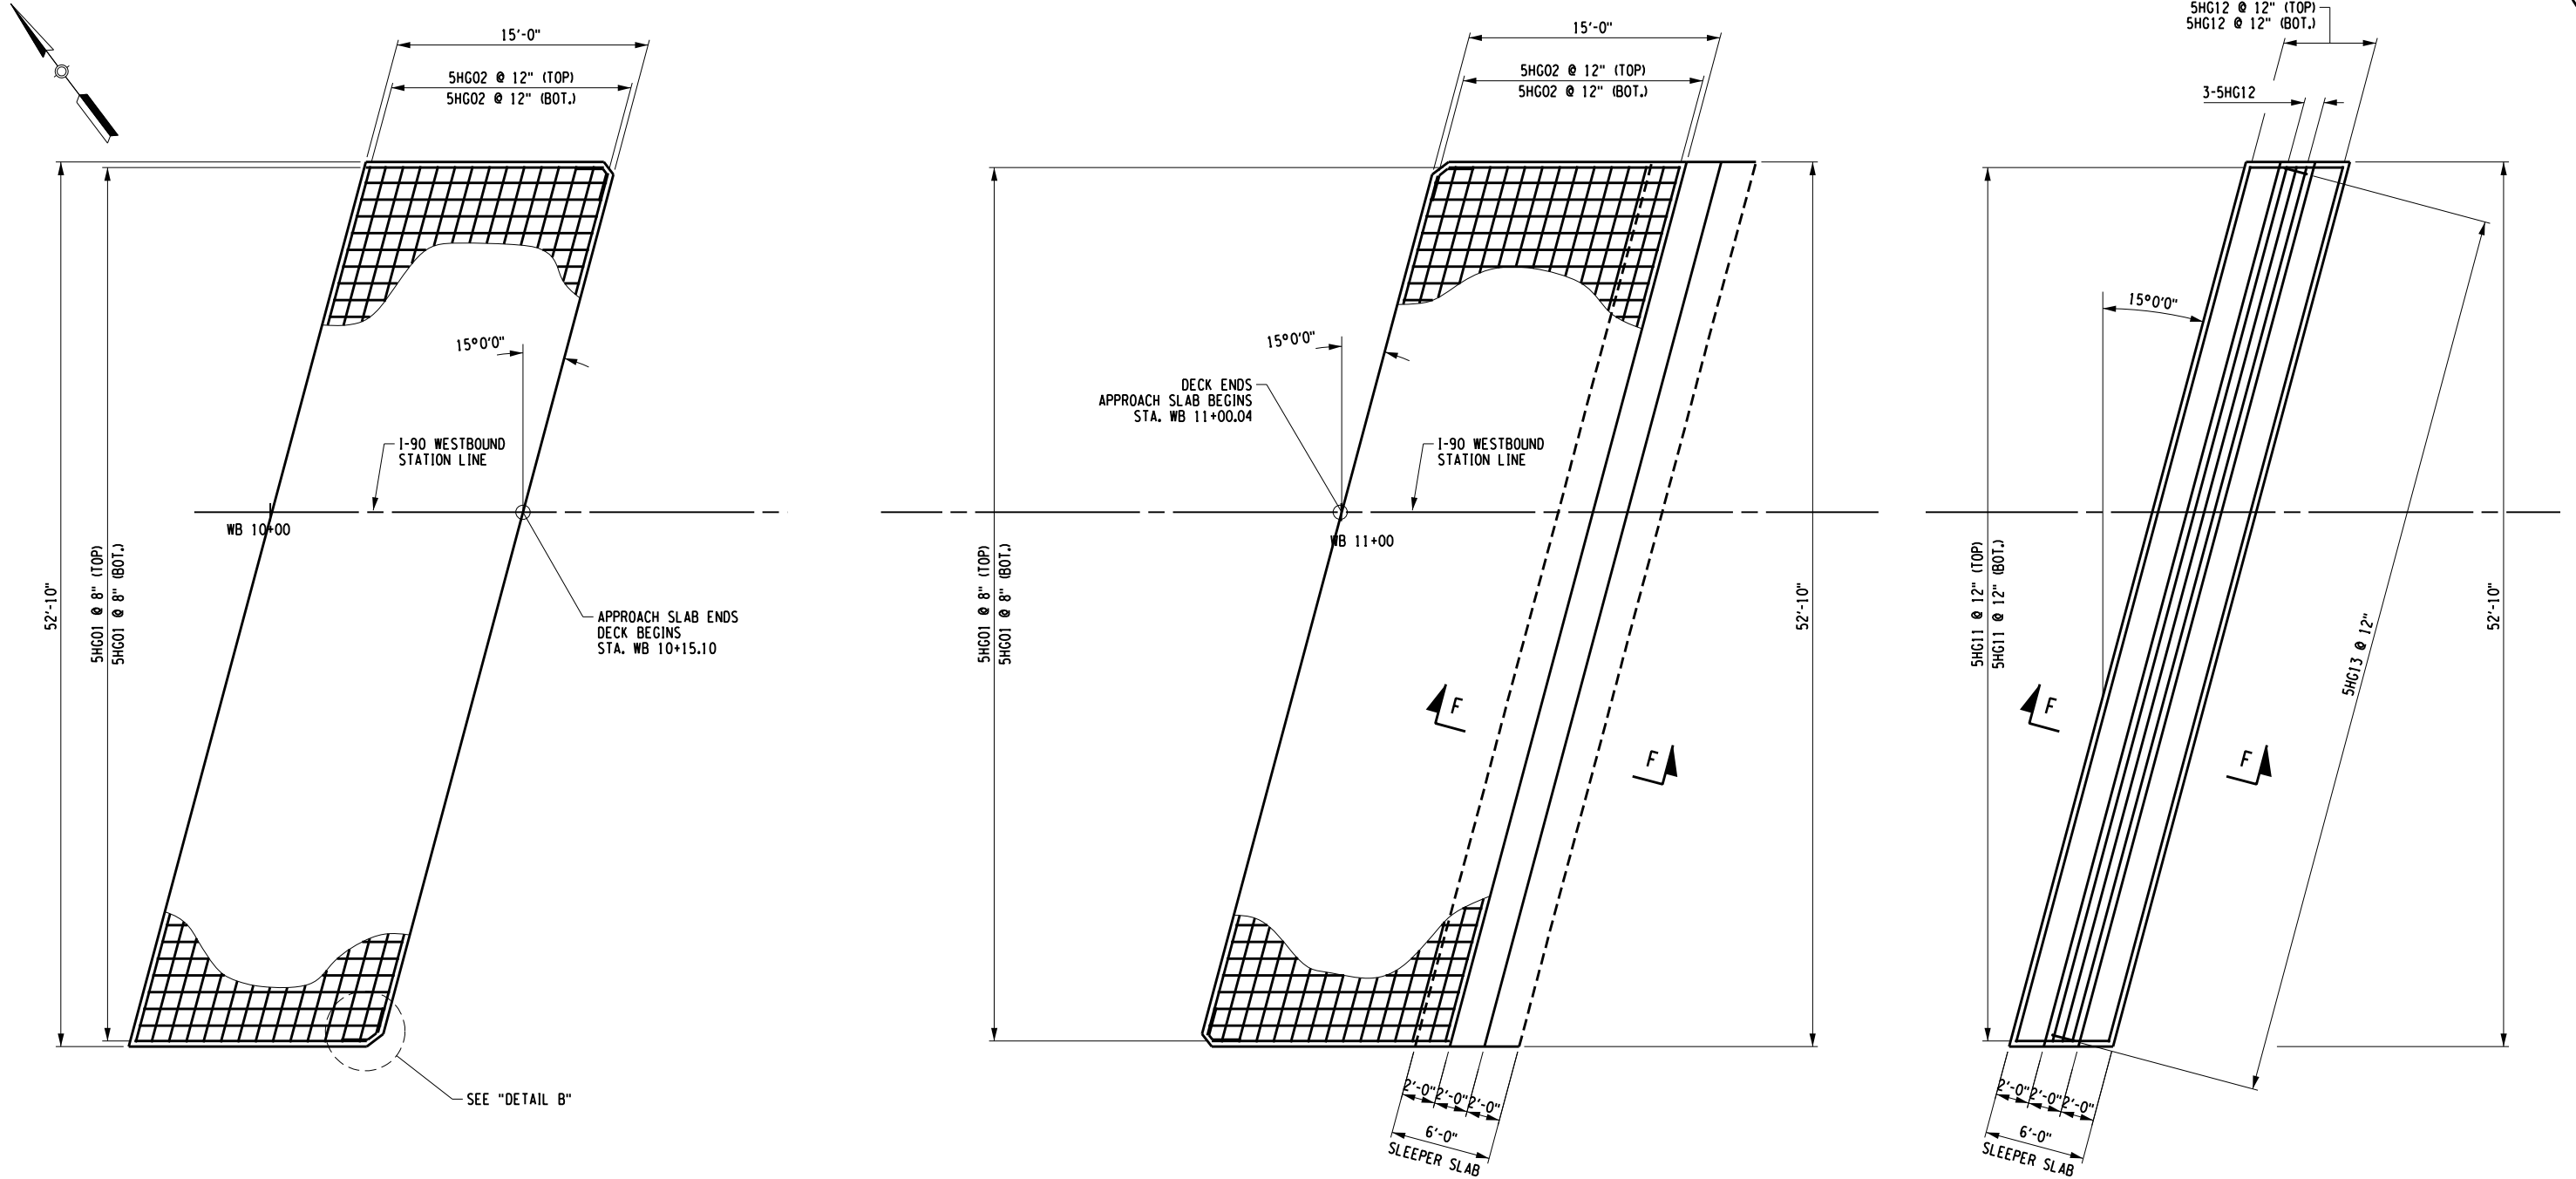END APPROACH SLAB
 (WESTBOUND)
 SCALE: 1" = 10'

END APPROACH SLEEPER SLAB
 (EASTBOUND)
 SCALE: 1" = 10'



DETAIL "B"
 NOT TO SCALE


- NOTES:**
1. ALL REINFORCEMENT SHALL HAVE 3 IN. COVER UNLESS OTHERWISE NOTED.
 2. SLEEPER SLAB REINFORCEMENT NOT SHOWN FOR CLARITY.
 3. SEE DWG. NO. ST-25 FOR SECTION F-F.
 4. (G) DENOTES GALVANIZED COATED BARS

ALTERED ON:	AFFIXED ON: 12/04/2023
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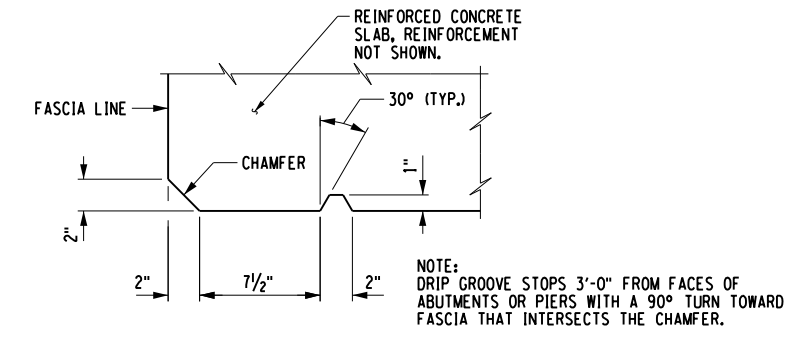
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REVISIONS			
DATE	DESCRIPTION	BY	SYL.


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	LOCATION OF PROJECT SYRACUSE DIVISION BIN 5516091 & 5516092 MP 227.40 & MP 227.41	DATE: NOV. 2023
	TITLE OF DRAWING APPROACH SLAB PLAN (WESTBOUND)	DRAWING NUMBER: ST-23




SECTION E-E
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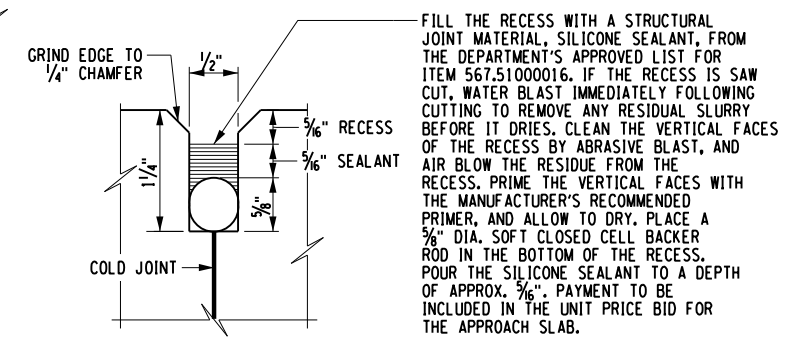
DRIP GROOVE DETAIL
NOT TO SCALE

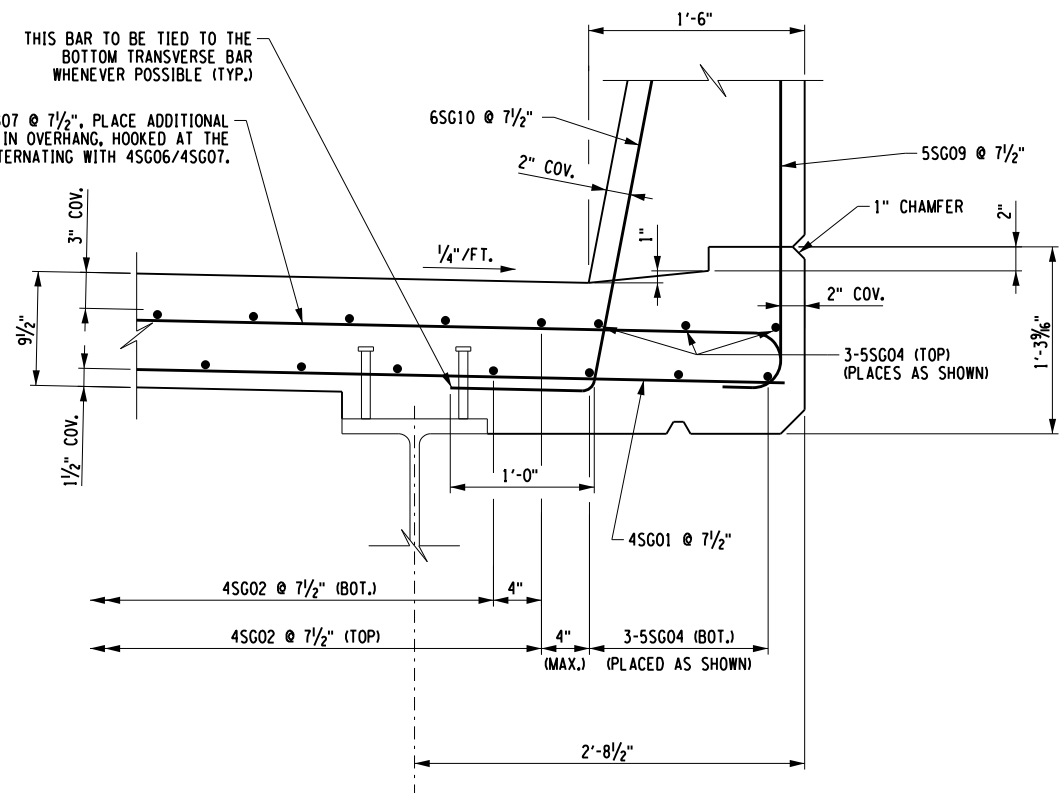

DETAIL A
NOT TO SCALE

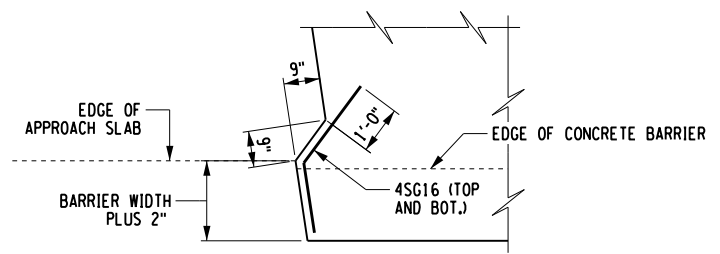

REINFORCEMENT DETAIL FOR JOINTLESS ABUTMENTS

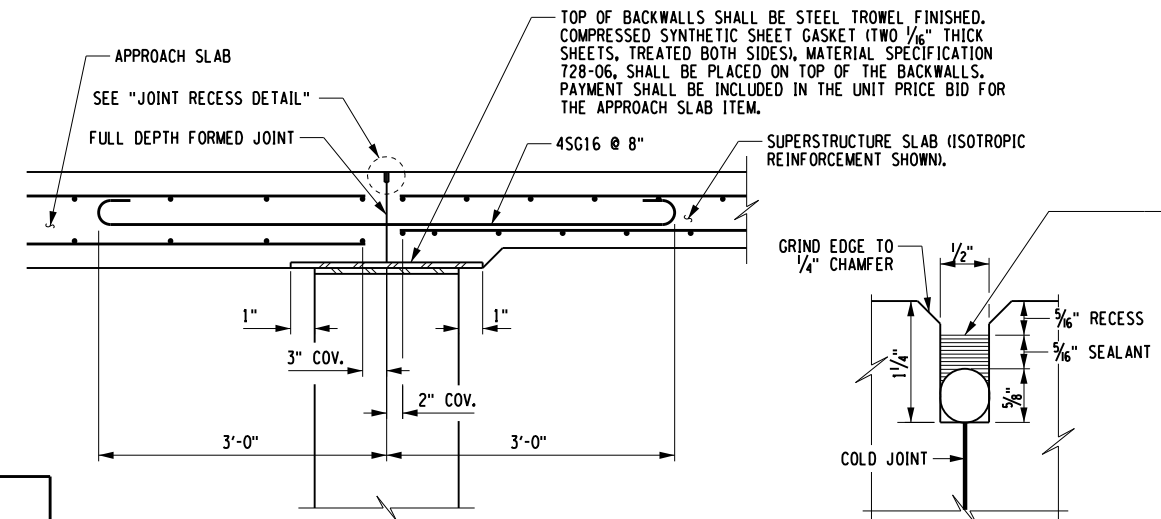

JOINT RECESS DETAIL

NOTES:

1. SEE DWG. NO. ST-20 AND ST-22 FOR LOCATION OF SECTION E-E.
2. SEE DWG. NO. ST-20 AND ST-22 FOR LOCATION OF DETAIL A.
3. (G) DENOTES GALVANIZED COATED BARS

CHECKED BY: N. BARNHARD
 DRAFTED BY: T. LINDO
 CHECKED BY: N. BARNHARD
 DESIGNED BY: C. SICHAK

FILE NAME = N:\19710-05-Sterling\Drawings\Structures\B2221-cpb.s lb.-sup.dtl.dgn
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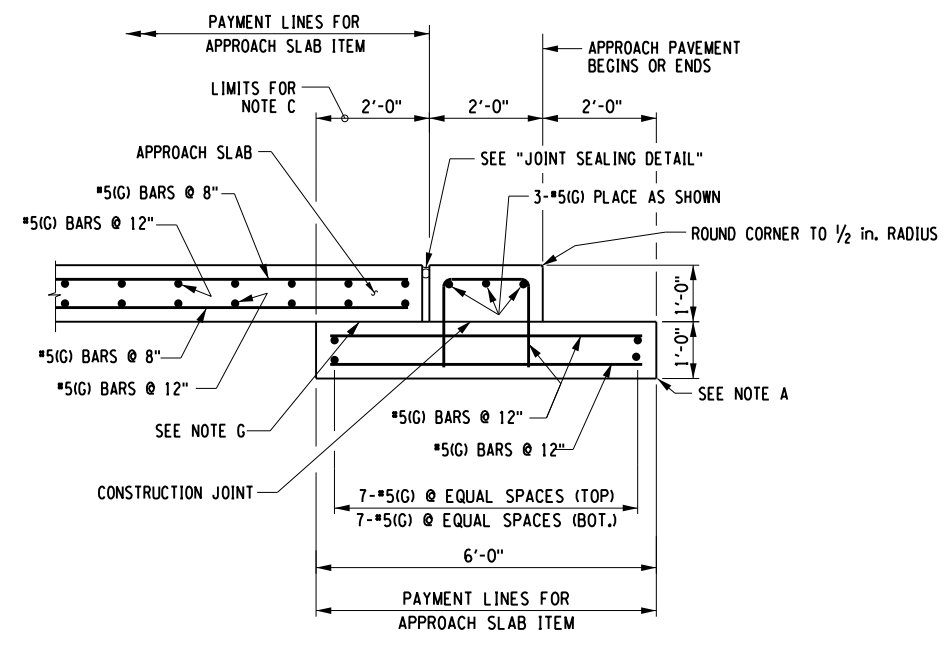
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DATE	DESCRIPTION	BY	SYM.


 Thruway Authority	TITLE OF PROJECT STERLING CREEK BRIDGE REHABILITATION	CONTRACT NUMBER: TAS 24-5B
	LOCATION OF PROJECT SYRACUSE DIVISION BIN 5516091 & 5516092 MP 227.40 & MP 227.41	DATE: NOV. 2023
	TITLE OF DRAWING DECK SLAB DETAILS	DRAWING NUMBER: ST-24

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 DATE/TIME = 12/4/2023 3:20:40 PM
 USER = L.LINDO

DESIGN SUPERVISOR: C. SICHAK
 DRAFTED BY: T. LINDO
 CHECKED BY: N. BARNHARD



SECTION F-F
NOT TO SCALE

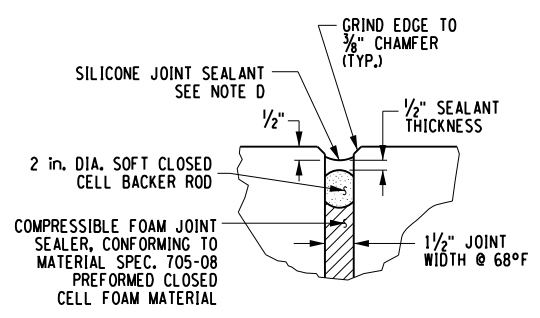

JOINT SEALING DETAIL

NOTES:

- A. EXCAVATION FOR SLEEPER SLABS SHALL BE CAREFULLY MADE AFTER COMPACTED ABUTMENT EMBANKMENT IS IN PLACE. THE SLEEPER SLABS SHALL BE FOUNDED ON UNDISTURBED COMPACT MATERIAL OR RE-COMPACTED MATERIAL. NO LOOSE BACKFILL SHALL BE ALLOWED. THE CONTRACTOR SHALL TAKE ALL NECESSARY PRECAUTIONS TO PROTECT THE SLEEPER SLAB FROM TEMPORARY LOADINGS OR ANY CONDITION WHICH COULD CAUSE MOVEMENTS OR UNEVEN SETTLEMENT OF THE SLEEPER SLAB.
- B. TO PERMIT UNHINDERED LONGITUDINAL MOVEMENT OF SLAB, THE SURFACE OF THE SUBBASE COURSE MUST BE ACCURATELY CONTROLLED TO FOLLOW AND BE PARALLEL TO THE ROADWAY GRADE AND CROSS SLOPE. POLYETHYLENE CURING COVERS (WHITE OPAQUE) IN ACCORDANCE WITH MATERIAL SPECIFICATION SUBSECTION 711-04 SHALL BE PLACED ON THE FINISHED SUBBASE COURSE THE FULL WIDTH OF THE APPROACH SLAB PRIOR TO PLACEMENT OF THE REINFORCEMENT. THE CURING COVERS SHALL BE .004 in. THICK, AND LAPS SHALL BE 2 ft. MINIMUM.
- C. TOP OF SLEEPER SLABS SHALL BE STEEL TROWEL FINISHED AND COATED WITH A 0.04 in. NOMINAL THICKNESS OF PERFORMANCE GRADE ASPHALT AS INDICATED IN THE PROPOSAL, OR MATERIAL SPECIFICATION 702-3101. THE TOP OF SLEEPER SLABS SHALL FOLLOW THE CROSS SLOPE AND GRADE OF ROADWAY. COST TO BE INCLUDED IN THE UNIT PRICE BID FOR THE APPROACH SLAB ITEM.
- D. FILL THE RECESS WITH A STRUCTURAL JOINT MATERIAL, LIQUID SEALANT, FROM THE DEPARTMENT'S APPROVED LIST. THE MANUFACTURER'S RECOMMENDATIONS SHALL BE FOLLOWED FOR THOSE SEALANTS THAT REQUIRES A PRIMER. THE CONCRETE SHALL CURE FOR MINIMUM OF 7 DAYS BEFORE JOINT IS SEALED. SEALING SHALL ONLY BE PERFORMED WHEN THE CONCRETE TEMPERATURE IS 40°F OR ABOVE. BOTH JOINT FACES SHALL BE SAND BLASTED TO ROUGHEN THE SURFACE AND TO REMOVE ALL SURFACE MOISTURE AND ANY OTHER MATERIAL THAT MAY INTERFERE WITH BOND.
- E. TOP SURFACES OF STRUCTURAL SLABS, APPROACH SLABS AND EXPOSED TOP SURFACES OF SLEEPER SLABS SHALL BE GROOVED UNDER THE SAWCUT GROOVING OF STRUCTURAL SLAB SURFACE ITEM.
- F. IF A MODULAR JOINT SYSTEM IS USED, CONCRETE FURNISHED AND PLACED IN THE RECESSES FOR INSTALLING THE JOINT SYSTEM SHALL COMPLY WITH THE SPECIFICATIONS FOR THE APPROACH SLAB ITEM, EXCEPT THAT MACHINE FINISHING WILL NOT BE REQUIRED. NO ADDITIONAL PAYMENT WILL BE MADE FOR FURNISHING AND PLACING THIS CONCRETE AS THIS QUANTITY LIES WITHIN THE LIMITS OF THE AREA TO BE PAID FOR UNDER THE APPROACH SLAB ITEM. IF AN ARMORLESS JOINT IS USED, PAYMENT FOR THE ELASTOMERIC CONCRETE HEADERS SHALL BE INCLUDED IN THE ITEM FOR THE JOINT SYSTEM. THE JOINT SYSTEM SHALL BE PAID FOR UNDER ITS APPROPRIATE ITEM.
- G. COMPRESSED SYNTHETIC SHEET GASKET (TREATED BOTH SIDES), MATERIAL SPECIFICATION 728-06, TWO 0.06 in. THICK SHEETS. PRICE WILL BE INCLUDED IN THE UNIT PRICE BID FOR THE APPROACH SLAB ITEM.

NOTES:


- 1. ALL REINFORCEMENT SHALL HAVE 3 IN. COVER UNLESS OTHERWISE NOTED.
- 2. (G) DENOTES GALVANIZED COATED BARS.
- 3. DETAILS ON THE DRAWINGS LABELED AS "NOT TO SCALE" ARE INTENTIONALLY DRAWN NOT TO SCALE FOR VISUAL CLARITY. ALL OTHER DETAILS, FOR WHICH NO SCALE IS SHOWN, ARE DRAWN PROPORTIONAL AND ARE FULLY DIMENSIONED.

ALTERED ON:	AFFIXED ON: 12/04/2023
SIGNATURE: STAMP:	SIGNATURE: STAMP:


IT IS A VIOLATION OF LAW FOR ANY PERSON, UNLESS THEY ARE ACTING UNDER THE DIRECTION OF A LICENSED PROFESSIONAL ENGINEER, ARCHITECT, LANDSCAPE ARCHITECT, OR LAND SURVEYOR, TO ALTER AN ITEM IN ANY WAY. IF AN ITEM BEARING THE STAMP OF A LICENSED PROFESSIONAL IS ALTERED, THE ALTERING ENGINEER, ARCHITECT, LANDSCAPE ARCHITECT, OR LAND SURVEYOR SHALL STAMP THE DOCUMENT AND INCLUDE THE NOTATION "ALTERED BY" FOLLOWED BY THEIR SIGNATURE. THE DATE OF SUCH ALTERATION, AND A SPECIFIC DESCRIPTION OF THE ALTERATION.

REVISIONS			
DATE	DESCRIPTION	BY	SYM.


 Thruway Authority	TITLE OF PROJECT STERLING CREEK BRIDGE REHABILITATION	CONTRACT NUMBER: TAS 24-5B
	LOCATION OF PROJECT SYRACUSE DIVISION BIN 5516091 & 5516092, MP 227.40 & MP 227.41	DATE: NOV. 2023
	TITLE OF DRAWING SLEEPER SLAB DETAILS	DRAWING NUMBER: ST-25

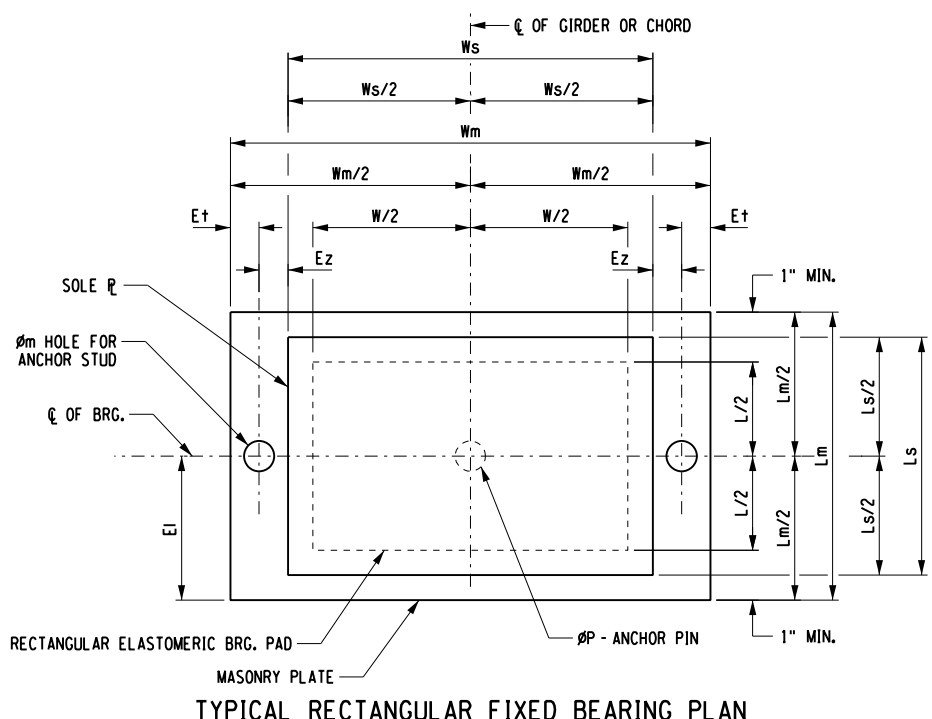


TYPICAL RECTANGULAR FIXED BEARING PLAN

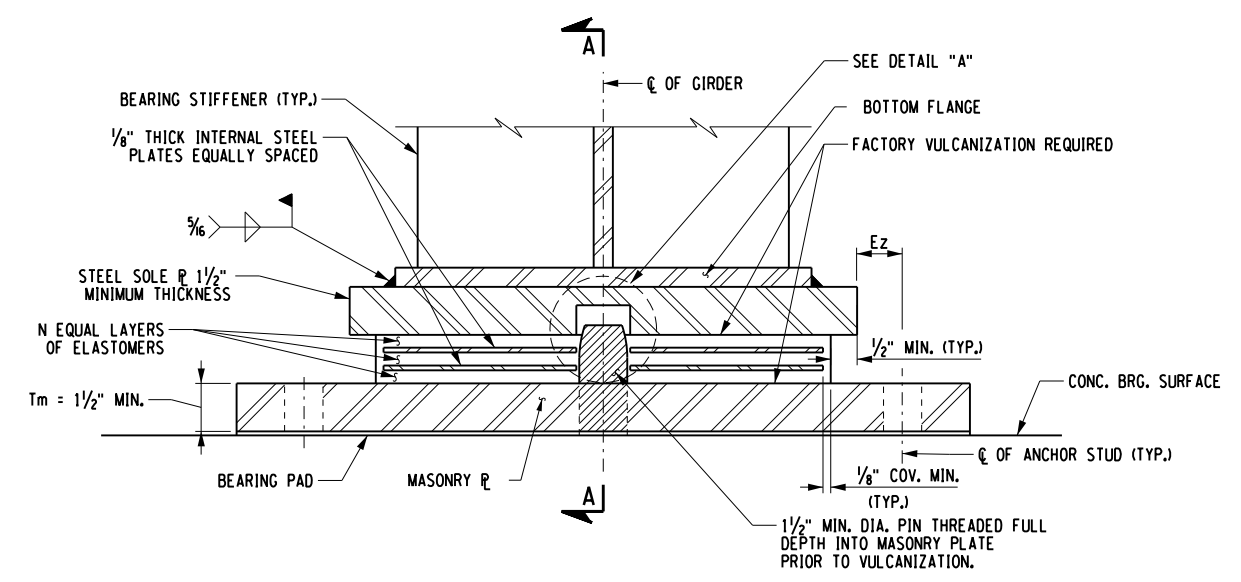

TYPICAL FIXED BEARING ELEVATION

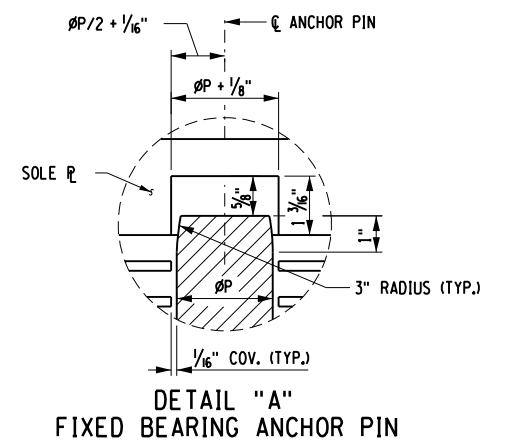

DETAIL "A"
FIXED BEARING ANCHOR PIN

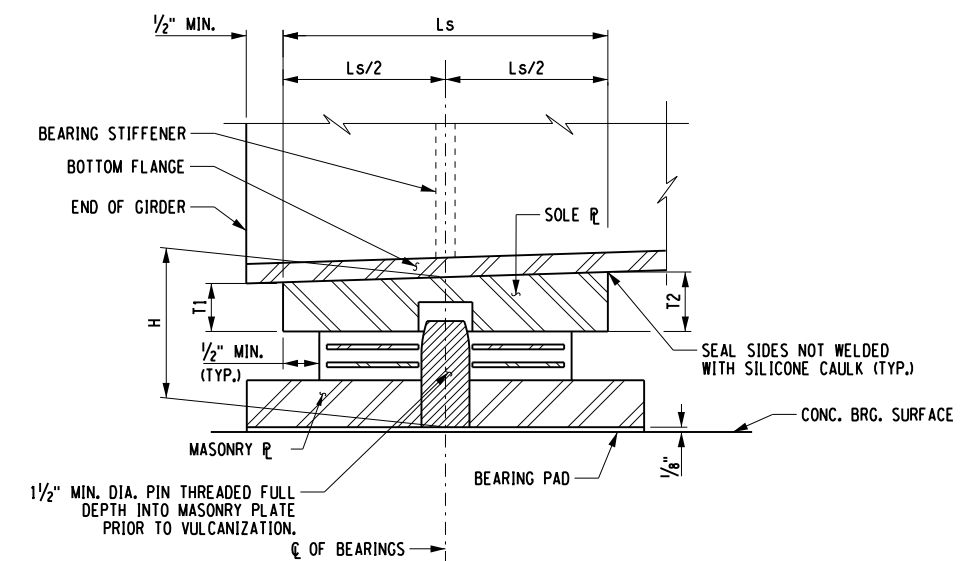

SECTION A-A

LOCATION	ITEM NO.	QUANTITY REQUIRED	D.L. + S.D.L. (kips)	L.L. WITHOUT IMPACT (kips)	TOTAL DESIGN REACTION (kips)	SHAPE FACTOR	ELASTOMER LAYER				hrt	COMP. AREA (SQ. in.)	SHEAR AREA (SQ. in.)	MASONRY PLATE					ANCHOR STUDS		WELD SIZE	SOLE PLATE				BRG. H	ØP (PIN DIA.)		
							THK/LAYER	NO. LAYERS	L	W				Wm	Lm	Tm	Et	Ez	Øm	DIA.		STUDS/BRG.	Ws	Ls	T1			T2	
WEST ABUT.	565.2023	8	63	67	130	6.35	0.5	2	11	15	1	157	163	24 1/2	13	1.5	2	6 1/2	1 1/2	1 3/8	1	2	5/16	17 1/2	12	1 1/2	1 1/2	4 1/4	1 1/2

TABLE DIMENSIONS ARE IN INCHES UNLESS OTHERWISE NOTED

T2 IS UPSTATION OF T1.

NOTES:

- THE BEARINGS SHALL MEET THE REQUIREMENTS OF STANDARD SPECIFICATION SECTION 565 UNLESS OTHERWISE NOTED.
- ALL ELASTOMER SHALL BE 50 DUROMETER HARDNESS ON THE SHORE A SCALE.
- ALL STEEL EXCEPT THE INTERNAL STEEL PLATES SHALL CONFORM TO ASTM A709, GR. 50, UNLESS OTHERWISE NOTED.
- BEARING PADS SHALL CONFORM TO ONE OF THE FOLLOWING MATERIAL SPECIFICATIONS: 728-01, 728-02 OR 728-03.
- INSTALLATION ALIGNMENT: THE MAXIMUM VARIATION FROM PERFECT ALIGNMENT UNDER FULL DEAD LOAD SHALL NOT EXCEED 3/16". THIS VARIATION SHALL BE MEASURED AS THE HORIZONTAL DISTANCE BETWEEN THE CENTERLINE OF THE HIGHEST ELASTOMER SURFACE AND THE CENTERLINE OF THE LOWEST ELASTOMER SURFACE.
- CONCRETE SURFACES UNDER THE BEARINGS SHALL CONFORM TO SUBSECTION 565.3.02 "CONCRETE BEARING SURFACE PREPARATION" OF THE NEW YORK STATE STANDARD SPECIFICATIONS, CONSTRUCTION AND MATERIALS.
- THE BEARING PAD, ANCHOR STUDS, WASHER PLATES AND NUTS SHALL BE INCLUDED IN THE UNIT PRICE BID FOR THE BEARING ITEM.
- IF THE ANCHOR STUDS ARE SET UNDER THE SOLE PLATE, A MINIMUM CLEARANCE EQUAL TO TWO TIMES THE THICKNESS OF ANCHOR NUT PLUS 1" SHALL BE MAINTAINED BETWEEN THE TOP OF MASONRY PLATE AND BOTTOM OF THE SOLE PLATE.

IT IS A VIOLATION OF LAW FOR ANY PERSON, UNLESS THEY ARE ACTING UNDER THE DIRECTION OF A LICENSED PROFESSIONAL ENGINEER, ARCHITECT, LANDSCAPE ARCHITECT, OR LAND SURVEYOR, TO ALTER AN ITEM IN ANY WAY. IF AN ITEM BEARING THE STAMP OF A LICENSED PROFESSIONAL IS ALTERED, THE ALTERING ENGINEER, ARCHITECT, LANDSCAPE ARCHITECT, OR LAND SURVEYOR SHALL STAMP THE DOCUMENT AND INCLUDE THE NOTATION "ALTERED BY" FOLLOWED BY THEIR SIGNATURE. THE DATE OF SUCH ALTERATION, AND A SPECIFIC DESCRIPTION OF THE ALTERATION.

REVISIONS			
DATE	DESCRIPTION	BY	SYM.




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LOCATION OF PROJECT SYRACUSE DIVISION BIN 5516091 & 5516092 MP 227.40 & MP 227.41	DATE: NOV. 2023
TITLE OF DRAWING BEARING DETAILS - FIXED	DRAWING NUMBER: ST-26

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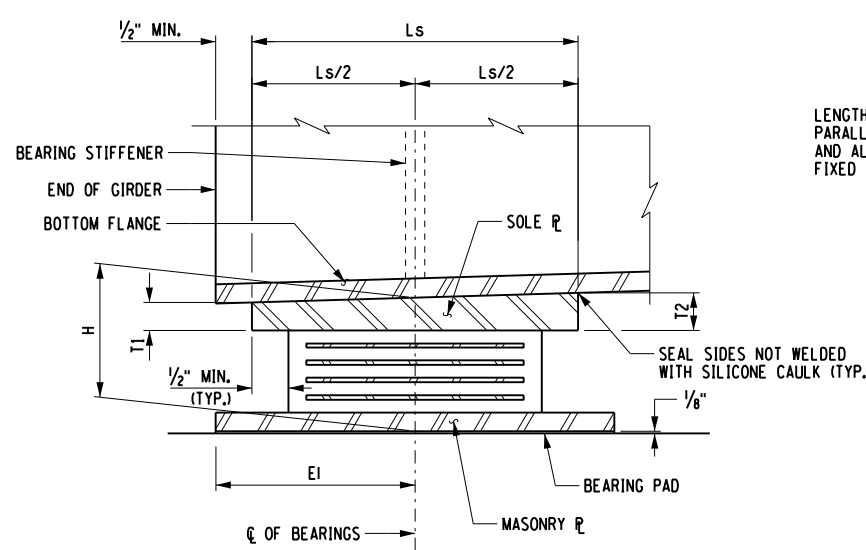
DESIGNED BY: C. SICHAK
CHECKED BY: N. BARNHARD
DRAFTED BY: T. LINDO
CHECKED BY: N. BARNHARD

ALTERED ON: _____
AFFIXED ON: 12/04/2023

SIGNATURE: _____
STAMP: _____

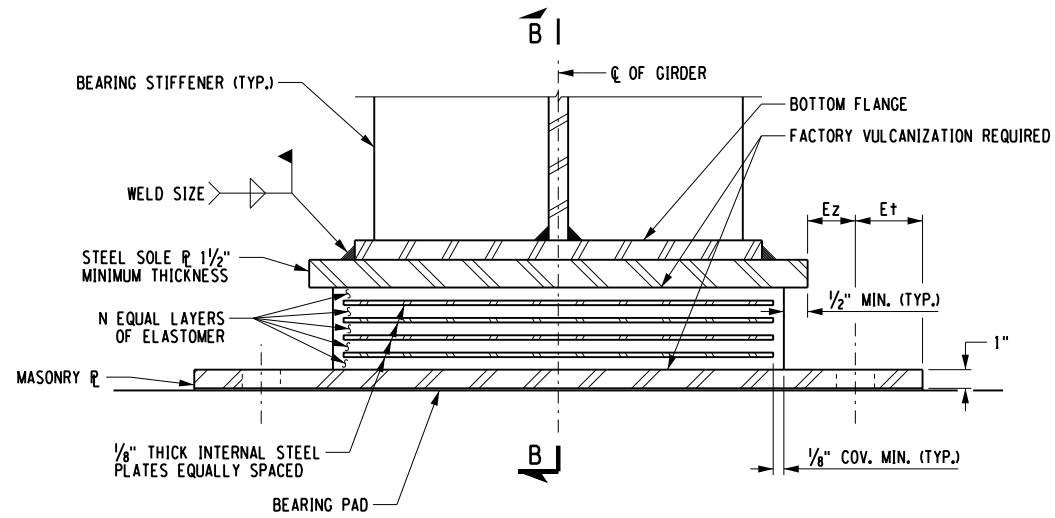


TYPICAL EXPANSION BEARING ELEVATION




SECTION B-B

LENGTH OF SLOT SHALL BE PARALLEL TO STRAIGHT BEAMS AND ALONG THE CHORD TO THE FIXED BEARING ON CURVED BEAMS

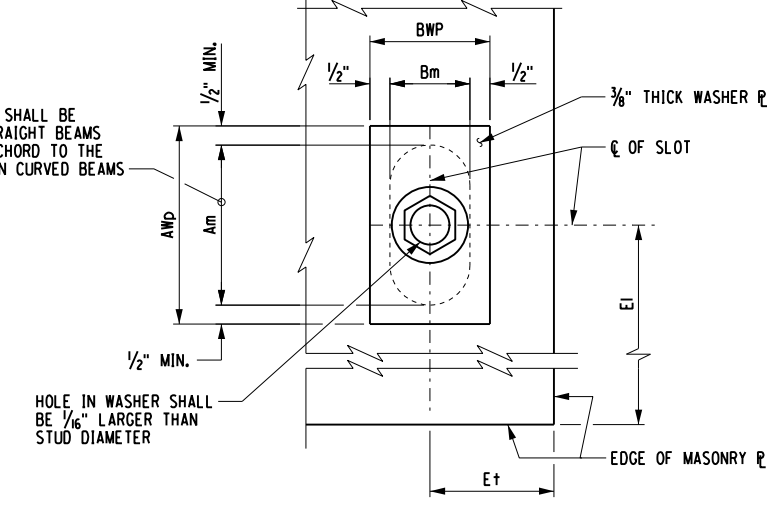

TYPICAL SLOTTED HOLE DETAIL MASONRY PLATE

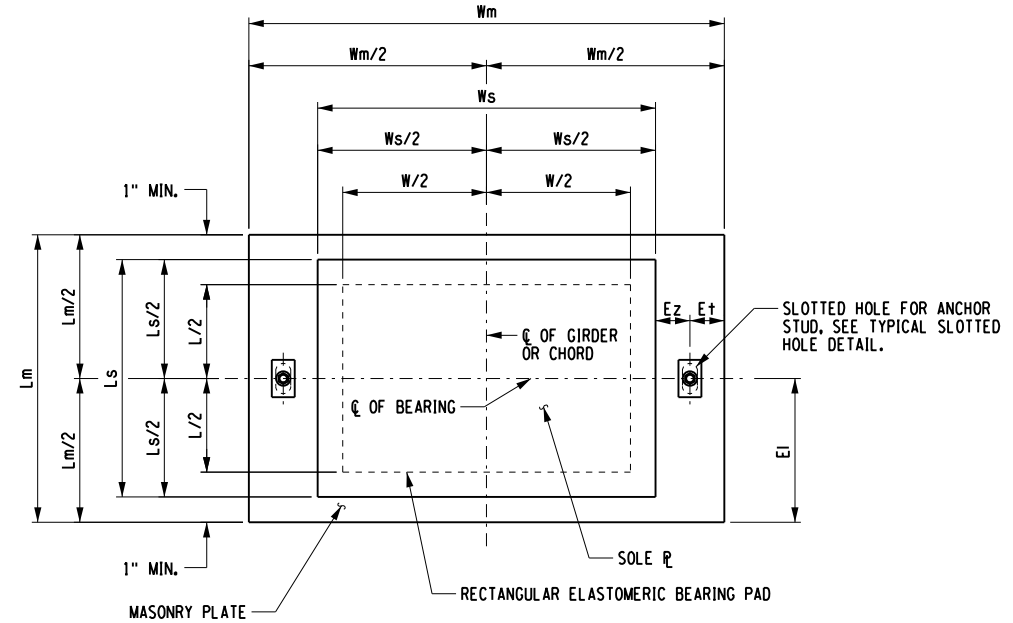

TYPICAL RECTANGULAR EXPANSION BEARING PLAN

LOCATION	ITEM NO.	QUANTITY REQUIRED	D.L. + S.D.L. (kips)	L.L. WITHOUT IMPACT (kips)	TOTAL DESIGN REACTION (kips)	SHAPE FACTOR	ELASTOMER LAYER				hrt	COMP. AREA (SQ. In.)	SHEAR AREA (SQ. In.)	MASONRY PLATE						ANCHOR STUDS		WELD SIZE	WASHER PLATE		SOLE PLATE				BRG. H		
							THK/LAYER	NO. LAYERS	L	W				Wm	Lm	Tm	Et	E	Ez	Am	Bm		DIA.	STUDS/BRG.	AWp	BWp	Ws	Ls		T1	T2
EAST ABUT.	565.2033	8	63	67	130	6.52	0.5	3	11	16	1 1/2	169	176	24 1/2	13	1	2	6 1/2	1 1/2	2 1/2	1 3/8	1	2	5/16	3 1/2	2 3/8	17 1/2	12	1 1/2	1 1/2	4 3/8

TABLE DIMENSIONS ARE IN INCHES UNLESS OTHERWISE NOTED

T2 IS UPSTATION OF T1.

NOTES:

- THE BEARINGS SHALL MEET THE REQUIREMENTS OF STANDARD SPECIFICATION SECTION 565 UNLESS OTHERWISE NOTED.
- ALL ELASTOMER SHALL BE 50 DUROMETER HARDNESS ON THE SHORE A SCALE.
- ALL STEEL EXCEPT THE INTERNAL STEEL PLATES SHALL CONFORM TO ASTM A709, GR. 50, UNLESS OTHERWISE NOTED.
- BEARING PADS SHALL CONFORM TO ONE OF THE FOLLOWING MATERIAL SPECIFICATIONS: 728-01, 728-02 OR 728-03.
- INSTALLATION ALIGNMENT: THE MAXIMUM VARIATION FROM PERFECT ALIGNMENT UNDER FULL DEAD LOAD SHALL NOT EXCEED 3/16". THIS VARIATION SHALL BE MEASURED AS THE HORIZONTAL DISTANCE BETWEEN THE CENTERLINE OF THE HIGHEST ELASTOMER SURFACE AND THE CENTERLINE OF THE LOWEST ELASTOMER SURFACE.
- CONCRETE SURFACES UNDER THE BEARINGS SHALL CONFORM TO SUBSECTION 565.3.02 "CONCRETE BEARING SURFACE PREPARATION" OF THE NEW YORK STATE STANDARD SPECIFICATIONS, CONSTRUCTION AND MATERIALS.
- THE BEARING PAD, ANCHOR STUDS, WASHER PLATES AND NUTS SHALL BE INCLUDED IN THE UNIT PRICE BID FOR THE BEARING ITEM.
- IF THE ANCHOR STUDS ARE SET UNDER THE SOLE PLATE, A MINIMUM CLEARANCE EQUAL TO TWO TIMES THE THICKNESS OF ANCHOR NUT PLUS 1" SHALL BE MAINTAINED BETWEEN THE TOP OF MASONRY PLATE AND BOTTOM OF THE SOLE PLATE.

IT IS A VIOLATION OF LAW FOR ANY PERSON, UNLESS THEY ARE ACTING UNDER THE DIRECTION OF A LICENSED PROFESSIONAL ENGINEER, ARCHITECT, LANDSCAPE ARCHITECT, OR LAND SURVEYOR, TO ALTER AN ITEM IN ANY WAY. IF AN ITEM BEARING THE STAMP OF A LICENSED PROFESSIONAL IS ALTERED, THE ALTERING ENGINEER, ARCHITECT, LANDSCAPE ARCHITECT, OR LAND SURVEYOR SHALL STAMP THE DOCUMENT AND INCLUDE THE NOTATION "ALTERED BY" FOLLOWED BY THEIR SIGNATURE. THE DATE OF SUCH ALTERATION, AND A SPECIFIC DESCRIPTION OF THE ALTERATION.

REVISIONS			
DATE	DESCRIPTION	BY	SYM.



TITLE OF PROJECT STERLING CREEK BRIDGE REHABILITATION	CONTRACT NUMBER: TAS 24-5B
LOCATION OF PROJECT SYRACUSE DIVISION BIN 5516091 & 5516092 MP 227.40 & MP 227.41	DATE: NOV. 2023
TITLE OF DRAWING BEARING DETAILS - EXPANSION	DRAWING NUMBER: ST-27

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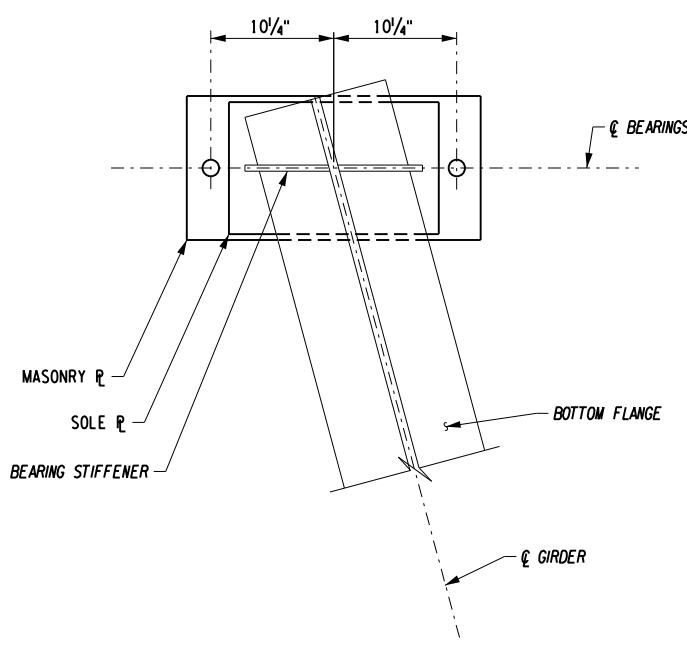
DESIGNED BY: N. BARNHARD
CHECKED BY: T. LINDO
DRAFTED BY: T. LINDO
CHECKED BY: N. BARNHARD

ALTERED ON: _____ AFFIXED ON: 12/04/2023


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DESIGNED BY: N. BARNHARD
 CHECKED BY: N. BARNHARD
 DRAFTED BY: T. LINDO
 CHECKED BY: N. BARNHARD




PLAN - CONNECTION DETAIL
 SCALE: 3/4" = 1'-0"



ANCHOR STUD

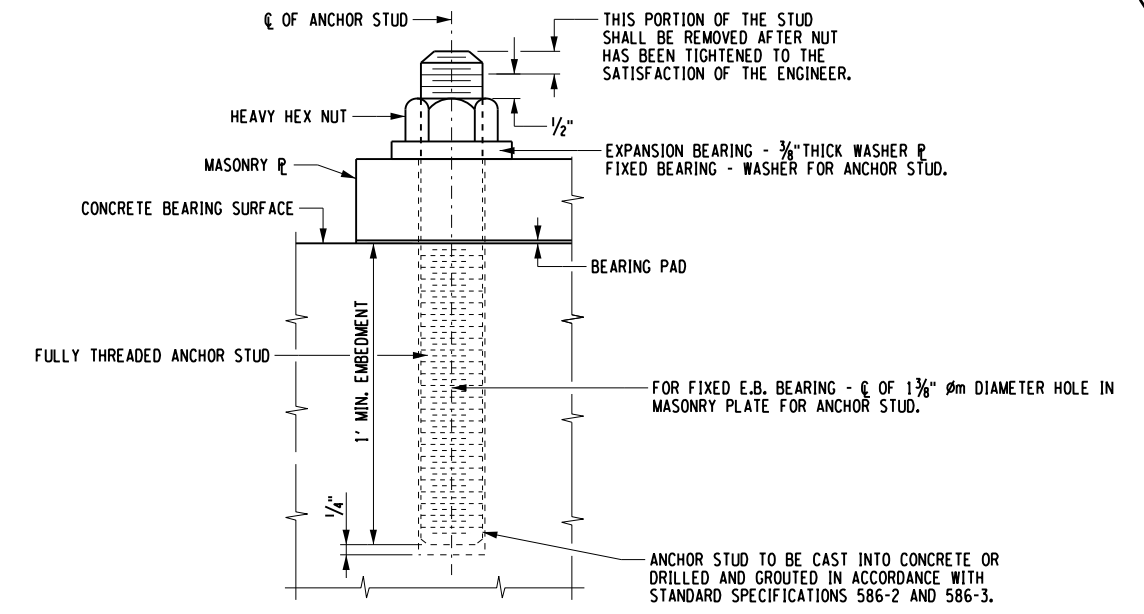ANCHOR STUDS, WASHERS, WASHER PLATES, ANCHOR PLATES, AND NUTS SHALL MEET THE REQUIREMENTS OF SUBSECTION 723-60. THEY SHALL BE GALVANIZED IN ACCORDANCE WITH THE REQUIREMENTS OF MATERIAL SUBSECTION 719-01, "GALVANIZED COATINGS AND REPAIR METHODS." THE COST, INCLUDING GALVANIZING, SHALL BE INCLUDED IN THE UNIT PRICE BID FOR THE BEARING ITEM.

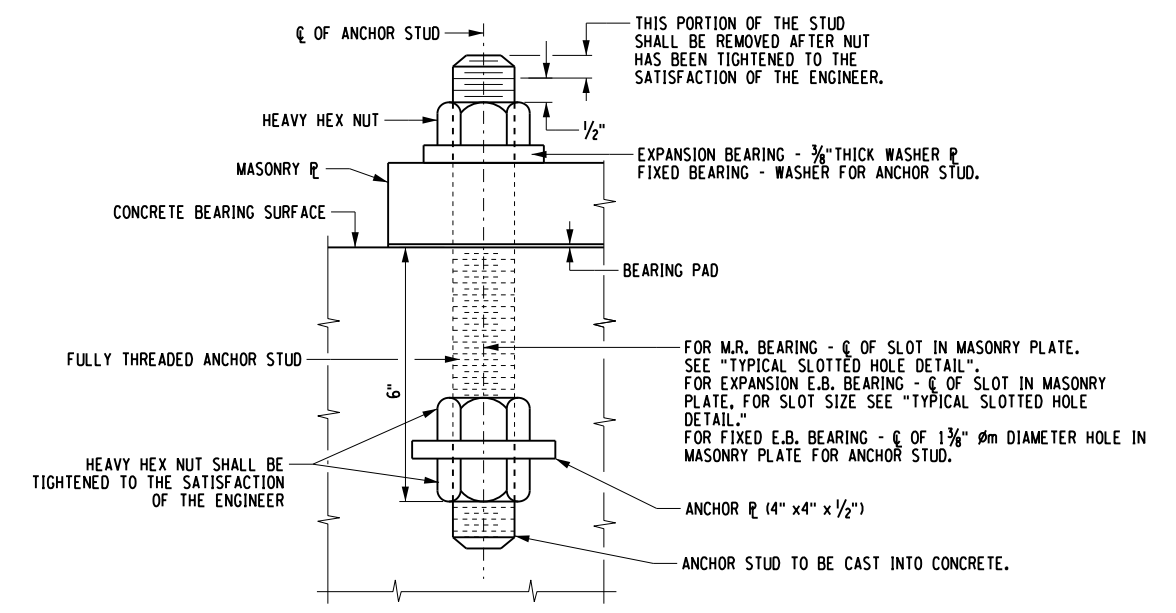

ANCHOR STUD WITH ANCHOR PLATE


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SIGNATURE: STAMP:	SIGNATURE: STAMP:

IT IS A VIOLATION OF LAW FOR ANY PERSON, UNLESS THEY ARE ACTING UNDER THE DIRECTION OF A LICENSED PROFESSIONAL ENGINEER, ARCHITECT, LANDSCAPE ARCHITECT, OR LAND SURVEYOR, TO ALTER AN ITEM IN ANY WAY. IF AN ITEM BEARING THE STAMP OF A LICENSED PROFESSIONAL IS ALTERED, THE ALTERING ENGINEER, ARCHITECT, LANDSCAPE ARCHITECT, OR LAND SURVEYOR SHALL STAMP THE DOCUMENT AND INCLUDE THE NOTATION "ALTERED BY" FOLLOWED BY THEIR SIGNATURE. THE DATE OF SUCH ALTERATION, AND A SPECIFIC DESCRIPTION OF THE ALTERATION.

REVISIONS			
DATE	DESCRIPTION	BY	SYM.

 Thruway Authority	TITLE OF PROJECT STERLING CREEK BRIDGE REHABILITATION	CONTRACT NUMBER: TAS 24-5B
	LOCATION OF PROJECT SYRACUSE DIVISION BIN 5516091 & 5516092 MP 227.40 & MP 227.41	DATE: NOV. 2023
	TITLE OF DRAWING BEARING DETAILS MISCELLANEOUS	DRAWING NUMBER: ST-28

LIMITS OF PROTECTIVE SEALING OF STRUCTURAL CONCRETE ON NEW BRIDGE DECKS - ITEM 559.01

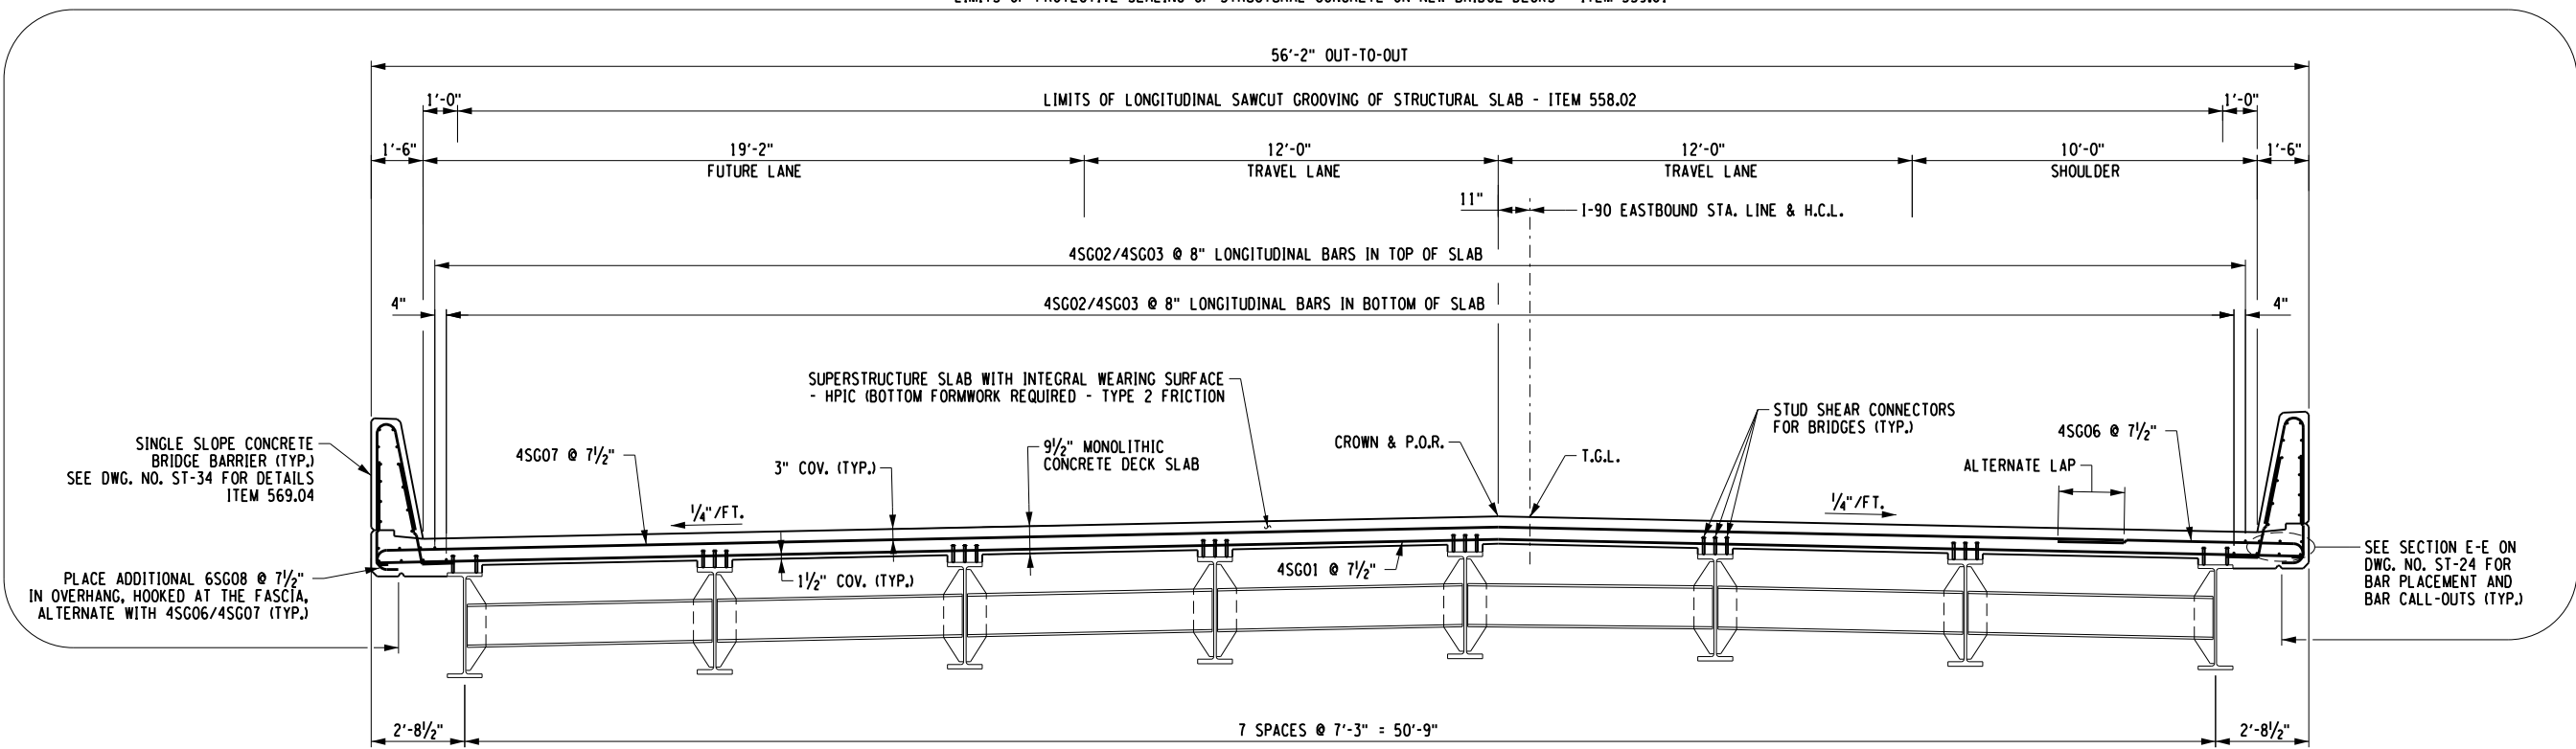

PROPOSED TRANSVERSE SECTION
(I-90 EASTBOUND SHOWN, WESTBOUND SIMILAR)
SCALE: 3/16" = 1'-0"

(G) DENOTES GALVANIZED COATED BARS

CHECKED BY: N. BARNHARD

DRAFTED BY: T. LINDO

CHECKED BY:

DESIGNED BY: N. BARNHARD

DESIGN SUPERVISOR: C. SICHAK

ALTERED ON:	AFFIXED ON: 12/04/2023
SIGNATURE: STAMP:	SIGNATURE: STAMP:

IT IS A VIOLATION OF LAW FOR ANY PERSON, UNLESS THEY ARE ACTING UNDER THE DIRECTION OF A LICENSED PROFESSIONAL ENGINEER, ARCHITECT, LANDSCAPE ARCHITECT, OR LAND SURVEYOR, TO ALTER AN ITEM IN ANY WAY. IF AN ITEM BEARING THE STAMP OF A LICENSED PROFESSIONAL IS ALTERED, THE ALTERING ENGINEER, ARCHITECT, LANDSCAPE ARCHITECT, OR LAND SURVEYOR SHALL STAMP THE DOCUMENT AND INCLUDE THE NOTATION "ALTERED BY" FOLLOWED BY THEIR SIGNATURE. THE DATE OF SUCH ALTERATION, AND A SPECIFIC DESCRIPTION OF THE ALTERATION.


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DATE	DESCRIPTION	BY	SYMBOL




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LOCATION OF PROJECT SYRACUSE DIVISION BIN 5516091 & 5516092 MP 227.40 & MP 227.41	DATE: NOV. 2023
TITLE OF DRAWING PROPOSED TRANSVERSE SECTION	DRAWING NUMBER: ST-29

CHECKED BY: N. BARNHARD
 DRAFTED BY: T. LINDO
 CHECKED BY: N. BARNHARD
 DESIGNED BY: C. SICHAK
 DESIGN SUPERVISOR: C. SICHAK

FILE NAME = N:\19710-05-Sterling\Drawings\Structures\B2221.cpb_fm.dgn
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 USER = L.lindo

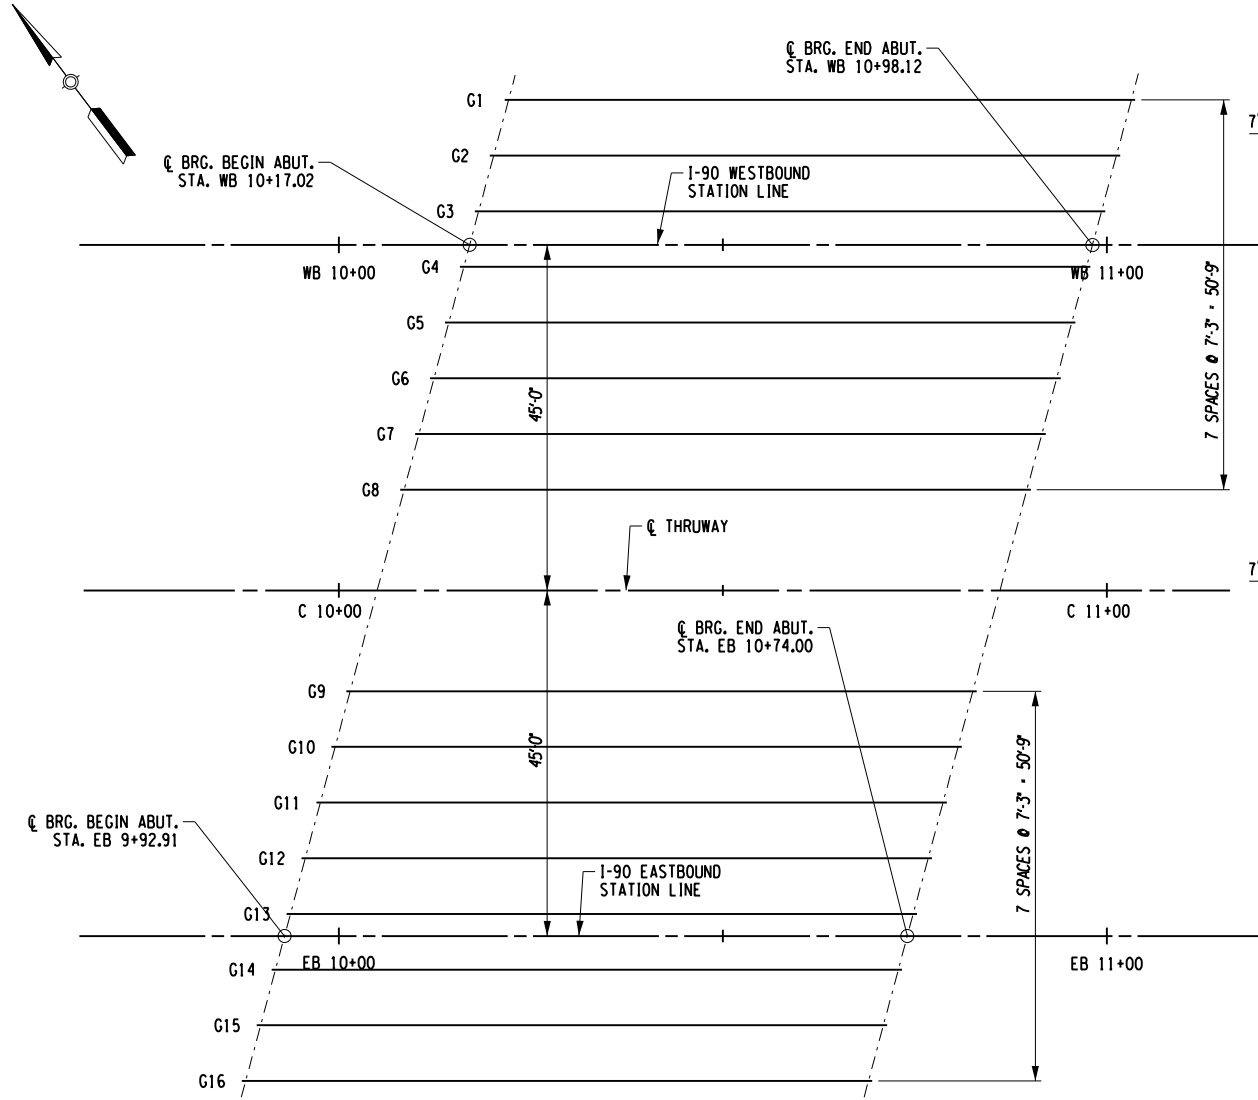

FRAMING PLAN
SCALE: 1" = 25'

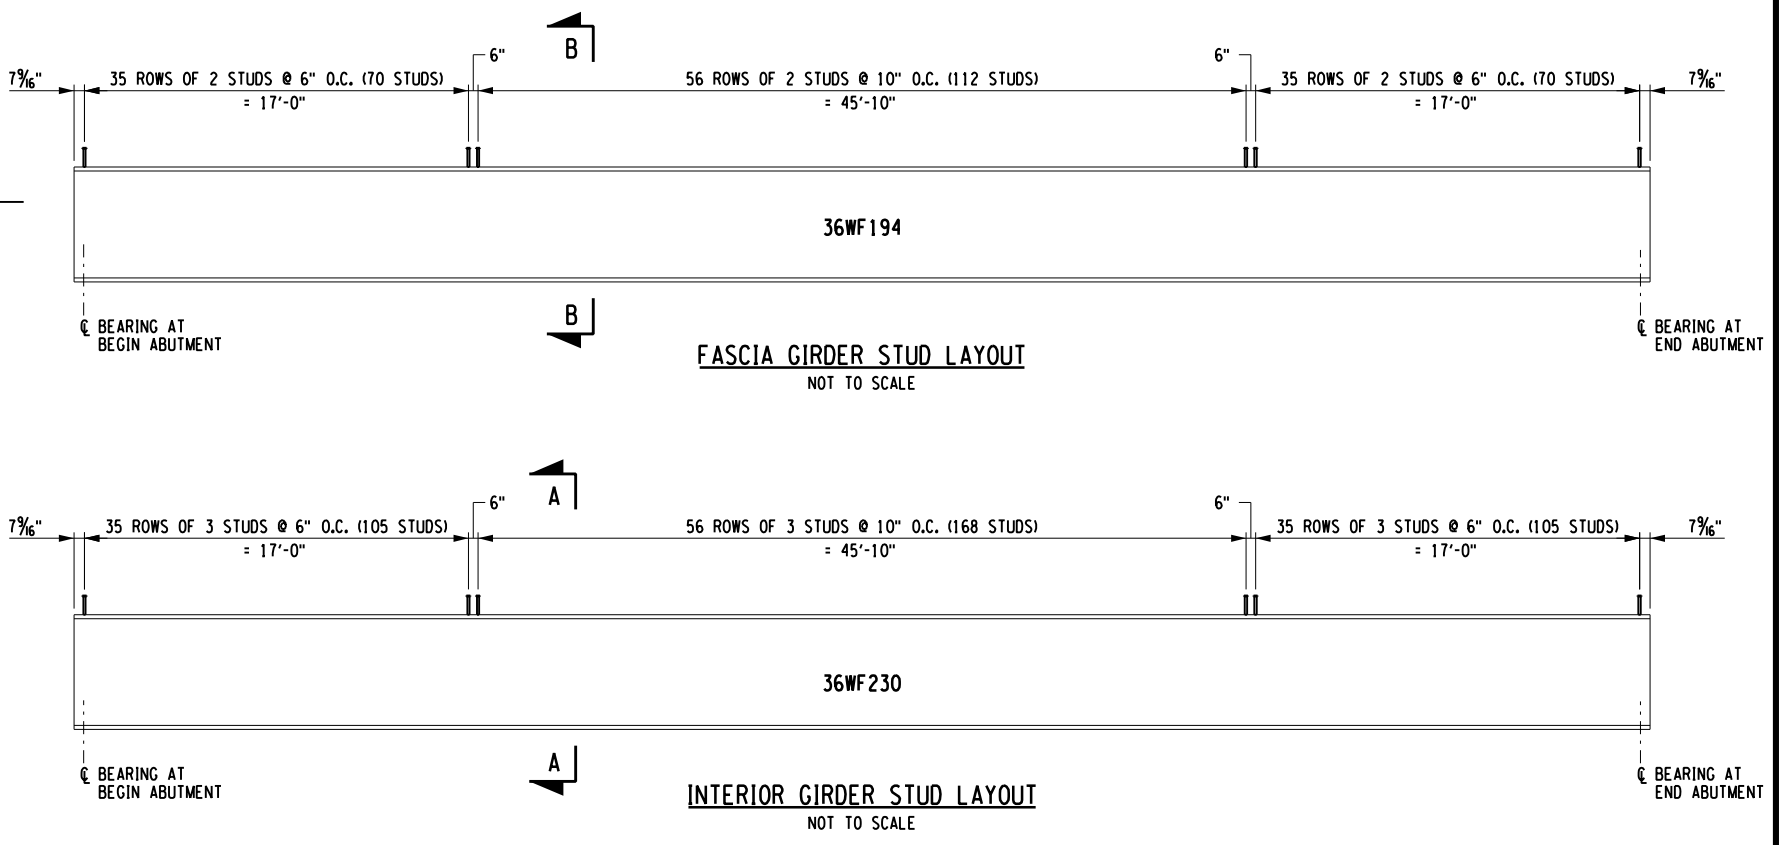


FASCIA GIRDER STUD LAYOUT
NOT TO SCALE


INTERIOR GIRDER STUD LAYOUT
NOT TO SCALE

NOTES:


1. ALL EXISTING SPIRAL RODS SHALL BE REMOVED.
2. UPON REMOVAL OF DECK, ELEVATION SHOTS SHALL BE TAKEN AT TENTH POINTS ALONG THE CENTERLINE OF EACH GIRDER TO VERIFY STEEL DEAD LOAD DEFLECTION. ANY VARIATIONS FROM THE EXPECTED SHOWN ON THE CONTRACT PLANS SHALL BE REPORTED TO THE DIRECTOR OF STRUCTURES DESIGN FOR POSSIBLE FIELD CORRECTIONS. IN THIS SITUATION, NO WORK SHALL PROGRESS UNTIL THE PROBLEM IS RESOLVED TO THEIR SATISFACTION.
3. UPON COMPLETION OF FORMWORK, DECK REINFORCING, AND SCREED MACHINE, ELEVATION SHOTS SHALL BE TAKEN AT TENTH POINTS ALONG THE CENTERLINE OF EACH GIRDER DURING THE DRY RUN TO VERIFY APPROPRIATE DECK THICKNESS, COVER, AND THE APPEARANCE OF ANY DIFFERENTIAL DEFLECTIONS BETWEEN THE ADJACENT GIRDERS. ANY VARIATIONS FROM THE DEFLECTIONS SHOWN ON THE CONTRACT PLANS, OR INDICATIONS OF POSSIBLE SUBSTANDARD DECK THICKNESS OR COVER SHALL BE REPORTED TO THE DIRECTOR OF STRUCTURES DESIGN FOR POSSIBLE FIELD CORRECTIONS. IN THIS SITUATION, NO WORK SHALL PROGRESS UNTIL THE PROBLEM IS RESOLVED TO THEIR SATISFACTION.
4. DURING THE DECK POURING OPERATION, THE CONTRACTOR SHALL MONITOR THE ACTUAL DECK THICKNESS AT TENTH POINTS ALONG THE CENTERLINE OF EACH GIRDER TO INSURE THE MINIMUM THICKNESS AND REINFORCING COVER AS SHOWN ON THESE PLANS. IF THIS IS NOT THE CASE, THE DIRECTOR OF STRUCTURES DESIGN SHALL BE IMMEDIATELY NOTIFIED OF THE SITUATION AND POSSIBLE RAMIFICATION (I.E. SUBSTANDARD DECK THICKNESS). IN THIS SITUATION, NO WORK SHALL PROGRESS UNTIL THE PROBLEM IS RESOLVED TO THEIR SATISFACTION.
5. THE CONTRACTOR SHALL PROVIDE TEMPORARY BRACING IF REQUIRED OF THE FASCIA GIRDER TO PREVENT TORSIONAL AND VERTICAL DIFFERENTIAL DEFLECTIONS DURING PLACEMENT OF THE DECK OVERHANG. COST INCLUDED UNDER ITEM 557.4102.

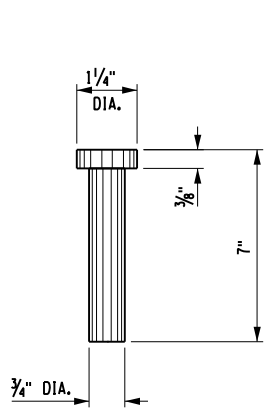

STUD DETAIL
NOT TO SCALE

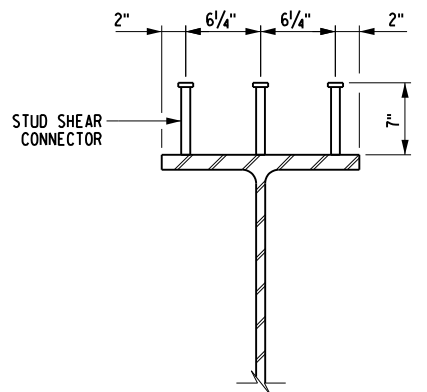

INTERIOR GIRDER SECTION A-A
NOT TO SCALE

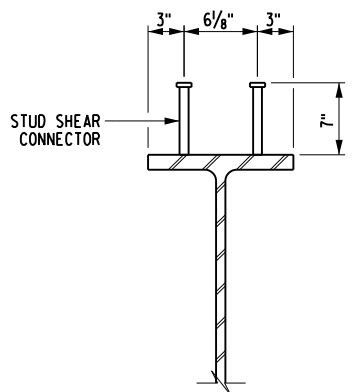


FASCIA GIRDER SECTION B-B
NOT TO SCALE

ALTERED ON:	AFFIXED ON: 12/04/2023
SIGNATURE: STAMP:	SIGNATURE: STAMP:

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REVISIONS			
DATE	DESCRIPTION	BY	SYM.

 Thruway Authority 	TITLE OF PROJECT STERLING CREEK BRIDGE REHABILITATION	CONTRACT NUMBER: TAS 24-5B
	LOCATION OF PROJECT SYRACUSE DIVISION BIN 5516091 & 5516092, MP 227.40 & MP 227.41	DATE: NOV. 2023
	TITLE OF DRAWING STEEL DETAILS	DRAWING NUMBER: ST-30

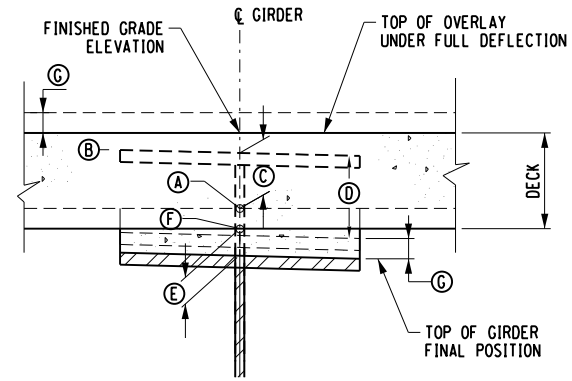


GIRDER HAUNCH DETAIL
NOT TO SCALE

- NOTES:**
1. (A) & (F) TAKEN AT ϕ OF GIRDER.
 2. (E) - GIRDER HAUNCH, IS TAKEN AT ϕ OF GIRDER.

LEGEND

—— INITIAL POSITION (BEAM D.L. ONLY)
 - - - INTERMEDIATE POSITION (BEAM + DECK D.L.)
 —— FINAL POSITION (TOTAL D.L. + S.D.L.)

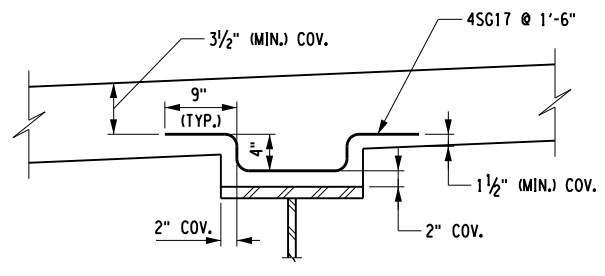

REINFORCED GIRDER HAUNCH DETAIL
NOT TO SCALE

NOTE:
IF THE DEPTH OF THE GIRDER HAUNCH IS GREATER OR EQUAL TO 4" AT ANY POINT ALONG THE GIRDER, THE HAUNCH SHALL BE REINFORCED ACCORDING TO THIS DETAIL.

HAUNCH TABLE - EB

		E. OF BRGS. BEGIN ABUT.										E. OF BRGS. END ABUT.	
			1/10 L1	2/10 L1	3/10 L1	4/10 L1	5/10 L1	6/10 L1	7/10 L1	8/10 L1	9/10 L1		
GIRDER 1	A	REQ'D BOTTOM OF SLAB ELEVATION AFTER DECK POUR	433.757	433.814	433.869	433.923	433.975	434.025	434.072	434.117	434.161	434.203	434.244
	B	TOP OF STEEL ELEVATION (FIELD MEASURE)											
	C	= A - B (FT)											
	D	CONCRETE NON-COMPOSITE D.L. DEFLECTION (FT)	0.000	0.049	0.092	0.125	0.146	0.153	0.146	0.125	0.092	0.049	0.000
	E	DEPTH OF HAUNCH REQ'D = C + D (FT)											
	F	REQ'D BOTTOM OF SLAB ELEVATION AFTER S.D.L. APPLICATION	433.757	433.806	433.854	433.903	433.952	434.000	434.049	434.098	434.146	434.195	434.244
	G	DECK SURFACE CAMBER A - F (FT) ABOVE PROPOSED GRADE (S.D.L. DEFL.)	0.000	0.008	0.014	0.020	0.023	0.024	0.023	0.020	0.014	0.008	0.000
GIRDER 2	A	REQ'D BOTTOM OF SLAB ELEVATION AFTER DECK POUR	433.890	433.946	434.000	434.053	434.105	434.154	434.202	434.248	434.292	434.335	434.377
	B	TOP OF STEEL ELEVATION (FIELD MEASURE)											
	C	= A - B (FT)											
	D	CONCRETE NON-COMPOSITE D.L. DEFLECTION (FT)	0.000	0.042	0.079	0.108	0.126	0.133	0.126	0.108	0.079	0.043	0.000
	E	DEPTH OF HAUNCH REQ'D = C + D (FT)											
	F	REQ'D BOTTOM OF SLAB ELEVATION AFTER S.D.L. APPLICATION	433.890	433.939	433.988	434.036	434.085	434.134	434.182	434.231	434.280	434.328	434.377
	G	DECK SURFACE CAMBER A - F (FT) ABOVE PROPOSED GRADE (S.D.L. DEFL.)	0.000	0.007	0.012	0.017	0.020	0.021	0.020	0.017	0.012	0.007	0.000
GIRDER 3	A	REQ'D BOTTOM OF SLAB ELEVATION AFTER DECK POUR	434.024	434.079	434.134	434.187	434.238	434.288	434.335	434.381	434.425	434.468	434.510
	B	TOP OF STEEL ELEVATION (FIELD MEASURE)											
	C	= A - B (FT)											
	D	CONCRETE NON-COMPOSITE D.L. DEFLECTION (FT)	0.000	0.042	0.079	0.108	0.126	0.133	0.126	0.108	0.079	0.043	0.000
	E	DEPTH OF HAUNCH REQ'D = C + D (FT)											
	F	REQ'D BOTTOM OF SLAB ELEVATION AFTER S.D.L. APPLICATION	434.024	434.072	434.121	434.170	434.218	434.267	434.316	434.364	434.413	434.462	434.510
	G	DECK SURFACE CAMBER A - F (FT) ABOVE PROPOSED GRADE (S.D.L. DEFL.)	0.000	0.007	0.012	0.017	0.020	0.021	0.020	0.017	0.012	0.007	0.000
GIRDER 4	A	REQ'D BOTTOM OF SLAB ELEVATION AFTER DECK POUR	434.157	434.212	434.267	434.320	434.371	434.421	434.469	434.515	434.559	434.602	434.644
	B	TOP OF STEEL ELEVATION (FIELD MEASURE)											
	C	= A - B (FT)											
	D	CONCRETE NON-COMPOSITE D.L. DEFLECTION (FT)	0.000	0.042	0.079	0.108	0.126	0.133	0.126	0.108	0.079	0.043	0.000
	E	DEPTH OF HAUNCH REQ'D = C + D (FT)											
	F	REQ'D BOTTOM OF SLAB ELEVATION AFTER S.D.L. APPLICATION	434.157	434.206	434.254	434.303	434.352	434.400	434.449	434.498	434.546	434.595	434.644
	G	DECK SURFACE CAMBER A - F (FT) ABOVE PROPOSED GRADE (S.D.L. DEFL.)	0.000	0.007	0.012	0.017	0.020	0.021	0.020	0.017	0.012	0.007	0.000
GIRDER 5	A	REQ'D BOTTOM OF SLAB ELEVATION AFTER DECK POUR	434.291	434.346	434.400	434.453	434.505	434.554	434.602	434.648	434.692	434.735	434.777
	B	TOP OF STEEL ELEVATION (FIELD MEASURE)											
	C	= A - B (FT)											
	D	CONCRETE NON-COMPOSITE D.L. DEFLECTION (FT)	0.000	0.042	0.079	0.108	0.126	0.133	0.126	0.108	0.079	0.043	0.000
	E	DEPTH OF HAUNCH REQ'D = C + D (FT)											
	F	REQ'D BOTTOM OF SLAB ELEVATION AFTER S.D.L. APPLICATION	434.291	434.339	434.388	434.436	434.485	434.534	434.582	434.631	434.680	434.728	434.777
	G	DECK SURFACE CAMBER A - F (FT) ABOVE PROPOSED GRADE (S.D.L. DEFL.)	0.000	0.007	0.012	0.017	0.020	0.021	0.020	0.017	0.012	0.007	0.000
GIRDER 6	A	REQ'D BOTTOM OF SLAB ELEVATION AFTER DECK POUR	434.172	434.227	434.282	434.335	434.386	434.436	434.484	434.530	434.574	434.617	434.659
	B	TOP OF STEEL ELEVATION (FIELD MEASURE)											
	C	= A - B (FT)											
	D	CONCRETE NON-COMPOSITE D.L. DEFLECTION (FT)	0.000	0.042	0.079	0.108	0.126	0.133	0.126	0.108	0.079	0.043	0.000
	E	DEPTH OF HAUNCH REQ'D = C + D (FT)											
	F	REQ'D BOTTOM OF SLAB ELEVATION AFTER S.D.L. APPLICATION	434.172	434.221	434.270	434.318	434.367	434.415	434.464	434.513	434.561	434.610	434.659
	G	DECK SURFACE CAMBER A - F (FT) ABOVE PROPOSED GRADE (S.D.L. DEFL.)	0.000	0.007	0.012	0.017	0.020	0.021	0.020	0.017	0.012	0.007	0.000
GIRDER 7	A	REQ'D BOTTOM OF SLAB ELEVATION AFTER DECK POUR	434.016	434.071	434.125	434.178	434.230	434.279	434.327	434.373	434.417	434.460	434.502
	B	TOP OF STEEL ELEVATION (FIELD MEASURE)											
	C	= A - B (FT)											
	D	CONCRETE NON-COMPOSITE D.L. DEFLECTION (FT)	0.000	0.042	0.079	0.108	0.126	0.133	0.126	0.108	0.079	0.043	0.000
	E	DEPTH OF HAUNCH REQ'D = C + D (FT)											
	F	REQ'D BOTTOM OF SLAB ELEVATION AFTER S.D.L. APPLICATION	434.016	434.064	434.113	434.162	434.210	434.259	434.307	434.356	434.405	434.453	434.502
	G	DECK SURFACE CAMBER A - F (FT) ABOVE PROPOSED GRADE (S.D.L. DEFL.)	0.000	0.007	0.012	0.017	0.020	0.021	0.020	0.017	0.012	0.007	0.000
GIRDER 8	A	REQ'D BOTTOM OF SLAB ELEVATION AFTER DECK POUR	433.859	433.915	433.971	434.025	434.076	434.126	434.174	434.219	434.263	434.305	434.345
	B	TOP OF STEEL ELEVATION (FIELD MEASURE)											
	C	= A - B (FT)											
	D	CONCRETE NON-COMPOSITE D.L. DEFLECTION (FT)	0.000	0.049	0.092	0.125	0.146	0.153	0.146	0.125	0.092	0.049	0.000
	E	DEPTH OF HAUNCH REQ'D = C + D (FT)											
	F	REQ'D BOTTOM OF SLAB ELEVATION AFTER S.D.L. APPLICATION	433.859	433.908	433.956	434.005	434.054	434.102	434.151	434.199	434.248	434.297	434.345
	G	DECK SURFACE CAMBER A - F (FT) ABOVE PROPOSED GRADE (S.D.L. DEFL.)	0.000	0.008	0.014	0.020	0.023	0.024	0.023	0.020	0.014	0.008	0.000

NOTE:
THE CONTRACTOR SHALL PROVIDE THE ENGINEER WITH THE COMPLETED HAUNCH TABLE PRIOR TO SETTING THE BOTTOM FORMWORK OF THE DECK


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 USER = L.lindo
 DESIGN SUPERVISOR: C. SICHAK
 DESIGNED BY: N. BARNHARD
 CHECKED BY: T. LINDO
 DRAFTED BY: N. BARNHARD
 CHECKED BY:

ALTERED ON:	AFFIXED ON: 12/04/2023
SIGNATURE: STAMP:	SIGNATURE: STAMP:

IT IS A VIOLATION OF LAW FOR ANY PERSON, UNLESS THEY ARE ACTING UNDER THE DIRECTION OF A LICENSED PROFESSIONAL ENGINEER, ARCHITECT, LANDSCAPE ARCHITECT, OR LAND SURVEYOR, TO ALTER AN ITEM IN ANY WAY. IF AN ITEM BEARING THE STAMP OF A LICENSED PROFESSIONAL IS ALTERED, THE ALTERING ENGINEER, ARCHITECT, LANDSCAPE ARCHITECT, OR LAND SURVEYOR SHALL STAMP THE DOCUMENT AND INCLUDE THE NOTATION "ALTERED BY" FOLLOWED BY THEIR SIGNATURE. THE DATE OF SUCH ALTERATION, AND A SPECIFIC DESCRIPTION OF THE ALTERATION.

REVISIONS			
DATE	DESCRIPTION	BY	SYM.

		TITLE OF PROJECT STERLING CREEK BRIDGE REHABILITATION	
LOCATION OF PROJECT SYRACUSE DIVISION BIN 5516091 & 5516092 MP 227.40 & MP 227.41		CONTRACT NUMBER: TAS 24-5B	
TITLE OF DRAWING HAUNCH TABLE (EASTBOUND)		DATE: NOV. 2023	
DRAWING NUMBER: ST-31		DRAWING NUMBER: ST-31	

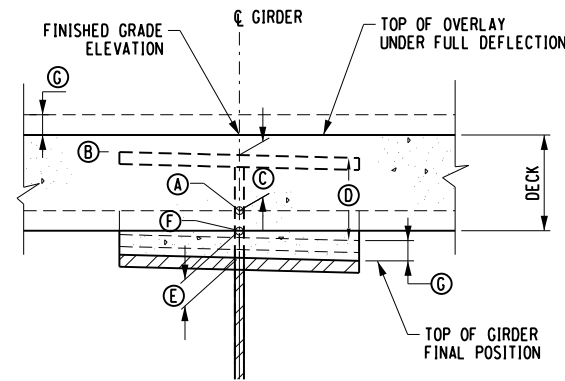


GIRDER HAUNCH DETAIL
NOT TO SCALE

NOTES:

- 1. (A) & (F) TAKEN AT ϕ OF GIRDER.
- 2. (E) - GIRDER HAUNCH, IS TAKEN AT ϕ OF GIRDER.

LEGEND

- INITIAL POSITION (BEAM D.L. ONLY)
- - - - - INTERMEDIATE POSITION (BEAM + DECK D.L.)
- FINAL POSITION (TOTAL D.L. + S.D.L.)

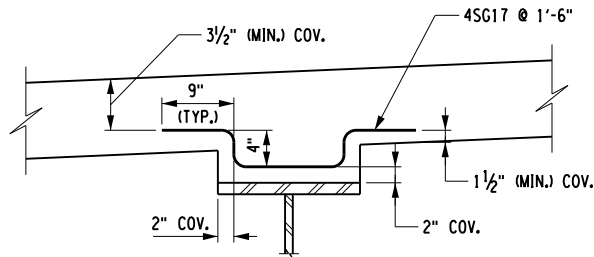

REINFORCED GIRDER HAUNCH DETAIL
NOT TO SCALE

NOTE:

IF THE DEPTH OF THE GIRDER HAUNCH IS GREATER OR EQUAL TO 4" AT ANY POINT ALONG THE GIRDER, THE HAUNCH SHALL BE REINFORCED ACCORDING TO THIS DETAIL.

HAUNCH TABLE - WB

		ϕ OF BRGS. BEGIN ABUT.										ϕ OF BRGS. END ABUT.	
			1/10 L1	2/10 L1	3/10 L1	4/10 L1	5/10 L1	6/10 L1	7/10 L1	8/10 L1	9/10 L1		
GIRDER 1	A	REQ'D BOTTOM OF SLAB ELEVATION AFTER DECK POUR	434.193	434.249	434.305	434.358	434.410	434.460	434.508	434.553	434.597	434.639	434.679
	B	TOP OF STEEL ELEVATION (FIELD MEASURE)											
	C	= A - B (FT)											
	D	CONCRETE NON-COMPOSITE D.L. DEFLECTION (FT)	0.000	0.049	0.092	0.125	0.146	0.153	0.146	0.125	0.092	0.049	0.000
	E	DEPTH OF HAUNCH REQ'D = C + D (FT)											
	F	REQ'D BOTTOM OF SLAB ELEVATION AFTER S.D.L. APPLICATION	434.193	434.241	434.290	434.339	434.387	434.436	434.485	434.533	434.582	434.631	434.679
	G	DECK SURFACE CAMBER A - F (FT) ABOVE PROPOSED GRADE (S.D.L. DEFL.)	0.000	0.008	0.014	0.020	0.023	0.024	0.023	0.020	0.014	0.008	0.000
GIRDER 2	A	REQ'D BOTTOM OF SLAB ELEVATION AFTER DECK POUR	434.326	434.381	434.436	434.489	434.540	434.590	434.638	434.684	434.728	434.771	434.813
	B	TOP OF STEEL ELEVATION (FIELD MEASURE)											
	C	= A - B (FT)											
	D	CONCRETE NON-COMPOSITE D.L. DEFLECTION (FT)	0.000	0.042	0.079	0.108	0.126	0.133	0.126	0.108	0.079	0.043	0.000
	E	DEPTH OF HAUNCH REQ'D = C + D (FT)											
	F	REQ'D BOTTOM OF SLAB ELEVATION AFTER S.D.L. APPLICATION	434.326	434.375	434.423	434.472	434.521	434.569	434.618	434.667	434.715	434.764	434.813
	G	DECK SURFACE CAMBER A - F (FT) ABOVE PROPOSED GRADE (S.D.L. DEFL.)	0.000	0.007	0.012	0.017	0.020	0.021	0.020	0.017	0.012	0.007	0.000
GIRDER 3	A	REQ'D BOTTOM OF SLAB ELEVATION AFTER DECK POUR	434.459	434.515	434.569	434.622	434.674	434.723	434.771	434.817	434.861	434.904	434.946
	B	TOP OF STEEL ELEVATION (FIELD MEASURE)											
	C	= A - B (FT)											
	D	CONCRETE NON-COMPOSITE D.L. DEFLECTION (FT)	0.000	0.042	0.079	0.108	0.126	0.133	0.126	0.108	0.079	0.043	0.000
	E	DEPTH OF HAUNCH REQ'D = C + D (FT)											
	F	REQ'D BOTTOM OF SLAB ELEVATION AFTER S.D.L. APPLICATION	434.459	434.508	434.557	434.605	434.654	434.703	434.751	434.800	434.849	434.897	434.946
	G	DECK SURFACE CAMBER A - F (FT) ABOVE PROPOSED GRADE (S.D.L. DEFL.)	0.000	0.007	0.012	0.017	0.020	0.021	0.020	0.017	0.012	0.007	0.000
GIRDER 4	A	REQ'D BOTTOM OF SLAB ELEVATION AFTER DECK POUR	434.554	434.610	434.664	434.717	434.769	434.818	434.866	434.912	434.956	434.999	435.041
	B	TOP OF STEEL ELEVATION (FIELD MEASURE)											
	C	= A - B (FT)											
	D	CONCRETE NON-COMPOSITE D.L. DEFLECTION (FT)	0.000	0.042	0.079	0.108	0.126	0.133	0.126	0.108	0.079	0.043	0.000
	E	DEPTH OF HAUNCH REQ'D = C + D (FT)											
	F	REQ'D BOTTOM OF SLAB ELEVATION AFTER S.D.L. APPLICATION	434.554	434.603	434.652	434.700	434.749	434.798	434.846	434.895	434.944	434.992	435.041
	G	DECK SURFACE CAMBER A - F (FT) ABOVE PROPOSED GRADE (S.D.L. DEFL.)	0.000	0.007	0.012	0.017	0.020	0.021	0.020	0.017	0.012	0.007	0.000
GIRDER 5	A	REQ'D BOTTOM OF SLAB ELEVATION AFTER DECK POUR	434.398	434.453	434.508	434.561	434.612	434.662	434.709	434.755	434.799	434.842	434.884
	B	TOP OF STEEL ELEVATION (FIELD MEASURE)											
	C	= A - B (FT)											
	D	CONCRETE NON-COMPOSITE D.L. DEFLECTION (FT)	0.000	0.042	0.079	0.108	0.126	0.133	0.126	0.108	0.079	0.043	0.000
	E	DEPTH OF HAUNCH REQ'D = C + D (FT)											
	F	REQ'D BOTTOM OF SLAB ELEVATION AFTER S.D.L. APPLICATION	434.398	434.446	434.495	434.544	434.592	434.641	434.690	434.738	434.787	434.836	434.884
	G	DECK SURFACE CAMBER A - F (FT) ABOVE PROPOSED GRADE (S.D.L. DEFL.)	0.000	0.007	0.012	0.017	0.020	0.021	0.020	0.017	0.012	0.007	0.000
GIRDER 6	A	REQ'D BOTTOM OF SLAB ELEVATION AFTER DECK POUR	434.241	434.296	434.351	434.404	434.455	434.505	434.553	434.599	434.643	434.686	434.728
	B	TOP OF STEEL ELEVATION (FIELD MEASURE)											
	C	= A - B (FT)											
	D	CONCRETE NON-COMPOSITE D.L. DEFLECTION (FT)	0.000	0.042	0.079	0.108	0.126	0.133	0.126	0.108	0.079	0.043	0.000
	E	DEPTH OF HAUNCH REQ'D = C + D (FT)											
	F	REQ'D BOTTOM OF SLAB ELEVATION AFTER S.D.L. APPLICATION	434.241	434.290	434.338	434.387	434.436	434.484	434.533	434.582	434.630	434.679	434.728
	G	DECK SURFACE CAMBER A - F (FT) ABOVE PROPOSED GRADE (S.D.L. DEFL.)	0.000	0.007	0.012	0.017	0.020	0.021	0.020	0.017	0.012	0.007	0.000
GIRDER 7	A	REQ'D BOTTOM OF SLAB ELEVATION AFTER DECK POUR	434.085	434.140	434.194	434.247	434.299	434.348	434.396	434.442	434.486	434.529	434.571
	B	TOP OF STEEL ELEVATION (FIELD MEASURE)											
	C	= A - B (FT)											
	D	CONCRETE NON-COMPOSITE D.L. DEFLECTION (FT)	0.000	0.042	0.079	0.108	0.126	0.133	0.126	0.108	0.079	0.043	0.000
	E	DEPTH OF HAUNCH REQ'D = C + D (FT)											
	F	REQ'D BOTTOM OF SLAB ELEVATION AFTER S.D.L. APPLICATION	434.085	434.133	434.182	434.230	434.279	434.328	434.376	434.425	434.474	434.522	434.571
	G	DECK SURFACE CAMBER A - F (FT) ABOVE PROPOSED GRADE (S.D.L. DEFL.)	0.000	0.007	0.012	0.017	0.020	0.021	0.020	0.017	0.012	0.007	0.000
GIRDER 8	A	REQ'D BOTTOM OF SLAB ELEVATION AFTER DECK POUR	433.928	433.984	434.040	434.093	434.145	434.195	434.243	434.288	434.332	434.374	434.414
	B	TOP OF STEEL ELEVATION (FIELD MEASURE)											
	C	= A - B (FT)											
	D	CONCRETE NON-COMPOSITE D.L. DEFLECTION (FT)	0.000	0.049	0.092	0.125	0.146	0.153	0.146	0.125	0.092	0.049	0.000
	E	DEPTH OF HAUNCH REQ'D = C + D (FT)											
	F	REQ'D BOTTOM OF SLAB ELEVATION AFTER S.D.L. APPLICATION	433.928	433.977	434.025	434.074	434.122	434.171	434.220	434.268	434.317	434.366	434.414
	G	DECK SURFACE CAMBER A - F (FT) ABOVE PROPOSED GRADE (S.D.L. DEFL.)	0.000	0.008	0.014	0.020	0.023	0.024	0.023	0.020	0.014	0.008	0.000

NOTE:

THE CONTRACTOR SHALL PROVIDE THE ENGINEER WITH THE COMPLETED HAUNCH TABLE PRIOR TO SETTING THE BOTTOM FORMWORK OF THE DECK

ALTERED ON: _____ AFFIXED ON: 12/04/2023

SIGNATURE: _____ SIGNATURE: _____
 STAMP: _____ STAMP: _____

IT IS A VIOLATION OF LAW FOR ANY PERSON, UNLESS THEY ARE ACTING UNDER THE DIRECTION OF A LICENSED PROFESSIONAL ENGINEER, ARCHITECT, LANDSCAPE ARCHITECT, OR LAND SURVEYOR, TO ALTER AN ITEM IN ANY WAY. IF AN ITEM BEARING THE STAMP OF A LICENSED PROFESSIONAL IS ALTERED, THE ALTERING ENGINEER, ARCHITECT, LANDSCAPE ARCHITECT, OR LAND SURVEYOR SHALL STAMP THE DOCUMENT AND INCLUDE THE NOTATION "ALTERED BY" FOLLOWED BY THEIR SIGNATURE. THE DATE OF SUCH ALTERATION, AND A SPECIFIC DESCRIPTION OF THE ALTERATION.

REVISIONS			
DATE	DESCRIPTION	BY	SYM.

NEW YORK STATE OF OPPORTUNITY | Thruway Authority

ERDMAN ANTHONY

TITLE OF PROJECT: STERLING CREEK BRIDGE REHABILITATION
 LOCATION OF PROJECT: SYRACUSE DIVISION
 BIN 5516091 & 5516092 MP 227.40 & MP 227.41
 TITLE OF DRAWING: HAUNCH TABLE (WESTBOUND)

CONTRACT NUMBER: TAS 24-5B
 DATE: NOV. 2023
 DRAWING NUMBER: ST-32

MOMENT AND SHEAR TABLE		CL BEGIN BRGS.	SPAN 1									CL END BRGS.	
			1/10 L ₁ FT	2/10 L ₁ FT	3/10 L ₁ FT	4/10 L ₁ FT	5/10 L ₁ FT	6/10 L ₁ FT	7/10 L ₁ FT	8/10 L ₁ FT	9/10 L ₁ FT		
INTERIOR GIRDER	DEAD LOAD	MOMENT	0.00	371.00	662.00	870.00	995.00	1037.00	995.00	870.00	662.00	371.00	0.00
		SHEAR	50.63	40.86	30.83	20.55	10.28	0.00	-10.28	-20.55	-30.83	-40.86	-50.63
	SUPERIMPOSED DEAD LOAD	MOMENT	0.00	83.00	149.00	196.00	223.00	232.00	223.00	196.00	149.00	83.00	0.00
		SHEAR	11.47	9.18	6.88	4.59	2.30	0.00	-2.30	-4.59	-6.88	-9.18	-11.47
	LIVE LOAD (+)	MOMENT	0.00	477.00	855.00	1107.00	1263.00	1296.00	1263.00	1107.00	855.00	477.00	0.00
		SHEAR	88.67	77.05	65.29	54.16	43.65	33.73	24.92	16.70	9.17	3.58	0.00
	LIVE LOAD (-)	MOMENT	0.00	0.00	0.00	0.00	0.00	0.00	0.00	0.00	0.00	0.00	0.00
		SHEAR	0.00	-3.58	-7.73	-16.70	-24.92	-33.73	-43.65	-54.16	-65.29	-77.05	-88.67
	D.P.V. (+)	MOMENT	0.00	0.00	0.00	0.00	0.00	0.00	0.00	0.00	0.00	0.00	0.00
		SHEAR	0.00	0.00	0.00	0.00	0.00	0.00	0.00	0.00	0.00	0.00	0.00
	D.P.V. (-)	MOMENT	0.00	0.00	0.00	0.00	0.00	0.00	0.00	0.00	0.00	0.00	0.00
		SHEAR	0.00	0.00	0.00	0.00	0.00	0.00	0.00	0.00	0.00	0.00	0.00
EXTERIOR GIRDER	DEAD LOAD	MOMENT	0.00	348.00	621.00	817.00	934.00	973.00	934.00	817.00	621.00	348.00	0.00
		SHEAR	47.50	38.33	28.93	19.29	9.64	0.00	-9.64	-19.29	-28.93	-38.33	-47.50
	SUPERIMPOSED DEAD LOAD	MOMENT	0.00	83.00	149.00	196.00	223.00	232.00	223.00	196.00	149.00	83.00	0.00
		SHEAR	11.47	9.18	6.88	4.59	2.30	0.00	-2.30	-4.59	-6.88	-9.18	-11.47
	LIVE LOAD (+)	MOMENT	0.00	460.00	805.00	1043.00	1189.00	1221.00	1189.00	1043.00	805.00	460.00	0.00
		SHEAR	68.11	59.14	50.09	41.52	33.44	25.82	19.09	12.80	7.03	2.75	0.00
	LIVE LOAD (-)	MOMENT	0.00	0.00	0.00	0.00	0.00	0.00	0.00	0.00	0.00	0.00	0.00
		SHEAR	0.00	-2.75	-5.93	-12.80	-19.09	-25.82	-33.44	-41.52	-50.09	-59.14	-68.11
	D.P.V. (+)	MOMENT	0.00	0.00	0.00	0.00	0.00	0.00	0.00	0.00	0.00	0.00	0.00
		SHEAR	0.00	0.00	0.00	0.00	0.00	0.00	0.00	0.00	0.00	0.00	0.00
	D.P.V. (-)	MOMENT	0.00	0.00	0.00	0.00	0.00	0.00	0.00	0.00	0.00	0.00	0.00
		SHEAR	0.00	0.00	0.00	0.00	0.00	0.00	0.00	0.00	0.00	0.00	0.00


LIVE LOAD MOMENTS AND SHEARS INCLUDE IMPACT
MOMENTS ARE EXPRESSED AS KIP-FEET, AND ARE UNFACTORED
SHEARS ARE EXPRESSED AS KIP, AND ARE UNFACTORED
D.P.V. = DESIGN PERMIT VEHICLE

DESIGN LOAD TABLE			
	UNIT	LOAD K/ft.	
INTERIOR GIRDERS (G2-G7)	D.L.	SLAB	0.861
		HAUNCH	0.075
		GIRDER	0.292
		S.I.P. FORMS	0.024
		DIAPHRAGMS	0.016
		UTILITIES	
	TOTAL	1.268	
S.D.L.	BARRIER	0.150	
	FUTURE W.S.	0.133	
	TOTAL	0.283	

DESIGN LOAD TABLE			
	UNIT	LOAD K/ft.	
EXTERIOR GIRDERS (G1, G8)	D.L.	SLAB	0.872
		HAUNCH	0.044
		GIRDER	0.254
		S.I.P. FORMS	0.012
		DIAPHRAGMS	0.008
		UTILITIES	
	TOTAL	1.190	
S.D.L.	BARRIER	0.150	
	FUTURE W.S.	0.133	
	TOTAL	0.283	




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USER = LINDO

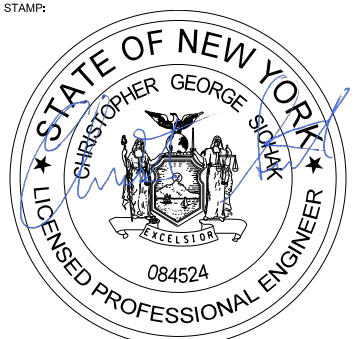DESIGN SUPERVISOR: C. SICHAK
DRAFTED BY: T. LINDO
CHECKED BY: N. BARNHARD


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SIGNATURE: STAMP:	SIGNATURE: STAMP: 

IT IS A VIOLATION OF LAW FOR ANY PERSON, UNLESS THEY ARE ACTING UNDER THE DIRECTION OF A LICENSED PROFESSIONAL ENGINEER, ARCHITECT, LANDSCAPE ARCHITECT, OR LAND SURVEYOR, TO ALTER AN ITEM IN ANY WAY. IF AN ITEM BEARING THE STAMP OF A LICENSED PROFESSIONAL IS ALTERED, THE ALTERING ENGINEER, ARCHITECT, LANDSCAPE ARCHITECT, OR LAND SURVEYOR SHALL STAMP THE DOCUMENT AND INCLUDE THE NOTATION "ALTERED BY" FOLLOWED BY THEIR SIGNATURE. THE DATE OF SUCH ALTERATION, AND A SPECIFIC DESCRIPTION OF THE ALTERATION.


REVISIONS			
DATE	DESCRIPTION	BY	SYM.

 	TITLE OF PROJECT STERLING CREEK BRIDGE REHABILITATION	CONTRACT NUMBER: TAS 24-5B
	LOCATION OF PROJECT SYRACUSE DIVISION BIN 5516091 & 5516092 MP 227.40 & MP 227.41	DATE: NOV. 2023
	TITLE OF DRAWING MOMENT AND SHEAR & DESIGN LOAD TABLES	DRAWING NUMBER: ST-33


CHECKED BY: N. BARNHARD
 DRAFTED BY: T. LINDO
 CHECKED BY: N. BARNHARD
 DESIGNED BY: C. SICHAK

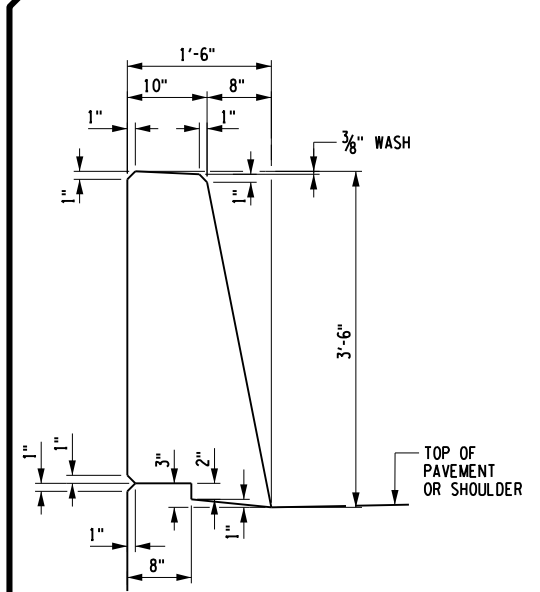


TYPICAL SECTION

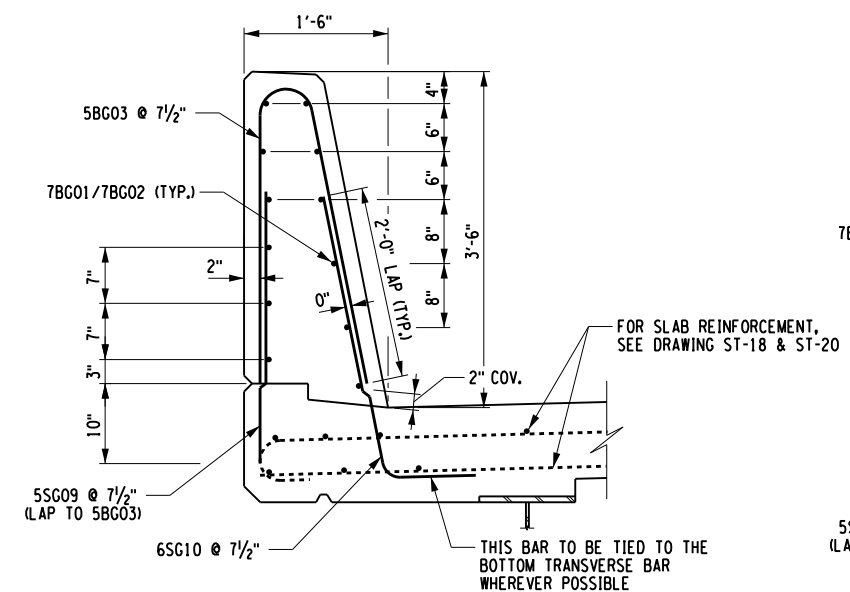


SECTION A-A

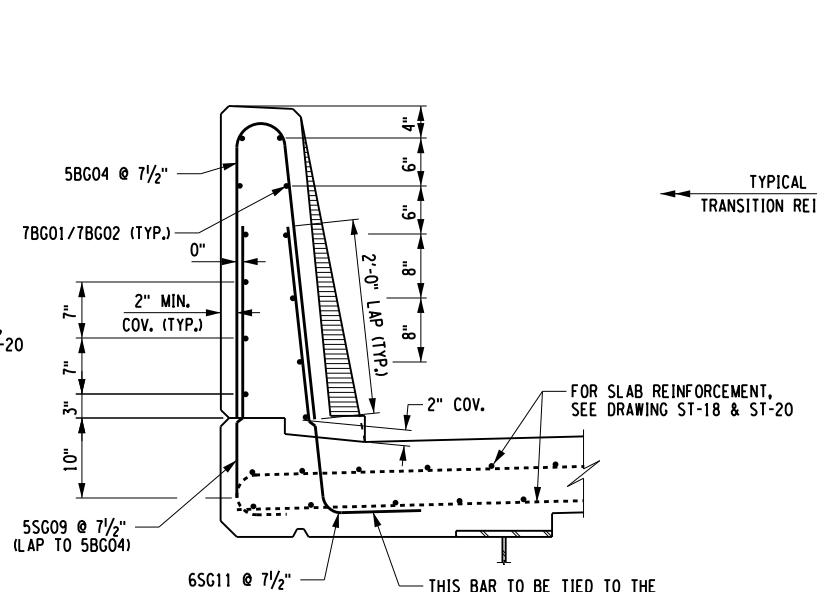


SECTION B-B

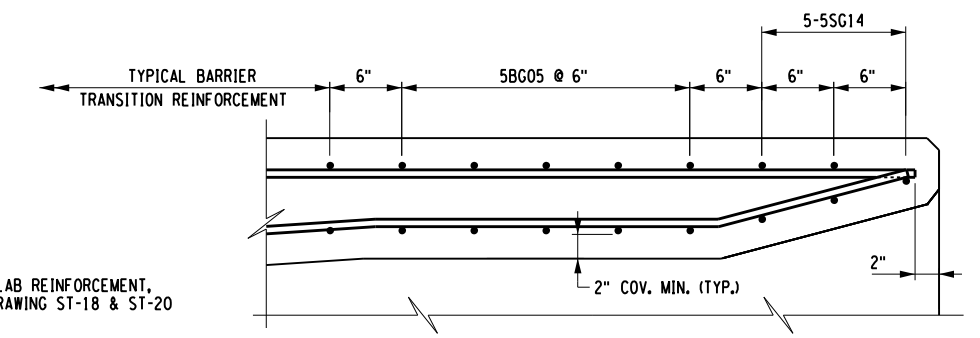


REINFORCEMENT PLAN
TRANSITION CONCRETE BARRIER END DETAIL

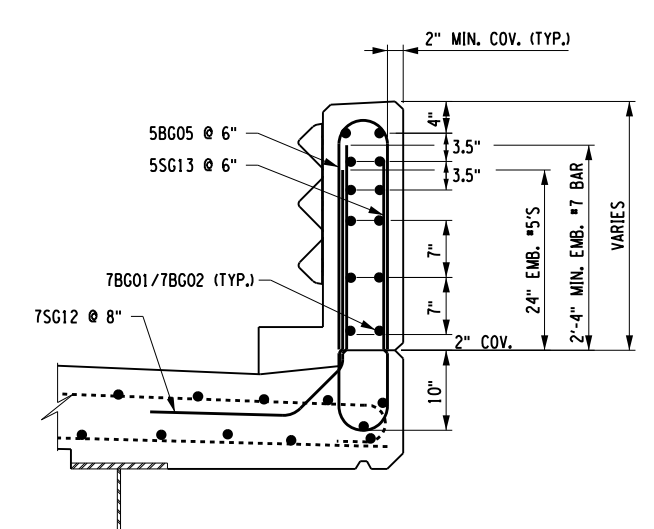

SECTION C-C

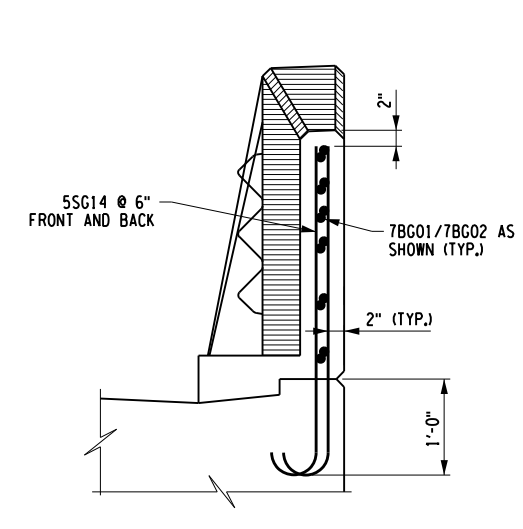


SECTION D-D

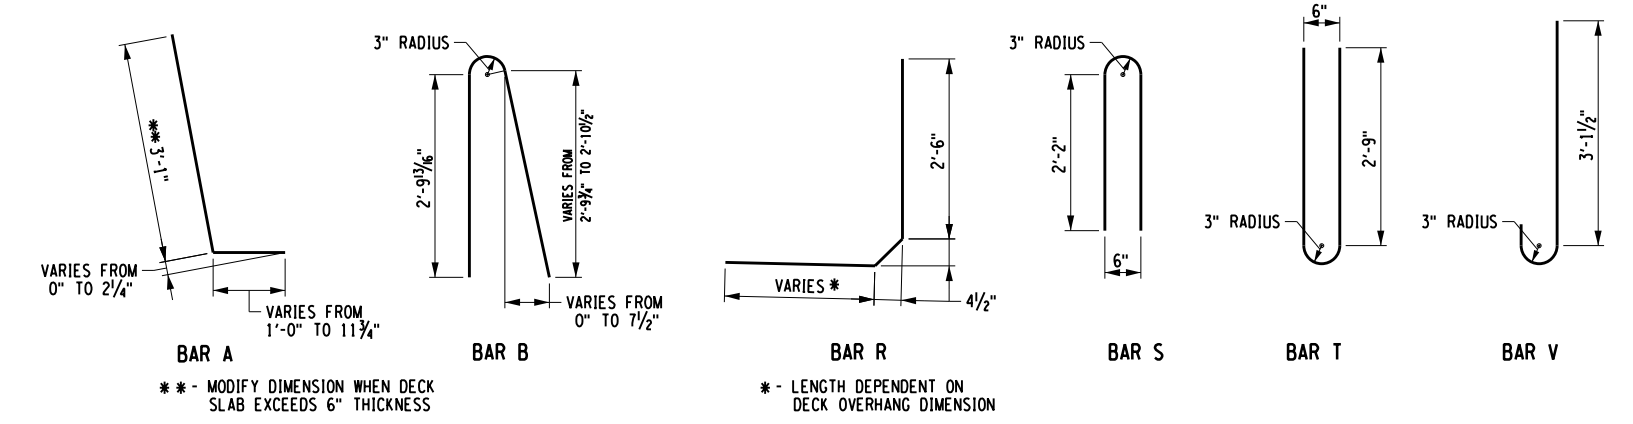

BAR TYPES

- NOTES:
- (G) DENOTES GALVANIZED COATED BARS
 - LAP LENGTH OF A #4 BAR = 1'-11"
 - LAP LENGTH OF A #5 BAR = 2'-4"
 - LAP LENGTH OF A #7 BAR = 3'-3"

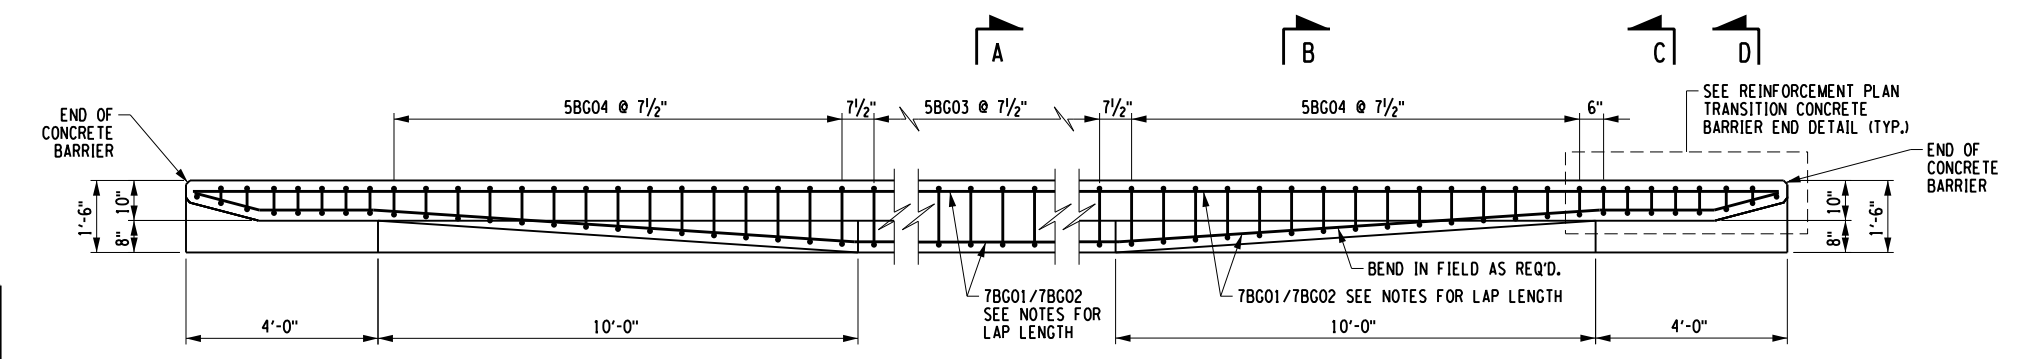

BARRIER REINFORCEMENT PLAN

ALTERED ON:	AFFIXED ON: 12/04/2023
SIGNATURE: STAMP:	SIGNATURE: STAMP:






IT IS A VIOLATION OF LAW FOR ANY PERSON, UNLESS THEY ARE ACTING UNDER THE DIRECTION OF A LICENSED PROFESSIONAL ENGINEER, ARCHITECT, LANDSCAPE ARCHITECT, OR LAND SURVEYOR, TO ALTER AN ITEM IN ANY WAY. IF AN ITEM BEARING THE STAMP OF A LICENSED PROFESSIONAL IS ALTERED, THE ALTERING ENGINEER, ARCHITECT, LANDSCAPE ARCHITECT, OR LAND SURVEYOR SHALL STAMP THE DOCUMENT AND INCLUDE THE NOTATION "ALTERED BY" FOLLOWED BY THEIR SIGNATURE. THE DATE OF SUCH ALTERATION, AND A SPECIFIC DESCRIPTION OF THE ALTERATION.

REVISIONS			
DATE	DESCRIPTION	BY	SYM.

TITLE OF PROJECT STERLING CREEK BRIDGE REHABILITATION	CONTRACT NUMBER: TAS 24-5B
LOCATION OF PROJECT SYRACUSE DIVISION BIN 5516091 & 5516092 MP 227.40 & MP 227.41	DATE: NOV. 2023
TITLE OF DRAWING BARRIER DETAILS	DRAWING NUMBER: ST-34

CHECKED BY: N. BARNHARD
 DRAFTED BY: T. LINDO
 CHECKED BY: N. BARNHARD
 DESIGNED BY: N. BARNHARD
 DESIGN SUPERVISOR: C. SICHAK

FILE NAME = N:\19710-05-Sterling\Drawings\Structures\B2221-cpb.d11_rlg1.dgn
 DATE/TIME = 12/4/2023 3:21:08 PM
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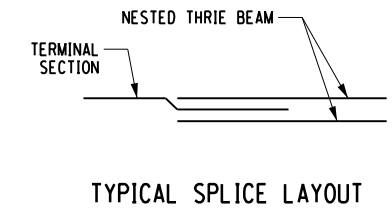
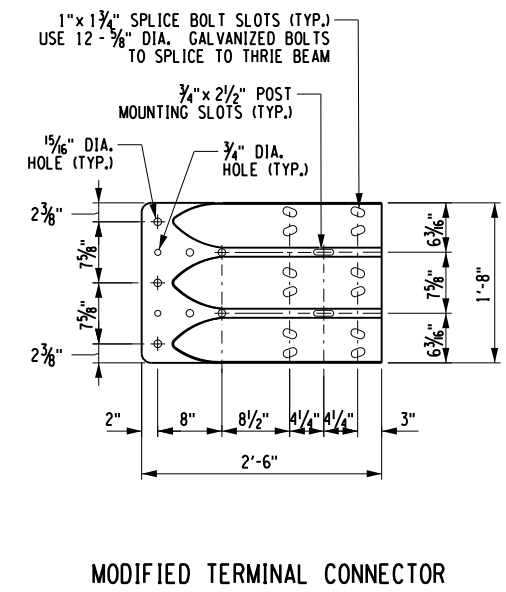
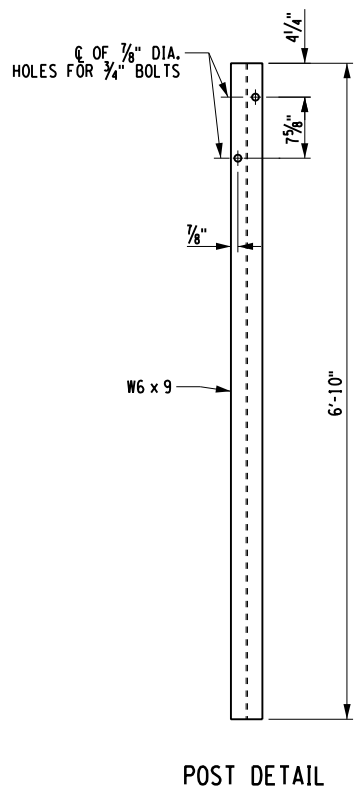
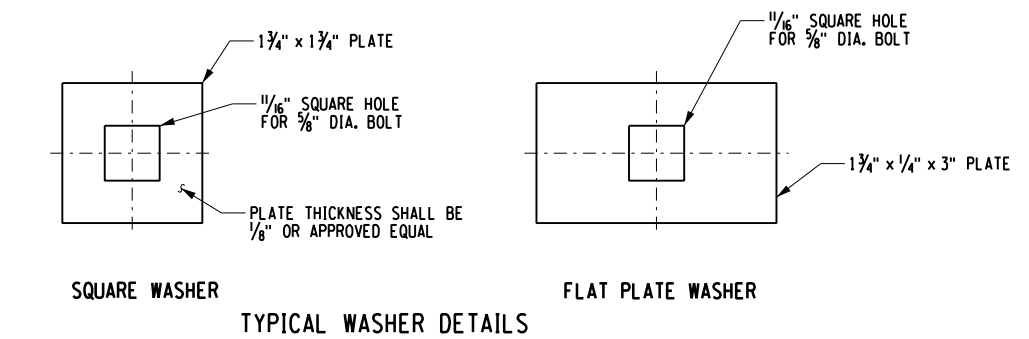
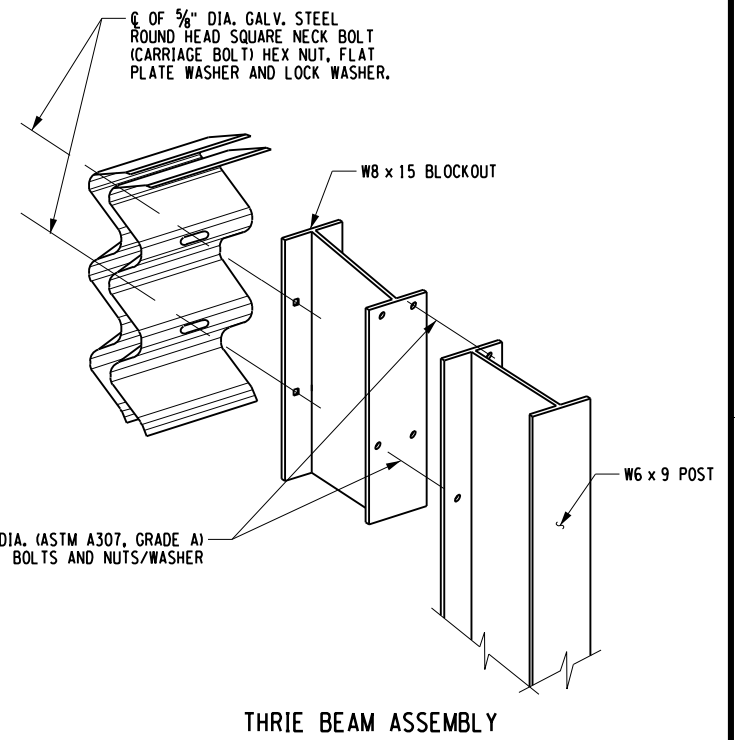
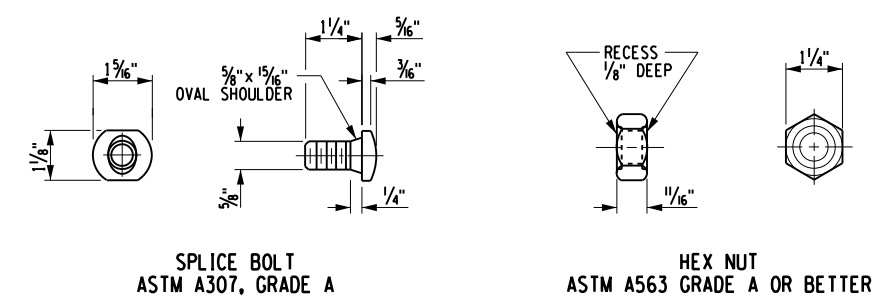
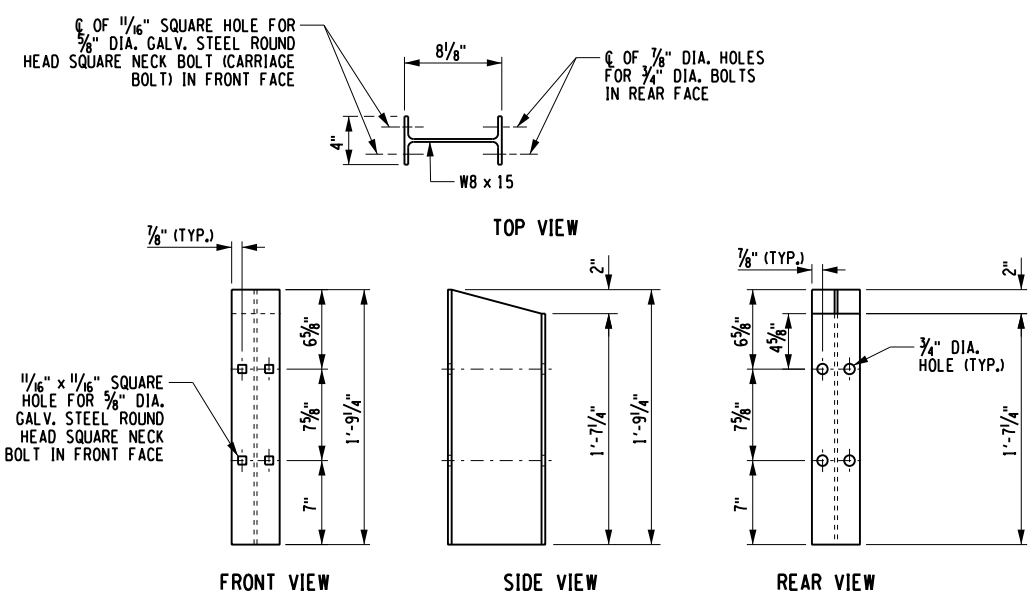
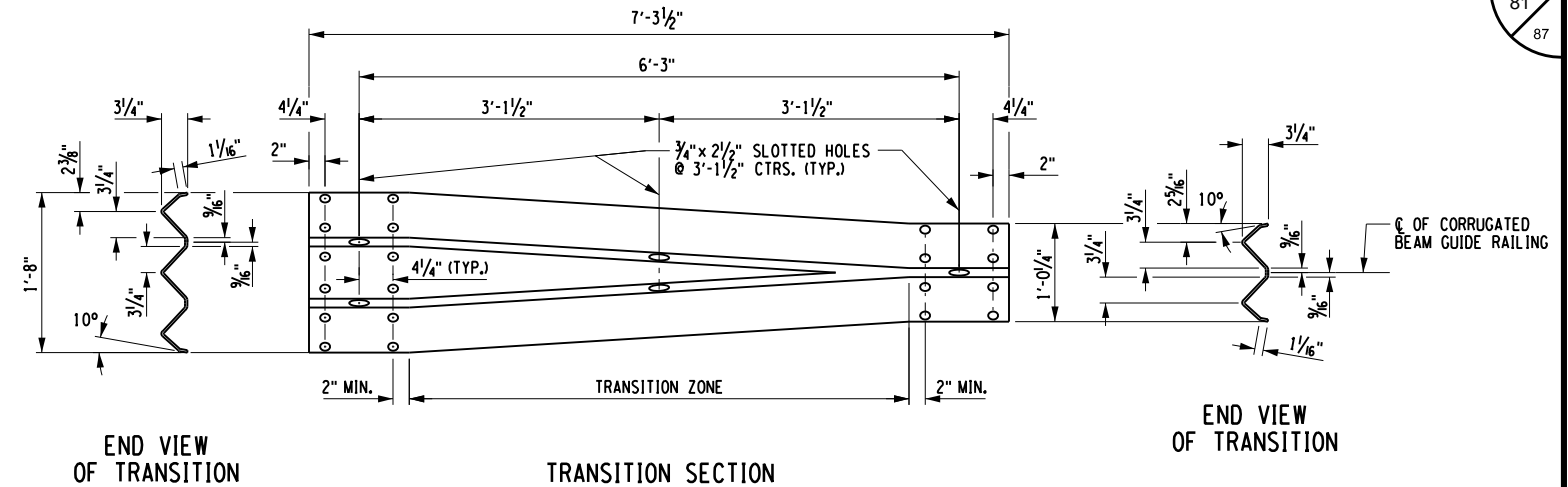
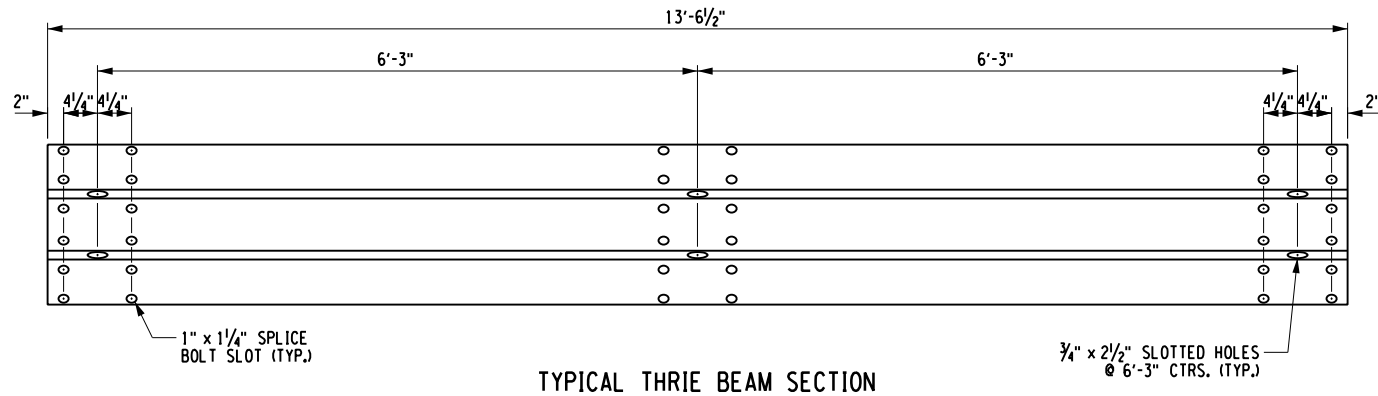
ALTERED ON:	AFFIXED ON: 12/04/2023
SIGNATURE: STAMP:	SIGNATURE: STAMP:
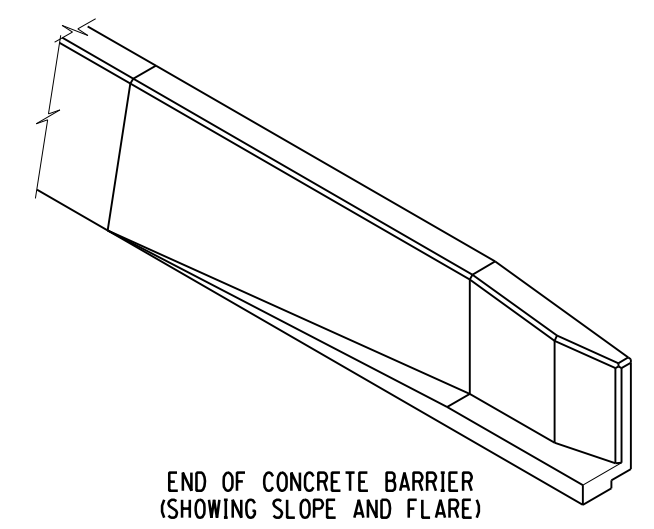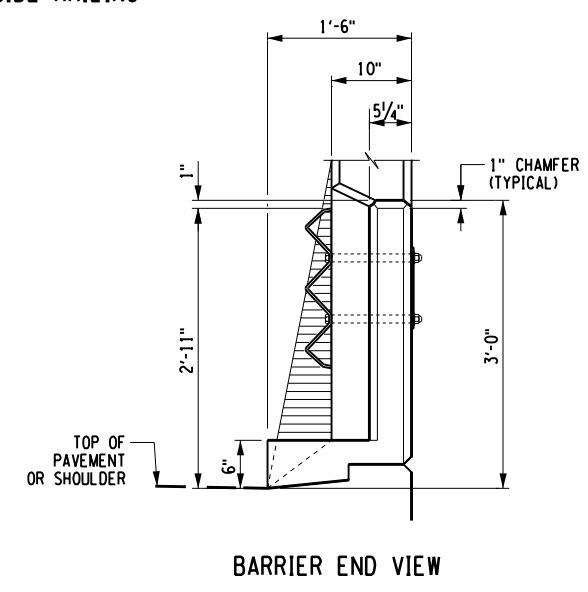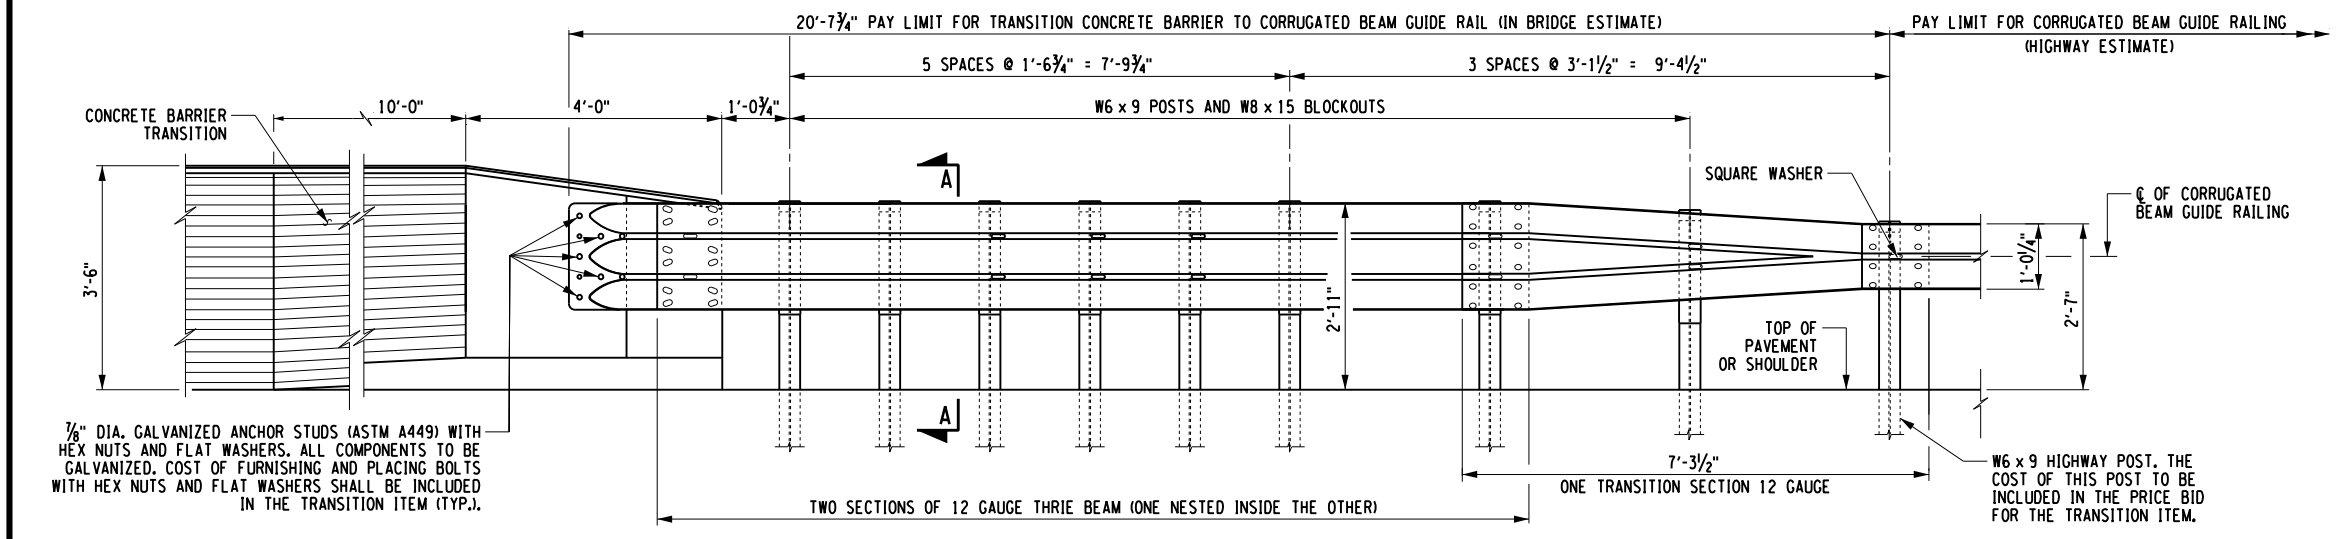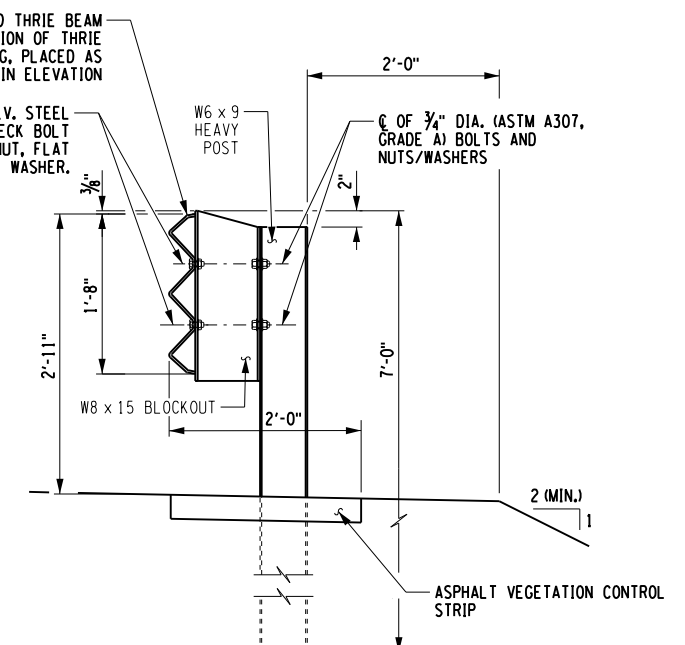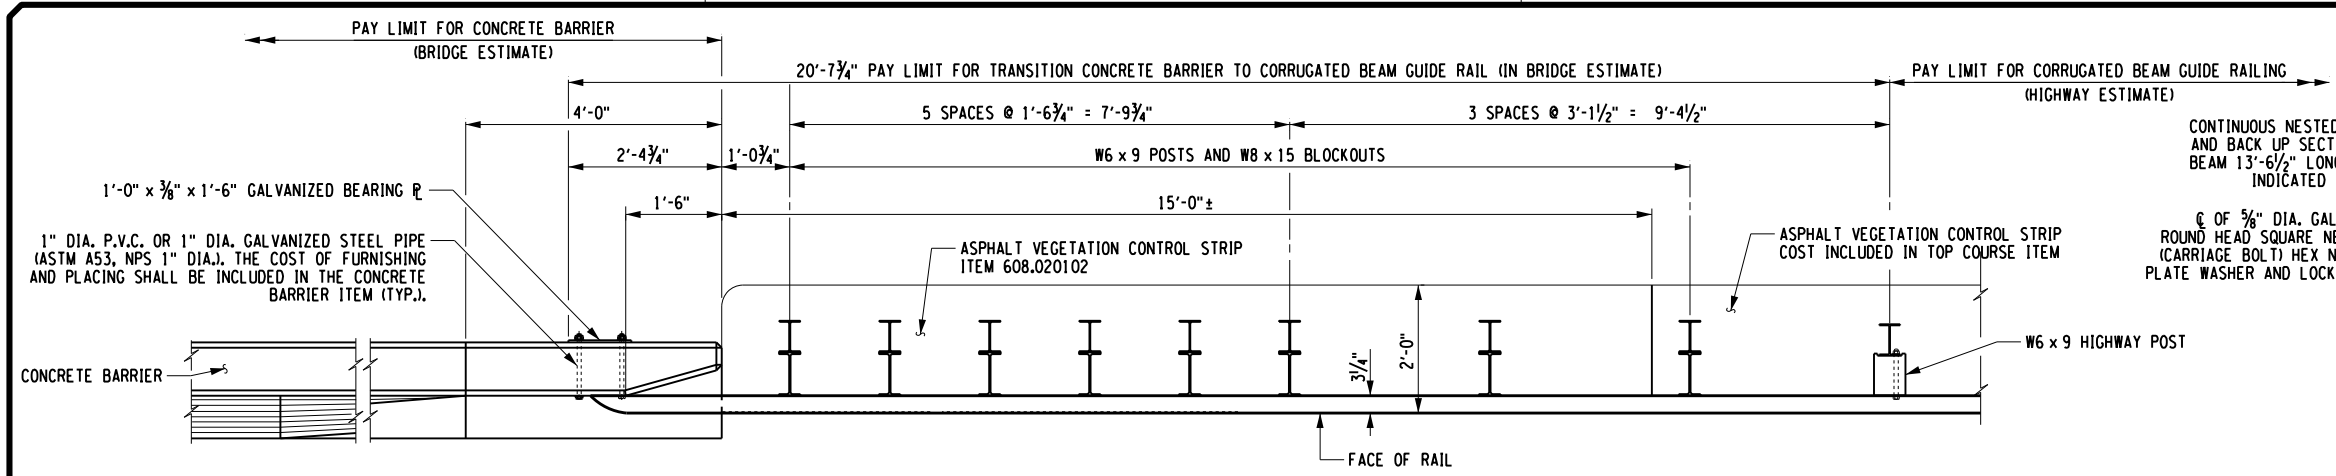
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REVISIONS			
DATE	DESCRIPTION	BY	SYM.

 Thruway Authority 	TITLE OF PROJECT STERLING CREEK BRIDGE REHABILITATION	CONTRACT NUMBER: TAS 24-5B
	LOCATION OF PROJECT SYRACUSE DIVISION BIN 5516091 & 5516092 MP 227.40 & MP 227.41	DATE: NOV. 2023
	TITLE OF DRAWING RAILING DETAILS (1 OF 2)	DRAWING NUMBER: ST-35

CHECKED BY: N. BARNHARD
 DRAFTED BY: T. LINDO
 CHECKED BY: N. BARNHARD
 DESIGNED BY: C. SICHAK





ALTERED ON:	AFFIXED ON: 12/04/2023
SIGNATURE: STAMP:	SIGNATURE: STAMP:

IT IS A VIOLATION OF LAW FOR ANY PERSON, UNLESS THEY ARE ACTING UNDER THE DIRECTION OF A LICENSED PROFESSIONAL ENGINEER, ARCHITECT, LANDSCAPE ARCHITECT, OR LAND SURVEYOR, TO ALTER AN ITEM IN ANY WAY. IF AN ITEM BEARING THE STAMP OF A LICENSED PROFESSIONAL IS ALTERED, THE ALTERING ENGINEER, ARCHITECT, LANDSCAPE ARCHITECT, OR LAND SURVEYOR SHALL STAMP THE DOCUMENT AND INCLUDE THE NOTATION "ALTERED BY" FOLLOWED BY THEIR SIGNATURE, THE DATE OF SUCH ALTERATION, AND A SPECIFIC DESCRIPTION OF THE ALTERATION.

REVISIONS			
DATE	DESCRIPTION	BY	SYM.

	TITLE OF PROJECT STERLING CREEK BRIDGE REHABILITATION	CONTRACT NUMBER: TAS 24-5B
	LOCATION OF PROJECT SYRACUSE DIVISION BIN 5516091 & 5516092 MP 227.40 & MP 227.41	DATE: NOV. 2023
	TITLE OF DRAWING RAILING DETAILS (2 OF 2)	DRAWING NUMBER: ST-36

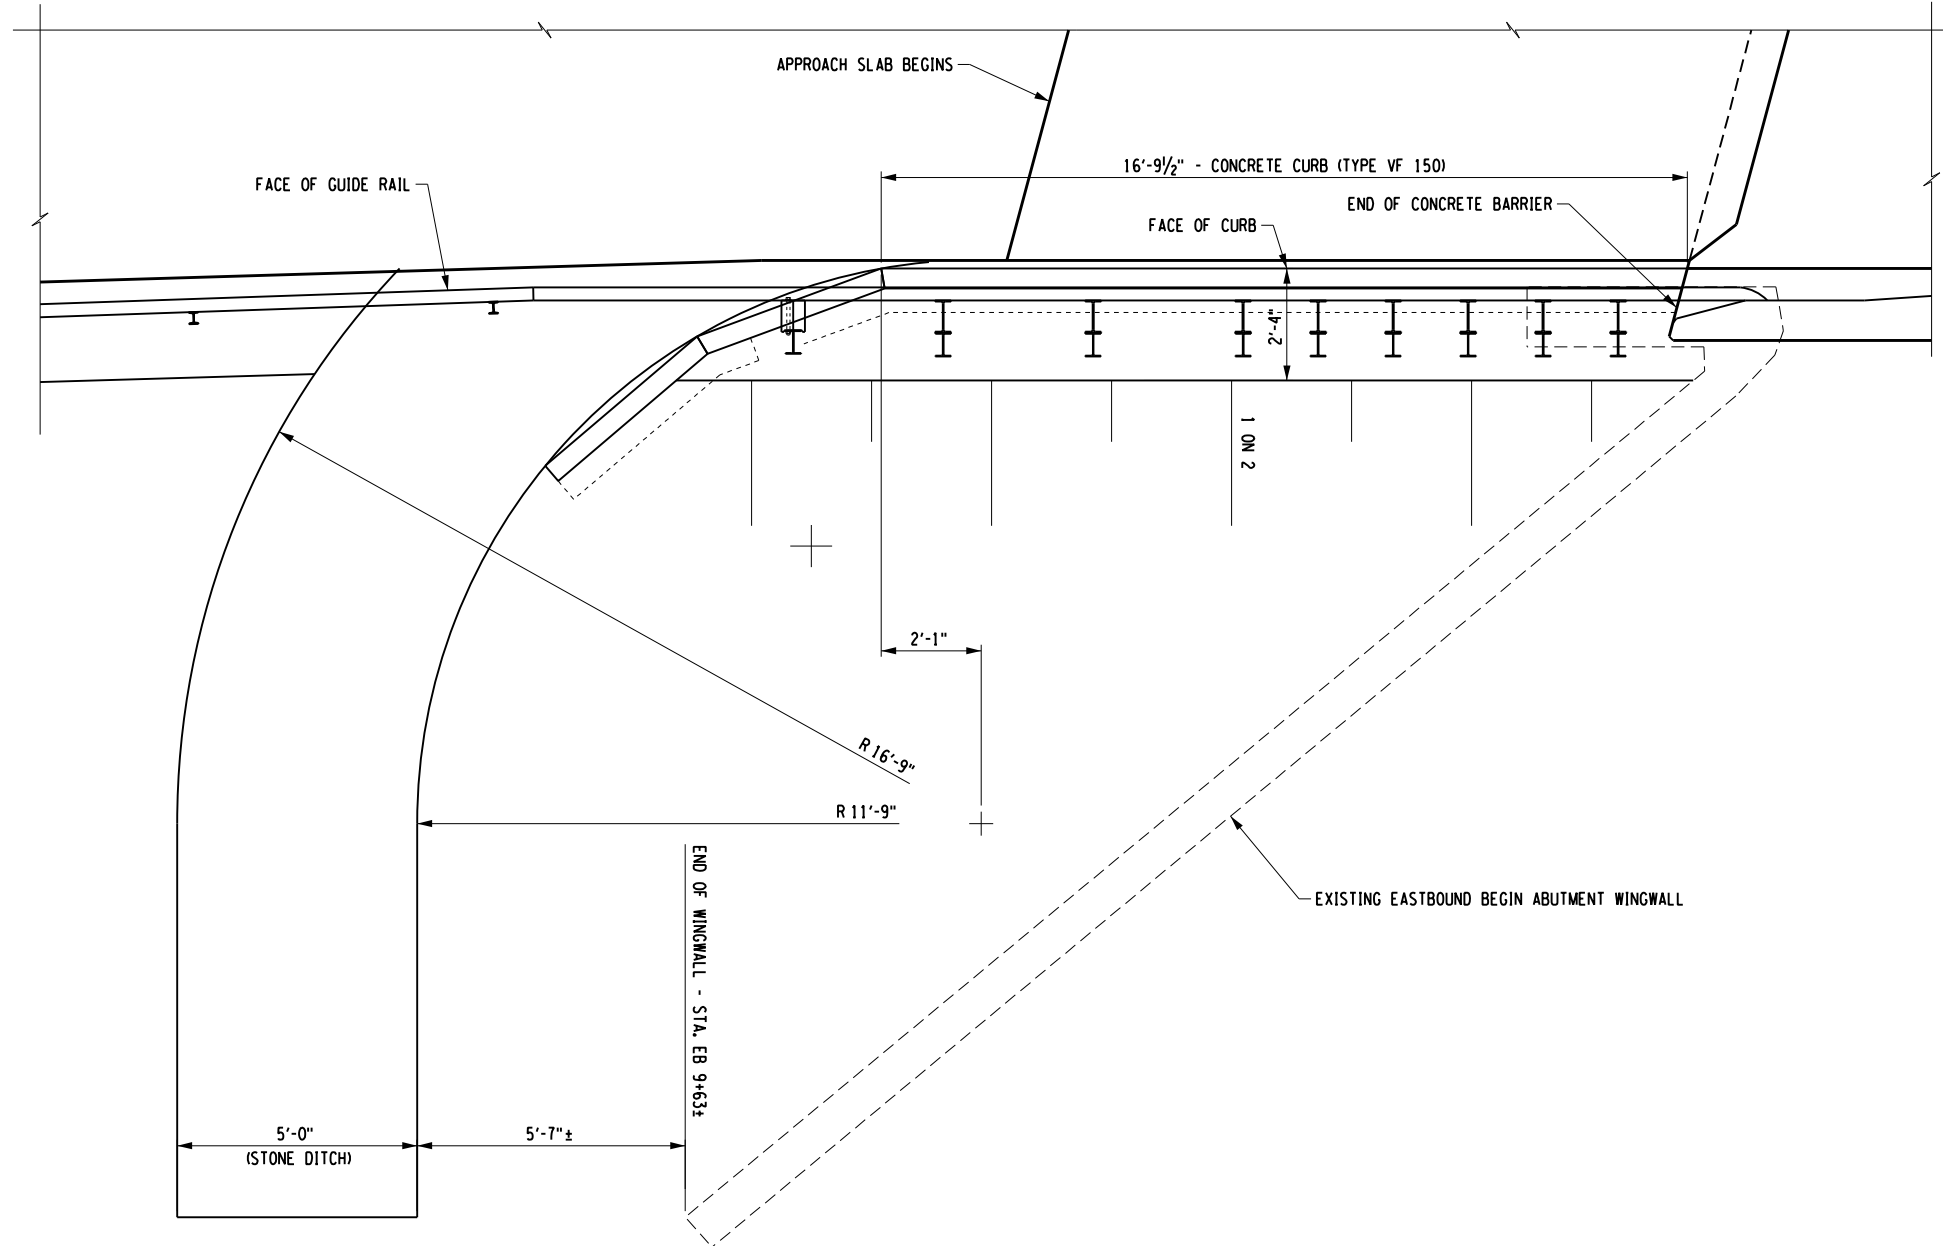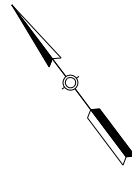

NOTES:

1. FOR CONCRETE BARRIER DETAILS, SEE DWG. NO.'S ST-34 TO ST-36.
2. FOR APPROACH DRAINAGE DETAILS, SEE DWG. NO. ST-39.
3. BRIDGE SUPERSTRUCTURE NOT SHOWN FOR CLARITY.

EASTBOUND BEGIN APPROACH DRAINAGE PLAN

SCALE: 1/4" = 1'-0"

CHECKED BY: N. BARNHARD

DRAFTED BY: T. LINDO

CHECKED BY: N. BARNHARD

DESIGNED BY: C. SICHAK

DESIGN SUPERVISOR: C. SICHAK

ALTERED ON:	AFFIXED ON: 12/04/2023
SIGNATURE: STAMP:	SIGNATURE: STAMP:

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REVISIONS			
DATE	DESCRIPTION	BY	SYM.



TITLE OF PROJECT
STERLING CREEK BRIDGE REHABILITATION



LOCATION OF PROJECT
SYRACUSE DIVISION
BIN 5516091 & 5516092 MP 227.40 & MP 227.41

TITLE OF DRAWING
APPROACH DRAINAGE
BEGIN ABUTMENT
(EASTBOUND)

CONTRACT NUMBER:
TAS 24-5B

DATE:
NOV. 2023

DRAWING NUMBER:
ST-37

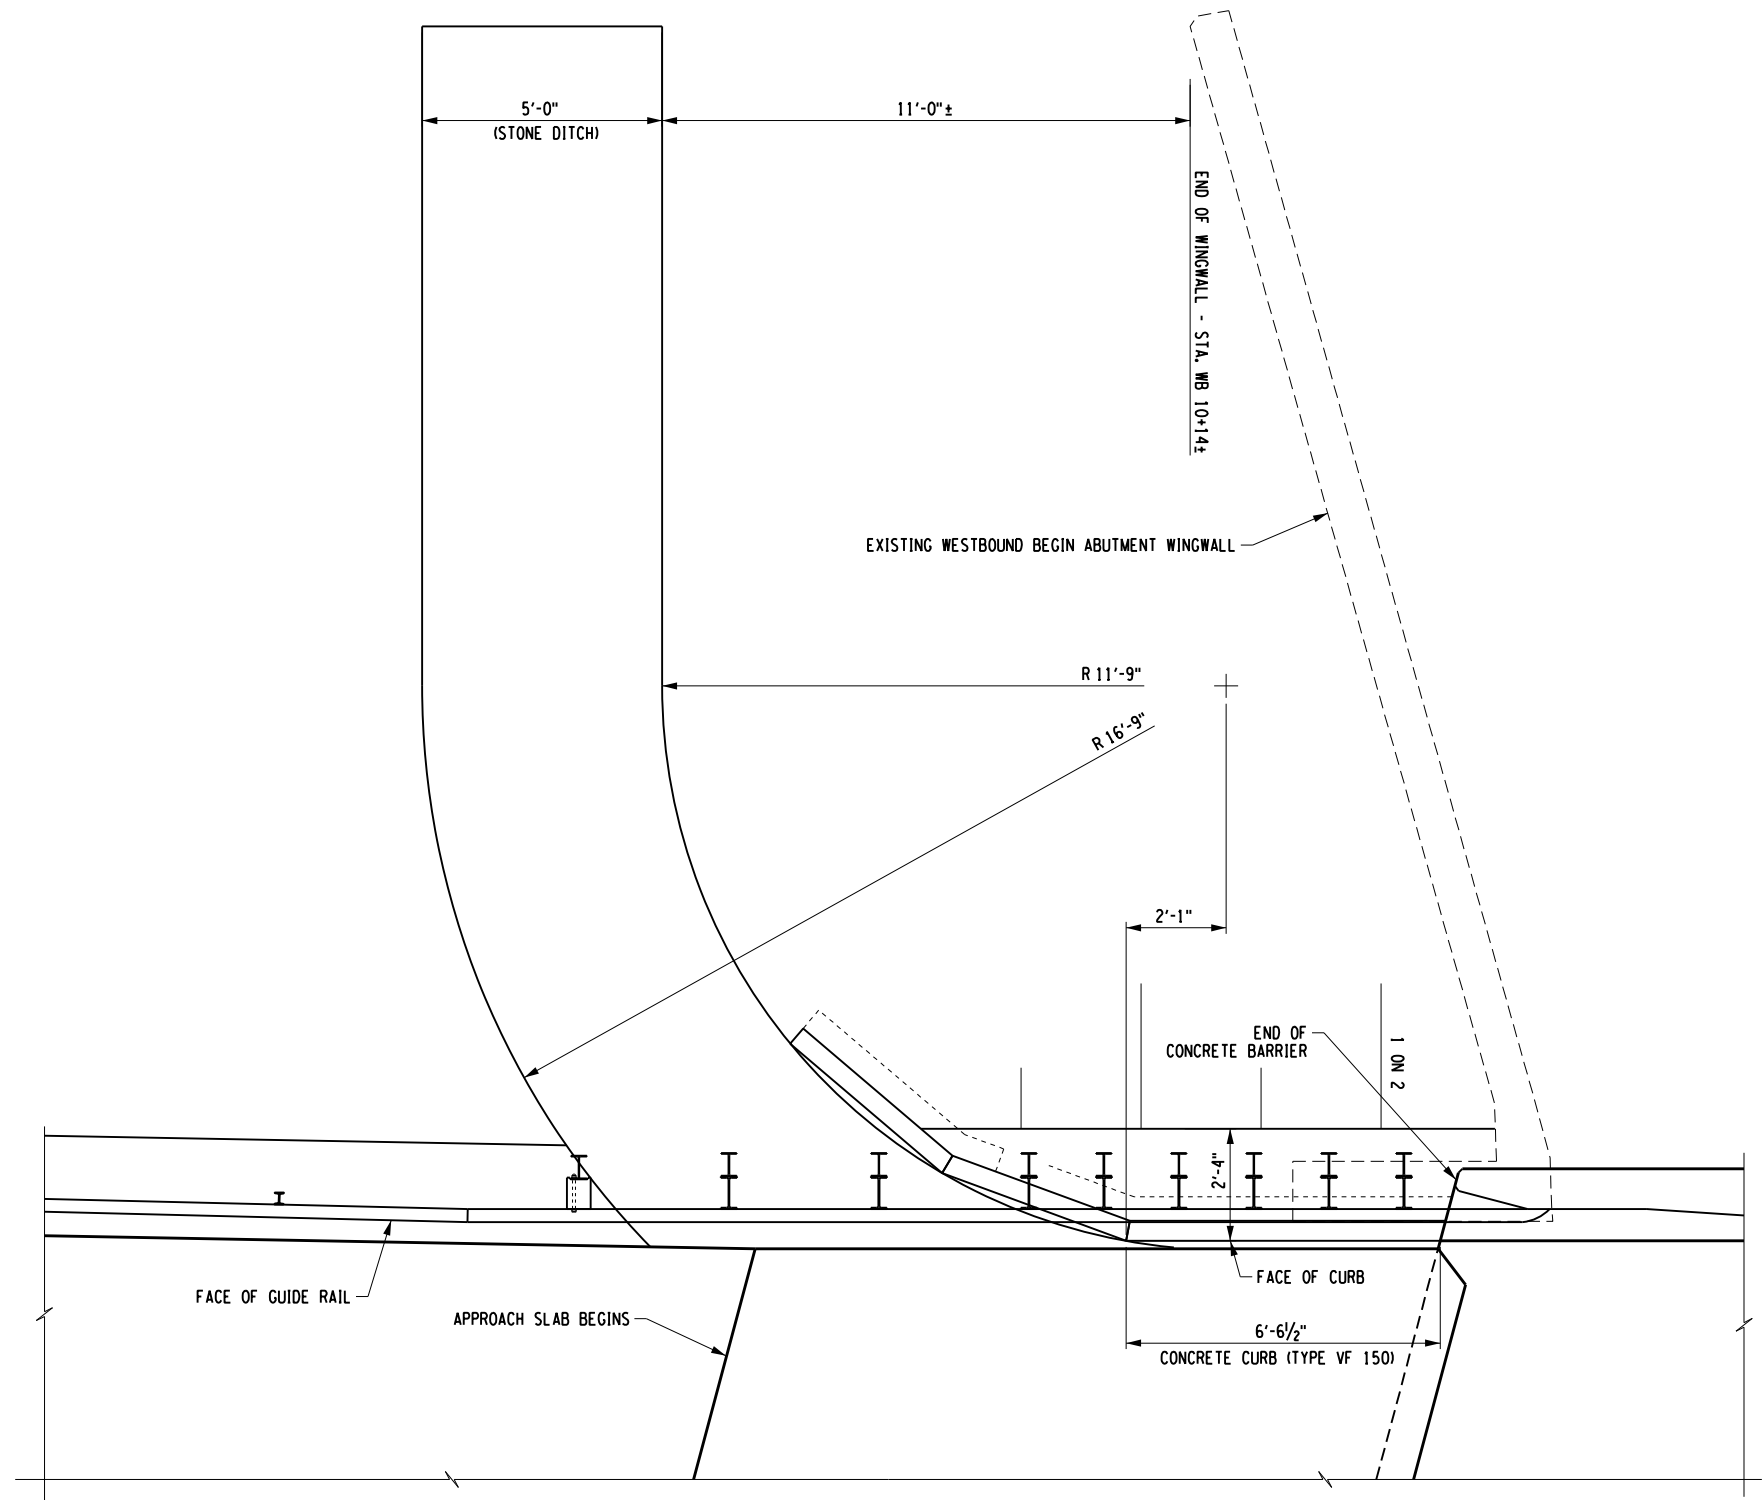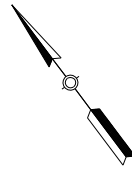

NOTES:

1. FOR CONCRETE BARRIER DETAILS, SEE DWG. NO.'S ST-34 TO ST-36.
2. FOR APPROACH DRAINAGE DETAILS, SEE DWG. NO. ST-39.
3. BRIDGE SUPERSTRUCTURE NOT SHOWN FOR CLARITY.

WESTBOUND BEGIN APPROACH DRAINAGE PLAN

SCALE: 1/4" = 1'-0"

DESIGN SUPERVISOR: C. SICHAK
 CHECKED BY: N. BARNHARD
 DRAFTED BY: T. LINDO
 CHECKED BY: N. BARNHARD

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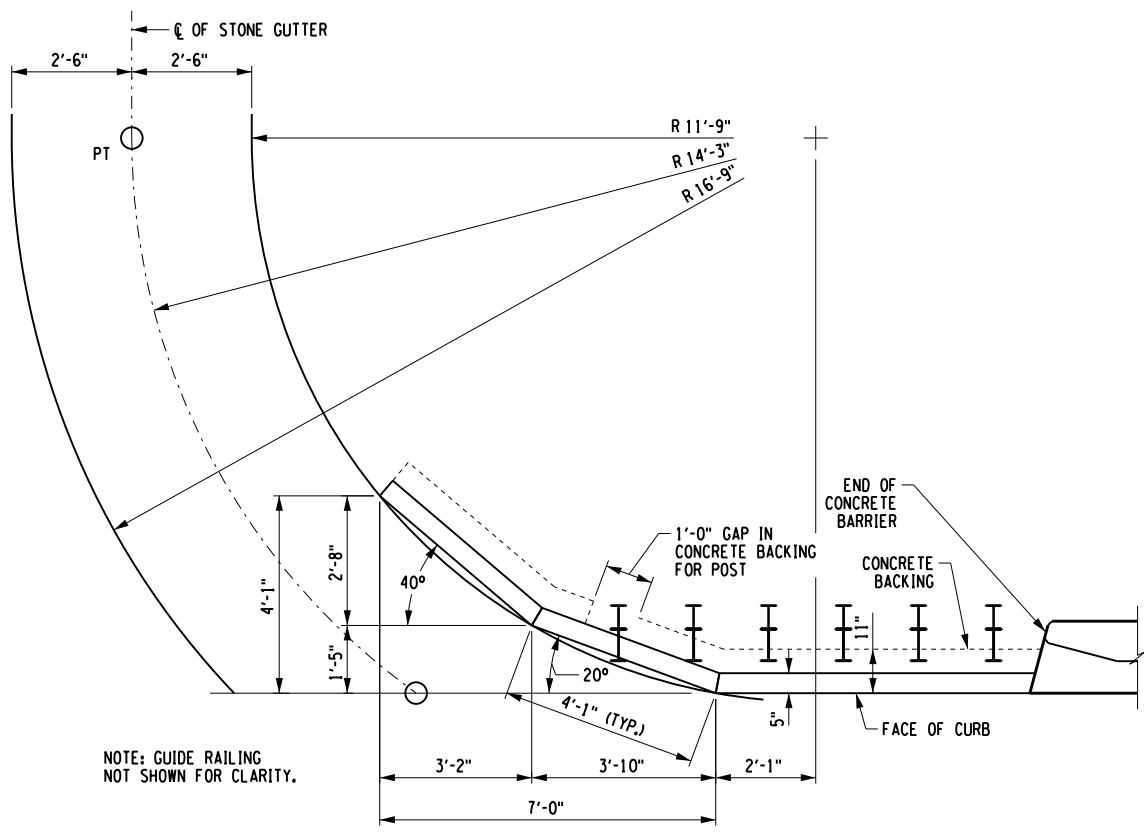
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IT IS A VIOLATION OF LAW FOR ANY PERSON, UNLESS THEY ARE ACTING UNDER THE DIRECTION OF A LICENSED PROFESSIONAL ENGINEER, ARCHITECT, LANDSCAPE ARCHITECT, OR LAND SURVEYOR, TO ALTER AN ITEM IN ANY WAY. IF AN ITEM BEARING THE STAMP OF A LICENSED PROFESSIONAL IS ALTERED, THE ALTERING ENGINEER, ARCHITECT, LANDSCAPE ARCHITECT, OR LAND SURVEYOR SHALL STAMP THE DOCUMENT AND INCLUDE THE NOTATION "ALTERED BY" FOLLOWED BY THEIR SIGNATURE. THE DATE OF SUCH ALTERATION, AND A SPECIFIC DESCRIPTION OF THE ALTERATION.




REVISIONS			
DATE	DESCRIPTION	BY	SYM.

TITLE OF PROJECT: STERLING CREEK BRIDGE REHABILITATION
 LOCATION OF PROJECT: SYRACUSE DIVISION
 BIN 5516091 & 5516092 MP 227.40 & MP 227.41
 TITLE OF DRAWING: APPROACH DRAINAGE BEGIN ABUTMENT (WESTBOUND)

CONTRACT NUMBER: TAS 24-5B
 DATE: NOV. 2023
 DRAWING NUMBER: ST-38



NOTE: GUIDE RAILING NOT SHOWN FOR CLARITY.

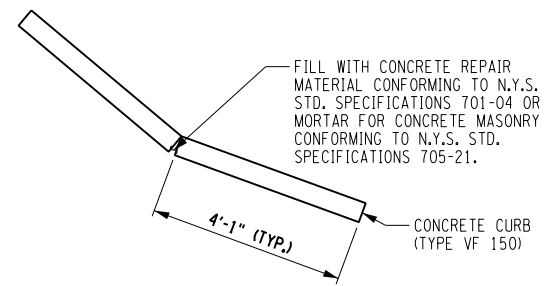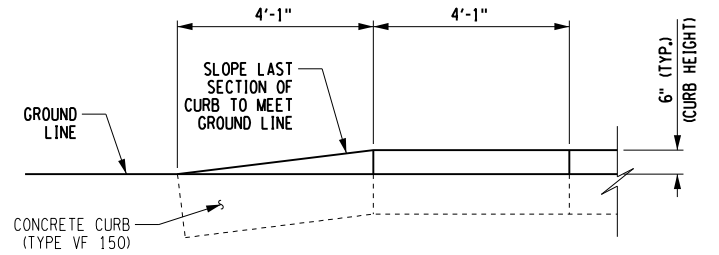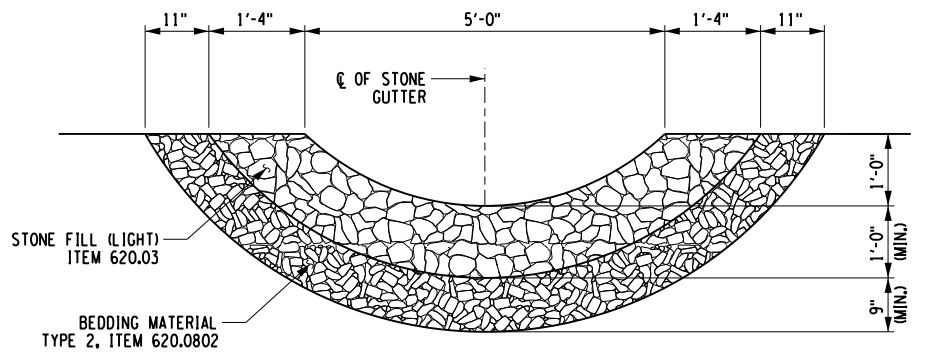

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 DRAFTED BY: T. LINDO
 CHECKED BY: N. BARNHARD
 DESIGNED BY: C. SICHAK
 DESIGN SUPERVISOR: C. SICHAK

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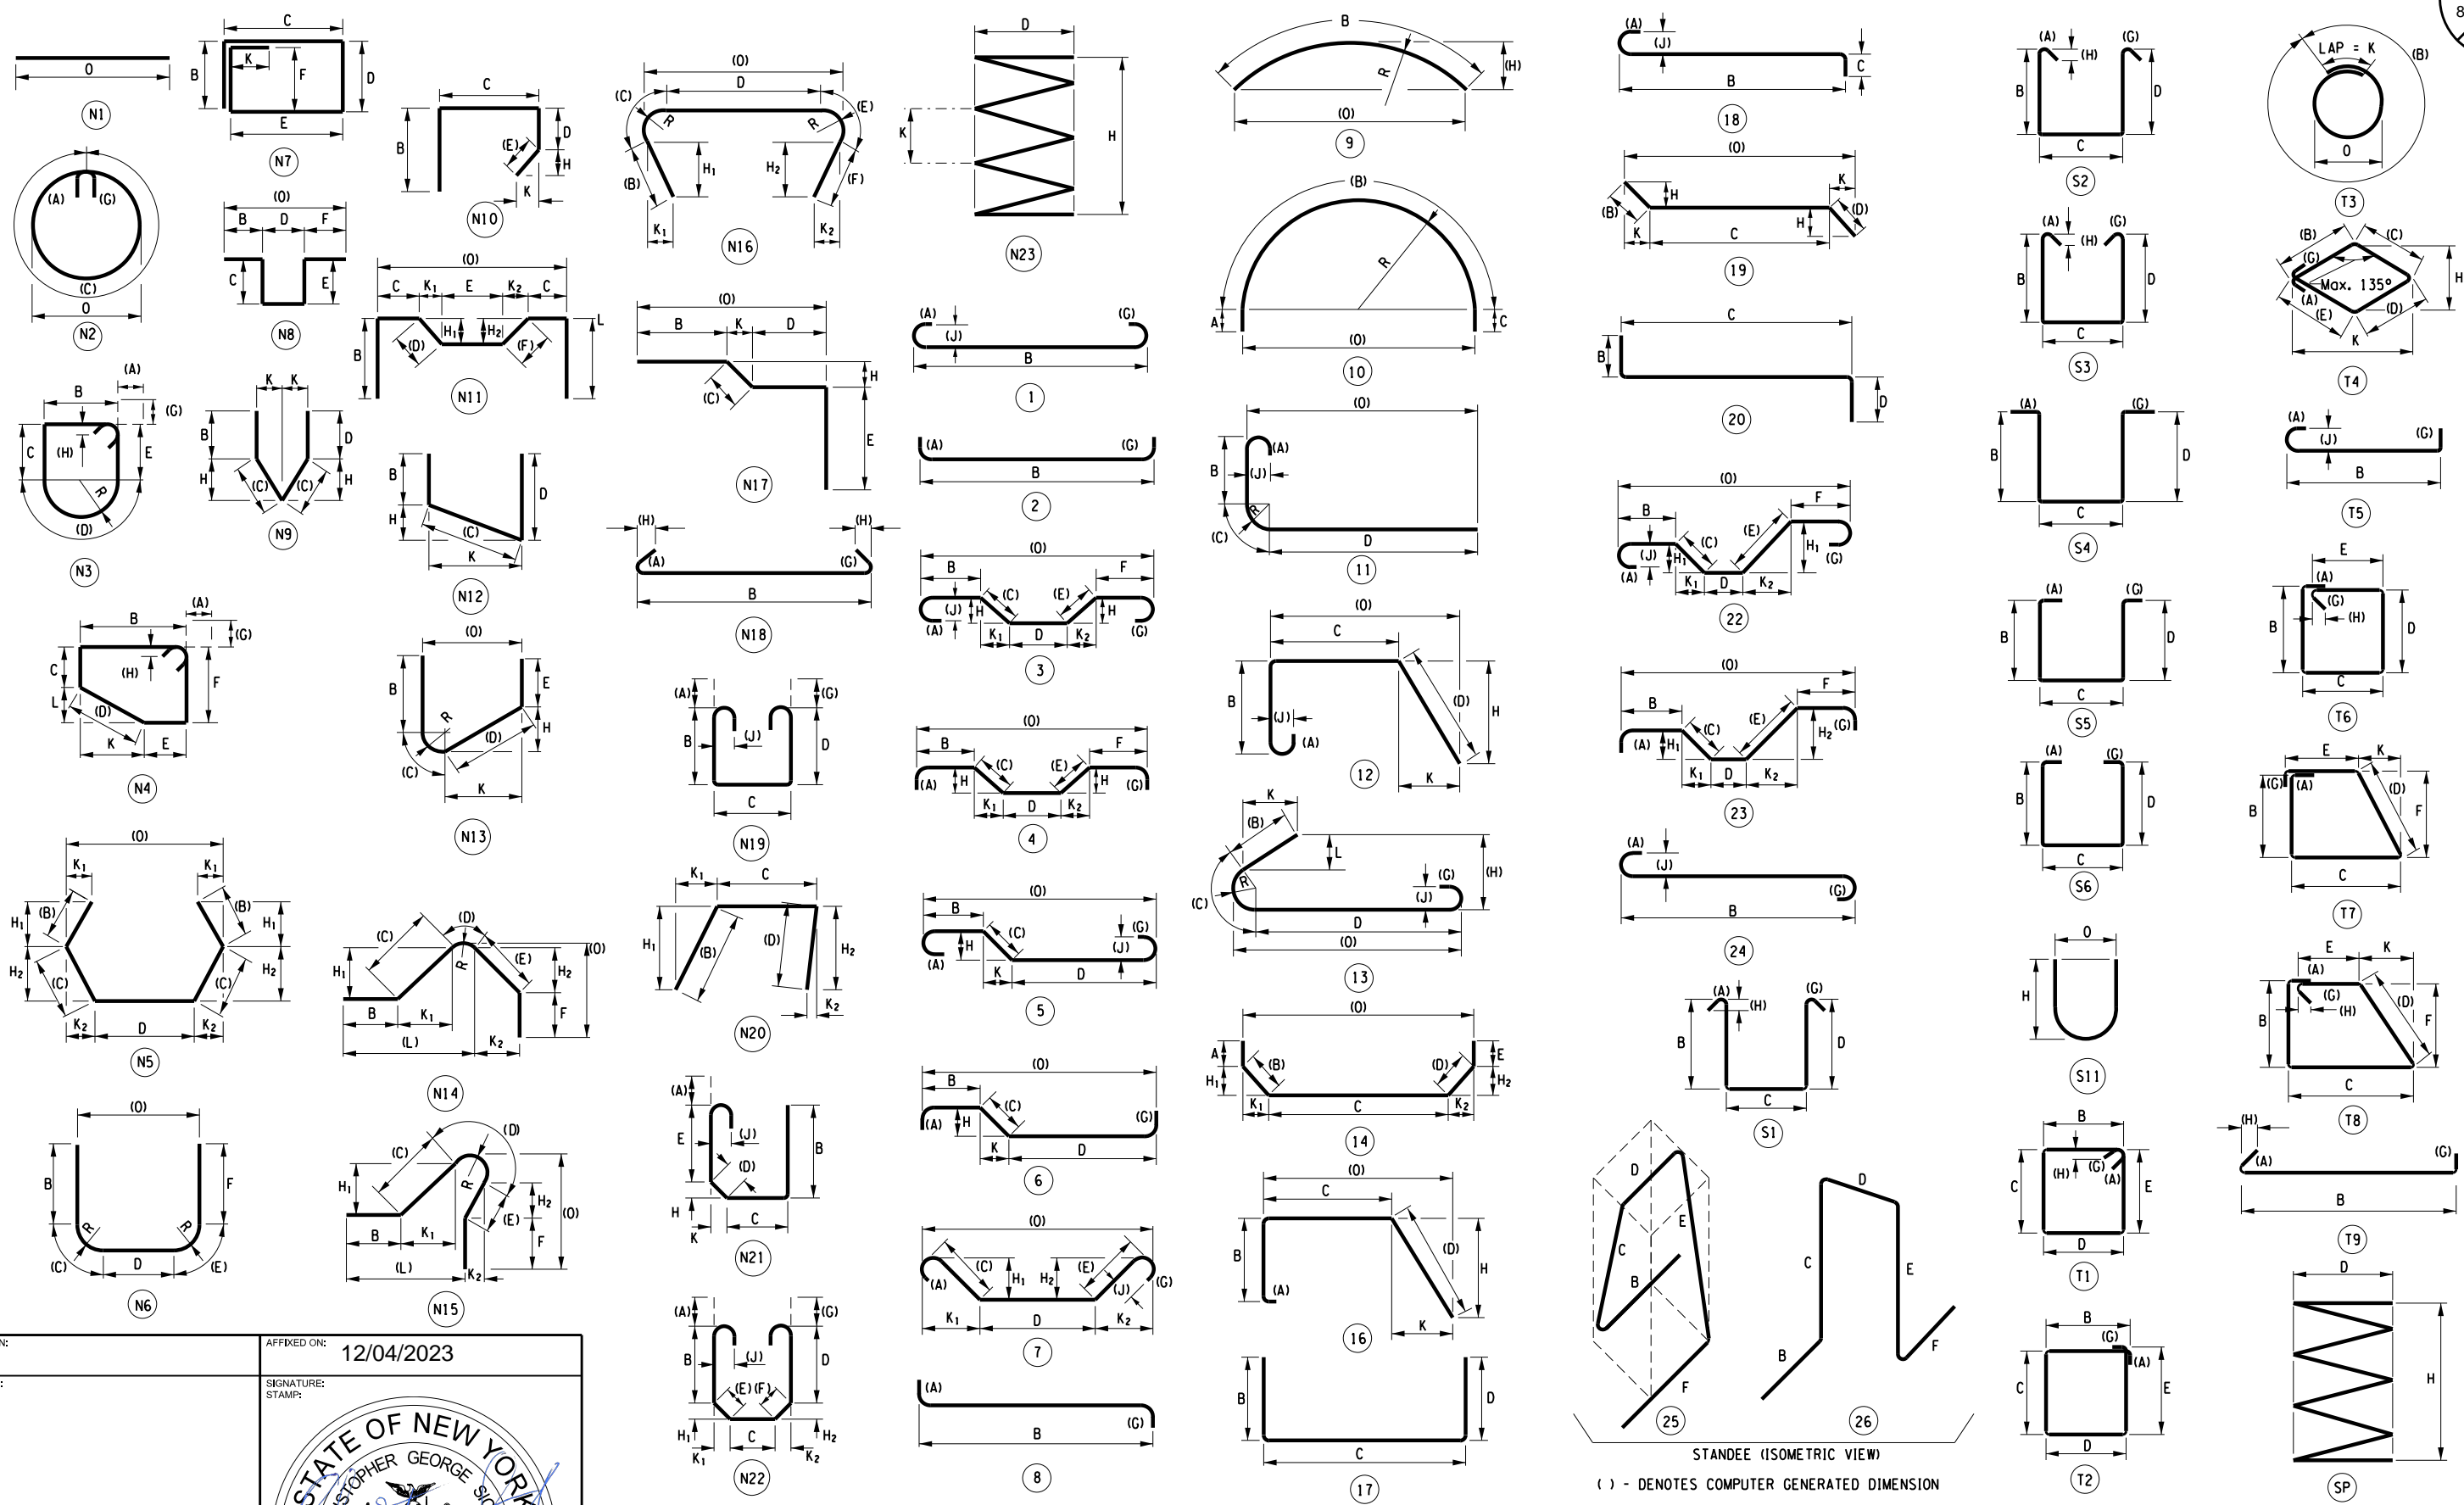
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REVISIONS			
DATE	DESCRIPTION	BY	SYMBOL

 	TITLE OF PROJECT STERLING CREEK BRIDGE REHABILITATION	CONTRACT NUMBER: TAS 24-5B
	LOCATION OF PROJECT SYRACUSE DIVISION BIN 5516091 & 5516092 MP 227.40 & MP 227.41	DATE: NOV. 2023
	TITLE OF DRAWING APPROACH DRAINAGE AND CURB LAYOUT TYPICAL DETAILS	DRAWING NUMBER: ST-39

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DESIGNED BY: C. SICHAK
 DRAFTED BY: T. LINDO
 CHECKED BY: N. BARNHARD



() - DENOTES COMPUTER GENERATED DIMENSION

ALTERED ON:	AFFIXED ON: 12/04/2023
SIGNATURE: STAMP:	SIGNATURE: STAMP:

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REVISIONS			
DATE	DESCRIPTION	BY	SYM.

 Thruway Authority 	TITLE OF PROJECT STERLING CREEK BRIDGE REHABILITATION	CONTRACT NUMBER: TAS 24-5B
	LOCATION OF PROJECT SYRACUSE DIVISION BIN 5516091 & 5516092 MP 227.40 & MP 227.41	DATE: NOV. 2023
	TITLE OF DRAWING STANDARD BARBEND DETAILS	DRAWING NUMBER: ST-40

MARK	NO.	LENGTH	TYPE	WEIGHT	A	B	C	D	E	F	G	H H1	H2	J	K K1	K2	L	O	R
EASTBOUND BEGIN ABUTMENT																			
PLACEMENT 1																			
AVG. AVG.																			
5AG01	38	7' - 2 1/2"	16	285.4	0' - 0"	0' - 0"	4' - 5 1/2"	2' - 9"				1' - 9"			1' - 9"				
LENGTH C VARIES FROM					4' - 1 3/4"		TO	4' - 9"											
AVG.																			
5AG02	38	6' - 3 1/2"	N1	249.3														6' - 3 1/2"	
LENGTH O VARIES FROM					5' - 0"		TO	6' - 7"											
5AG03	38	6' - 10 3/4"	17	273.0		2' - 1"	2' - 1 1/2"	2' - 8"											
8AG04	6	55' - 5 1/4"	N1	888.2														55' - 5 1/4"	
SUBTOTAL EPOXY BARS				1695.9	LBS THIS POUR														
PLACEMENT 2																			
5AG05	8	59' - 2"	N1	493.7														59' - 2"	
5AG06	41	3' - 2"	17	135.4		1' - 0"	1' - 2"	1' - 0"											
5AG07	4	5' - 10 1/4"	N12	24.4		2' - 9"	3' - 1 1/4"	0' - 0"											
5AG08	4	4' - 7 3/4"	N12	19.4		2' - 9"	1' - 10 3/4"	0' - 0"											
5AG11	6	6' - 7"	N1	41.1														6' - 7"	
SUBTOTAL EPOXY BARS				714.1	LBS THIS POUR														
PLACEMENT 3																			
5AG12	8	2' - 4 1/4"	17	19.6		0' - 6"	1' - 10 1/4"	0' - 0"											
5AG13	8	2' - 5 3/4"	17	20.8		0' - 6"	1' - 11 3/4"	0' - 0"											
5AG14	8	2' - 7 1/2"	17	21.9		0' - 6"	2' - 1 1/2"	0' - 0"											
5AG15	8	2' - 9"	17	22.9		0' - 6"	2' - 3"	0' - 0"											
5AG16	8	2' - 10 1/4"	17	23.8		0' - 6"	2' - 4 1/4"	0' - 0"											
5AG17	8	2' - 9 3/4"	17	23.5		0' - 6"	2' - 3 3/4"	0' - 0"											
5AG18	8	2' - 8 1/4"	17	22.4		0' - 6"	2' - 2 1/4"	0' - 0"											
5AG19	8	2' - 5 3/4"	17	20.7		0' - 6"	1' - 11 3/4"	0' - 0"											
5AG20	15	10' - 0"	T1	156.5	0' - 5 1/2"	2' - 7"	1' - 11 1/2"	2' - 7"	1' - 11 1/2"		0' - 5 1/2"	0' - 3 3/4"							
SUBTOTAL EPOXY BARS				332.1	LBS THIS POUR														
EASTBOUND END ABUTMENT																			
PLACEMENT 1																			
AVG. AVG.																			
5AG01	38	7' - 9 3/4"	16	309.3	0' - 0"	0' - 0"	5' - 0 3/4"	2' - 9"				1' - 9"			1' - 9"				
LENGTH C VARIES FROM					4' - 9"		TO	5' - 4 1/4"											
AVG.																			
5AG02	38	6' - 9 1/2"	N1	269.1		6' - 6"		7' - 1"											
LENGTH O VARIES FROM					6' - 6"		TO	7' - 1"											
5AG03	38	7' - 10 1/4"	17	311.1		2' - 6 3/4"	2' - 1 1/2"	3' - 1 3/4"											
8AG04	6	55' - 5 1/4"	N1	888.2														55' - 5 1/4"	
SUBTOTAL EPOXY BARS				1777.6	LBS THIS POUR														
PLACEMENT 2																			
5AG05	8	59' - 2"	N1	493.7														59' - 2"	
5AG06	41	3' - 2"	17	135.4		1' - 0"	1' - 2"	1' - 0"											
5AG09	4	5' - 10 1/4"	N12	24.4		0' - 0"	3' - 1 1/4"	2' - 9"											
5AG10	4	4' - 7 3/4"	N12	19.4		0' - 0"	1' - 10 3/4"	2' - 9"				0' - 6"			1' - 10"				
5AG11	6	7' - 1"	N1	44.3														7' - 1"	
SUBTOTAL EPOXY BARS				717.2	LBS THIS POUR														
PLACEMENT 3																			
5AG12	8	2' - 4 1/4"	17	19.6		0' - 6"	1' - 10 1/4"	0' - 0"											
5AG13	8	2' - 5 3/4"	17	20.8		0' - 6"	1' - 11 3/4"	0' - 0"											
5AG14	8	2' - 7 1/2"	17	21.9		0' - 6"	2' - 1 1/2"	0' - 0"											
5AG15	8	2' - 9"	17	22.9		0' - 6"	2' - 3"	0' - 0"											
5AG16	8	2' - 10 1/4"	17	23.8		0' - 6"	2' - 4 1/4"	0' - 0"											
5AG17	8	2' - 9 3/4"	17	23.5		0' - 6"	2' - 3 3/4"	0' - 0"											

MARK	NO.	LENGTH	TYPE	WEIGHT	A	B	C	D	E	F	G	H H1	H2	J	K K1	K2	L	O	R	
EASTBOUND END ABUTMENT CONT.																				
5AG18	8	2' - 8 1/4"	17	22.4		0' - 6"	2' - 2 1/4"	0' - 0"												
5AG19	8	2' - 5 3/4"	17	20.7		0' - 6"	1' - 11 3/4"	0' - 0"												
5AG20	15	10' - 0"	T1	156.5	0' - 5 1/2"	2' - 7"	1' - 11 1/2"	2' - 7"	1' - 11 1/2"		0' - 5 1/2"	0' - 3 3/4"								
SUBTOTAL EPOXY BARS				332.1	LBS THIS POUR															
EASTBOUND SUPERSTRUCTURE SLAB																				
4SG01	132	57' - 9 3/4"	N1	5097.9															57' - 9 3/4"	
4SG02	160	60' - 0"	N1	6412.8															60' - 0"	
4SG03	160	26' - 4 1/4"	N1	2815.9															26' - 4 1/4"	
5SG04	12	60' - 0"	N1	751.0															60' - 0"	
5SG05	12	28' - 3 1/4"	N1	353.7															28' - 3 1/4"	
4SG06	132	7' - 6 1/2"	1	665.0	0' - 6"	7' - 0 1/2"					0' - 0"				0' - 4"					
4SG07	132	51' - 3 1/2"	1	4522.7	0' - 6"	50' - 9 1/2"					0' - 0"				0' - 4"					
6SG08	264	5' - 10 1/2"	1	2329.6	0' - 8"	5' - 2 1/2"					0' - 0"				0' - 6"					
5SG09	242	2' - 10"	N1	715.2															2' - 10"	
6SG10	178	4' - 5"	19	1180.8	1' - 0"	3' - 5"	0' - 0"				0' - 11 3/4"	0' - 0"		0' - 2 1/4"	0' - 0"		3' - 7 1/4"			
AVG.							AVG.				AVG.			AVG.				AVG.		
6SG11	64	4' - 5"	19	424.6		1' - 0"	3' - 5"	0' - 0"			0' - 11 3/4"	0' - 0"		0' - 1"	0' - 0"		3' - 6"			
LENGTH H VARIES FROM					0' - 11 3/4"		TO	1' - 0"												
LENGTH K VARIES FROM					0' - 0"		TO	0' - 2 1/4"												
7SG12	20	5' - 8 3/4"	14	234.6	2' - 8 1/2"	0' - 6 1/4"	2' - 6"	0' - 0"	0' - 0"			0' - 4 1/2"	0' - 0"		0' - 4 1/2"	0' - 0"				
5SG13	20	6' - 5 1/2"	S11	134.6															6' - 5 1/2"	
5SG14	20	3' - 8 1/2"	1	77.4	0' - 7"	3' - 1 1/2"									0' - 5"					
4SG15	166	7' - 0"	1	776.2	0' - 6"	6' - 0"					0' - 6"				0' - 4"					
4SG16	8	3' - 5 1/4"	16	18.4	0' - 0"	0' - 0"	1' - 5"	2' - 0 1/4"				1' - 5 1/4"			1' - 5 1/4"			2' - 10 1/4"		
4SG17	14	3' - 2 1/2"	N8	30.0		0' - 9"	0' - 4"	1' - 0 1/2"	0' - 4"	0' - 9"								2' - 6 1/2"		
SUBTOTAL EPOXY BARS				26540.3	LBS THIS POUR															
EASTBOUND BEGIN APPROACH SLAB																				
5HG01	166	14' - 6"	N1	2510.5															14' - 6"	
5HG02	32	54' - 2 1/4"	N1	1808.9															54' - 2 1/4"	
5HG03	8	4' - 9"	N11	39.6		0' - 0"	0' - 0"	2' - 0"	0' - 9"	2' - 0"		1' - 5"	1' - 5"		0' - 0"	1' - 5"	0' - 0"	3' - 7"		
SUBTOTAL EPOXY BARS				4369.0	LBS THIS POUR															
EASTBOUND END APPROACH SLAB																				
5HG01	166	14' - 6"	N1	2510.5															14' - 6"	
5HG02	32	54' - 2 1/4"	N1	1808.9															54' - 2 1/4"	
5HG03	8	4' - 9"	N11	39.6		0' - 0"	0' - 0"	2' - 0"	0' - 9"	2' - 0"		1' - 5"	1' - 5"		0' - 0"	1' - 5"	0' - 0"	3' - 7"		
SUBTOTAL EPOXY BARS				4369.0	LBS THIS POUR															
EASTBOUND SLEEPER SLAB																				
5HG11	112	5' - 6"	N1	642.5															5' - 6"	
5HG12	17	54' - 2 1/4"	N1	961.0															54' - 2 1/4"	
5HG13	56	4' - 6"	17	262.8		1' - 6"	1' - 6"	1' - 6"												
SUBTOTAL EPOXY BARS				1866.3	LBS THIS POUR															
EASTBOUND BARRIER																				
7BG01	24	60' - 0"	N1	2943.4															60' - 0"	
7BG02	24	29' - 2 1/4"	N1	1431.5															29' - 2 1/4"	
5BG03	178	6' - 5 3/4"	13	1202.9		2' - 11 1/4"	0' - 8 3/4"	2' - 9 3/4"			0' - 0"	1' - 1 1/2"	0' - 0"	2' - 10 1/2"	0' - 7 1/2"	3' - 0 3/4"	0' - 0"	0' - 3"		
AVG.						AVG.		AVG.			AVG.		AVG.		AVG.		AVG.		AVG.	
5BG04	64	6' - 5 1/4"	13	429.7		2' - 10 1/2"	0' - 9"	2' - 9 3/4"			0' - 0"	0' - 5 3/4"	0' - 0"	2' - 10"	0' - 3 3/4"	3' - 0 3/4"	0' - 3"			
LENGTH K VARIES FROM					2' - 9 3/4"		TO	2' - 10 1/2"												
LENGTH L VARIES FROM					0' - 0"		TO	0' - 7 1/2"												
5BG05	20	5' - 1 1/2"	S11	106.8							2' - 2"							0' - 6"		
SUBTOTAL EPOXY BARS				6114.2	LBS THIS POUR															

ALTERED ON: _____ AFFIXED ON: 12/04/2023

SIGNATURE: _____ SIGNATURE: _____
 STAMP: _____ STAMP: _____

IT IS A VIOLATION OF LAW FOR ANY PERSON, UNLESS THEY ARE ACTING UNDER THE DIRECTION OF A LICENSED PROFESSIONAL ENGINEER, ARCHITECT, LANDSCAPE ARCHITECT, OR LAND SURVEYOR, TO ALTER AN ITEM IN ANY WAY. IF AN ITEM BEARING THE STAMP OF A LICENSED PROFESSIONAL IS ALTERED, THE ALTERING ENGINEER, ARCHITECT, LANDSCAPE ARCHITECT, OR LAND SURVEYOR SHALL STAMP THE DOCUMENT AND INCLUDE THE NOTATION "ALTERED BY" FOLLOWED BY THEIR SIGNATURE. THE DATE OF SUCH ALTERATION, AND A SPECIFIC DESCRIPTION OF THE ALTERATION.

REVISIONS			
DATE	DESCRIPTION	BY	SYM.

Thruway Authority

TITLE OF PROJECT: STERLING CREEK BRIDGE REHABILITATION
 LOCATION OF PROJECT: SYRACUSE DIVISION
 BIN 5516091 & 5516092 MP 227.40 & MP 227.41
 TITLE OF DRAWING: BAR LIST (1 OF 2)

CONTRACT NUMBER: TAS 24-5B
 DATE: NOV. 2023
 DRAWING NUMBER: ST-41

MARK	NO.	LENGTH	TYPE	WEIGHT	A	B	C	D	E	F	G	H H1	H2	J	K K1	K2	L	O	R
WESTBOUND END ABUTMENT CONT.																			
5AG18	8	2'-8"	17	22.3		0'-6"	2'-2"	0'-0"											
5AG19	8	2'-6"	17	20.9		0'-6"	2'-0"	0'-0"											
5AG20	23	10'-0"	T1	239.9	0'-5 1/2"	2'-7"	1'-11 1/2"	2'-7"	1'-11 1/2"		0'-5 1/2"	0'-3 3/4"							
SUBTOTAL EPOXY BARS				431.9	LBS THIS POUR														
WESTBOUND SUPERSTRUCTURE SLAB																			
4SG01	132	57'-9 3/4"	N1	5097.9															57'-9 3/4"
4SG02	160	60'-0"	N1	6412.8															60'-0"
4SG03	160	26'-4 1/4"	N1	2815.9															26'-4 1/4"
5SG04	12	60'-0"	N1	751.0															60'-0"
5SG05	12	28'-3 1/4"	N1	353.7															28'-3 1/4"
4SG06	132	7'-6 1/2"	1	665.0	0'-6"	7'-0 1/2"					0'-0"								0'-4"
4SG07	132	51'-3 1/2"	1	4522.7	0'-6"	50'-9 1/2"					0'-0"								0'-4"
6SG08	264	5'-10 1/2"	1	2329.6	0'-8"	5'-2 1/2"					0'-0"								0'-6"
5SG09	242	2'-10"	N1	715.2															2'-10"
6SG10	178	4'-5"	19	1180.8	1'-0"	3'-5"	0'-0"				0'-11 3/4"	0'-0"		0'-2 1/4"	0'-0"			3'-7 1/4"	
AVG.											AVG.			AVG.					AVG.
6SG11	64	4'-5"	19	424.6	1'-0"	3'-5"	0'-0"				0'-11 3/4"	0'-0"		0'-1"	0'-0"			3'-6"	
LENGTH H VARIES FROM					0'-11 3/4"		TO		1'-0"										
LENGTH K VARIES FROM					0'-0"		TO		0'-2 1/4"										
7SG12	20	5'-8 3/4"	14	234.6	2'-8 1/2"	0'-6 1/4"	2'-6"	0'-0"	0'-0"		0'-4 1/2"	0'-0"		0'-4 1/2"	0'-0"				0'-6"
5SG13	20	6'-5 1/2"	S11	134.6							2'-10"								
5SG14	20	3'-8 1/2"	1	77.4	0'-7"	3'-1 1/2"								0'-5"					
4SG15	166	7'-0"	1	776.2	0'-6"	6'-0"					0'-6"			0'-4"					
4SG16	8	3'-5 1/4"	16	18.4	0'-0"	0'-0"	1'-5"	2'-0 1/4"			1'-5 1/4"			1'-5 1/4"					2'-10 1/4"
4SG17	19	3'-2 1/2"	N8	40.7			0'-9"	0'-4"	1'-0 1/2"	0'-4"	0'-9"								2'-6 1/2"
SUBTOTAL EPOXY BARS				26551.0	LBS THIS POUR														
WESTBOUND BEGIN APPROACH SLAB																			
5HG01	166	14'-6"	N1	2510.5															14'-6"
5HG02	32	54'-2 1/4"	N1	1808.9															54'-2 1/4"
5HG03	8	4'-9"	N11	39.6		0'-0"	0'-0"	2'-0"	0'-9"	2'-0"	1'-5"	1'-5"		0'-0"	1'-5"	0'-0"		3'-7"	
SUBTOTAL EPOXY BARS				4359.0	LBS THIS POUR														
WESTBOUND END APPROACH SLAB																			
5HG01	166	14'-6"	N1	2510.5															14'-6"
5HG02	32	54'-2 1/4"	N1	1808.9															54'-2 1/4"
5HG03	8	4'-9"	N11	39.6		0'-0"	0'-0"	2'-0"	0'-9"	2'-0"	1'-5"	1'-5"		0'-0"	1'-5"	0'-0"		3'-7"	
SUBTOTAL EPOXY BARS				4359.0	LBS THIS POUR														
WESTBOUND SLEEPER SLAB																			
5HG11	112	5'-6"	N1	642.5															5'-6"
5HG12	17	54'-2 1/4"	N1	961.0															54'-2 1/4"
5HG13	56	4'-6"	17	262.8		1'-6"	1'-6"	1'-6"											
SUBTOTAL EPOXY BARS				1866.3	LBS THIS POUR														
WESTBOUND BARRIER																			
7BG01	24	60'-0"	N1	2943.4															60'-0"
7BG02	24	29'-2 1/4"	N1	1431.5															29'-2 1/4"
5BG03	178	6'-5 3/4"	13	1202.9		2'-11 1/4"	0'-8 3/4"	2'-9 3/4"			0'-0"	1'-1 1/2"	0'-0"	2'-10 1/2"	0'-7 1/2"	3'-0 3/4"	0'-3"		
AVG.						AVG.	AVG.	AVG.			AVG.		AVG.	AVG.	AVG.	AVG.			
5BG04	64	6'-5 1/4"	13	429.7	2'-9 3/4"	2'-10 1/2"	0'-9"	2'-9 3/4"			0'-0"	0'-5 3/4"	0'-0"	2'-10"	0'-3 3/4"	3'-0 3/4"	0'-3"		
LENGTH K VARIES FROM					2'-9 3/4"		TO		2'-10 1/2"										
LENGTH L VARIES FROM					0'-0"		TO		0'-7 1/2"										
5BG05	20	5'-1 1/2"	S11	106.8							2'-2"								0'-6"
SUBTOTAL EPOXY BARS				6114.2	LBS THIS POUR														

MARK	NO.	LENGTH	TYPE	WEIGHT	A	B	C	D	E	F	G	H H1	H2	J	K K1	K2	L	O	R		
WESTBOUND BEGIN ABUTMENT																					
PLACEMENT 1																					
AVG.						AVG.															
5AG01	38	7'-5"	16	293.9	0'-0"	0'-0"	4'-8"	2'-9"				1'-9"			1'-9"						
LENGTH C VARIES FROM					4'-3 3/4"		TO		5'-0 1/4"												
AVG.				6'-6"																	
5AG02	38	6'-6"	N1	257.8																	
LENGTH O VARIES FROM					6'-1 3/4"		TO		6'-10 1/4"												
5AG03	38	6'-10 3/4"	17	273.0		2'-1"	2'-1 1/2"	2'-8"													
8AG04	6	55'-5 1/4"	N1	888.2															55'-5 1/4"		
SUBTOTAL EPOXY BARS				1712.9	LBS THIS POUR																
PLACEMENT 2																					
5AG05	8	59'-2"	N1	493.7															59'-2"		
5AG06	41	3'-2"	17	135.4		1'-0"	1'-2"	1'-0"													
5AG09	4	5'-10 1/4"	N12	24.4		0'-0"	3'-1 1/4"	2'-9"			0'-9 3/4"				3'-0"						
5AG10	4	4'-7 3/4"	N12	19.4		0'-0"	1'-10 3/4"	2'-9"			0'-6"				1'-10"						
5AG11	6	6'-8 3/4"	N1	42.1															6'-8 3/4"		
SUBTOTAL EPOXY BARS				715.1	LBS THIS POUR																
PLACEMENT 3																					
5AG12	8	2'-9 3/4"	17	23.4		0'-6"	2'-3 3/4"	0'-0"													
5AG13	8	2'-0"	17	25.0		0'-6"	2'-6"	0'-0"													
5AG14	8	3'-1 1/4"	17	25.9		0'-6"	2'-7 1/4"	0'-0"													
5AG15	8	3'-1 1/4"	17	25.9		0'-6"	2'-7 1/4"	0'-0"													
5AG16	8	2'-11 3/4"	17	24.9		0'-6"	2'-5 3/4"	0'-0"													
5AG17	8	2'-10"	17	23.7		0'-6"	2'-4"	0'-0"													
5AG18	8	2'-8"	17	22.3		0'-6"	2'-2"	0'-0"													
5AG19	8	2'-6"	17	20.9		0'-6"	2'-0"	0'-0"													
5AG20	23	10'-0"	T1	239.9	0'-5 1/2"	2'-7"	1'-11 1/2"	2'-7"	1'-11 1/2"		0'-5 1/2"	0'-3 3/4"									
SUBTOTAL EPOXY BARS				431.9	LBS THIS POUR																
WESTBOUND END ABUTMENT																					
PLACEMENT 1																					
AVG.						AVG.															
5AG01	38	8'-0 1/4"	16	317.8	0'-0"	0'-0"	5'-3 1/4"	2'-9"				1'-9"			1'-9"						
LENGTH C VARIES FROM					4'-11"		TO		5'-7 1/2"												
AVG.				7'-0"																	
5AG02	38	7'-0"	N1	277.6																	
LENGTH O VARIES FROM					6'-7 3/4"		TO		7'-4 1/4"												
5AG03	38	7'-10 1/4"	17	311.1		2'-6 3/4"	2'-1 1/2"	3'-1 3/4"													
8AG04	6	55'-5 1/4"	N1	888.2															55'-5 1/4"		
SUBTOTAL EPOXY BARS				1794.7	LBS THIS POUR																
PLACEMENT 2																					
5AG05	8	59'-2"	N1	493.7															59'-2"		
5AG06	41	3'-2"	17	135.4		1'-0"	1'-2"	1'-0"													
5AG07	4	5'-10 1/4"	N12	24.4		2'-9"	3'-1 1/4"	0'-0"			0'-9 3/4"				3'-0"						
5AG08	4	4'-7 3/4"	N12	19.4		2'-9"	1'-10 3/4"	0'-0"			0'-6"				1'-10"						
5AG11	6	7'-2 3/4"	N1	45.3															7'-2 3/4"		
SUBTOTAL EPOXY BARS				718.2	LBS THIS POUR																
PLACEMENT 3																					
5AG12	8	2'-9 3/4"	17	23.4		0'-6"	2'-3 3/4"	0'-0"													
5AG13	8	2'-0"	17	25.0		0'-6"	2'-6"	0'-0"													
5AG14	8	3'-1 1/4"	17	25.9		0'-6"	2'-7 1/4"	0'-0"													
5AG15	8	3'-1 1/4"	17	25.9		0'-6"	2'-7 1/4"	0'-0"													
5AG16	8	2'-11 3/4"	17	24.9		0'-6"	2'-5 3/4"	0'-0"													
5AG17	8	2'-10"	17	23.7		0'-6"	2'-4"	0'-0"													

ALTERED ON: 12/04/2023

AFFIXED ON: 12/04/2023

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